

General Demolition Notes:

1. ALL DASHED WALLS ARE TO BE REMOVED AS INDICATED PER LEGEND. DOORS WITHIN WALLS TO BE REMOVED SHALL BE REMOVED INCLUDING ALL ASSOCIATED TRIMS AND HARDWARE UNLESS SPECIFICALLY INDICATED TO BE SALVAGED.

2. "SAFE-OFF" M.P.E. SYSTEMS BY QUALIFIED MECHANICAL, PLUMBING, AND ELECTRICAL CONTRACTOR, AS REQUIRED.

3. ALL DAMAGE TO FINISH SURFACES AND ALL THROUGH-SLAB OR WALL PENETRATIONS THAT REMAIN FOLLOWING THE DEMOLITION OF EXISTING WALLS SHALL BE NOTED BY CONTRACTOR FOR REPAIR AND SEALING DURING RENOVATION.

4. ALL DOORS AND HARDWARE ARE TO REMAIN IN PLACE AND PROTECTED UNLESS OTHERWISE INDICATED.

5. REMOVE MISCELLANEOUS WALL-MOUNTED ITEMS WITHIN THE WORK AREA, INCLUDING TACK BOARDS, WHITE BOARDS, CLOCKS. COORDINATE STORAGE AND REINSTALLATION W/ OWNER, UNLESS OTHERWISE NOTED.

6. ALL SPRINKLER HEAD LOCATIONS ARE APPROXIMATE AND REQUIRE FIELD VERIFICATION FOR THEIR EXACT LOCATION.

Demolition Legend:

	WALL TO BE DEMOLISHED
	ELEMENT TO BE DEMOLISHED
	WALL TO REMAIN
	ELEMENT TO REMAIN
R	RELOCATED ELEMENT
	NOT IN CONTRACT

Demolition Keynotes:

Den	nolition Keynotes:
Α	REMOVE EXISTING FLOOR FINISH AND ASSOCIATED WALL BASE. PREPARE EXISTING SLAB TO RECEIVE NEW FLOOR FINISH.
В	REMOVE PORTION OF EXISTING WALL TO ALLOW INSTALLATION OF NEW DOOR DURING NEW PHASE. CUT OPENING AT BLOCK COURSING DIMENSIONS IF POSSIBLE. REFER TO STRUCTURAL DWGS.
С	REMOVE EXISTING SINK / BASIN. CAP PLUMBING LINES AS REQUIRED. SEE PLUMBING DWGS.
D	REMOVE EXISTING COUNTERTOP, BASE CABINETRY, WALL CABINETRY, SHELVING, ETC.
E	EXISTING UPS CONSOLE, BATTERY CONSOLE, SERVER, TRANSFORMER AND BYPASS TO REMAIN. CONTRACTOR TO COORDINATE PROTECTION OR REMOVAL AND REINSTALLATION WITH OWNER.
F	EXISTING RAIN LEADER TO REMAIN. COORDINATE W/ PLUMBING DWGS.
G	REMOVE EXISTING CEILING GRID AND TILES. REMOVE ALL ASSOCIATED LIGHT FIXTURES, HVAC DIFFUSERS AND RETURNS, SENSORS, ETC.
Н	SALVAGE BASE CABINET FOR REUSE. REFER TO NEW PLAN.
Ι	REMOVAL OF ALL GAS DEWARS AND CYLINDERS BY OWNER.
J	RELOCATE CHEMICAL STORAGE CABINET BY OWNER.
К	REMOVE SPRINKLER HEAD - TYPICAL OF ALL SPRINKLER HEADS IN BSIR SUITE, CORRIDOR TO BECOME PART OF THE BSIR SUITE, AND IN PORTION OF WET LAB TO BECOME THE TITAN UPS ROOM.
L	EXISTING SPRINKLER HEAD TO REMAIN - TYPICAL OF ALL SPRINKLER HEADS IN WET LAB NOT INCLUDING PORTION OF WET LAB TO BECOME THE TITAN UPS ROOM.
Μ	REMOVE PORTION OF EXISTING WALL TO ALLOW INSTALLATION OF DOOR DURING NEW PHASE. COORDINATE WITH NEW WORK SCOPE.
Ν	REMOVE DAMAGED CEILING TILES. REPLACE WITH CEILING TILES TO MATCH EXISTING OR REUSE CEILING TILES IN GOOD CONDITION AND WITHOUT DEFECTS OR DAMAGE FROM AREA TO BECOME TITAN UPS ROOM.




SEAL:


PROJECT TITLE:



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DI	RAV	VN	: JH	1			
C	HEC	KE	D: E	3D			
A	CHECKED: BD THIS DRAWING AND ANY REPRODUCTIONS ARE THE PROPERTY AND COPYRIGHT OF BKJ, INC. AND MAY NOT BE REPRODUCED, PUBLISHED, OR USED IN ANY MANNER WITHOUT WRITTEN PERMISSION OF THE ARCHITECT						
REVISIONS:							
	DRAWING PHASE: 100% Construction Documents						
DRAWING TITLE:							
Demolition Floor Plan							
SF	SHEET NO.:						
	AD1.0						

DATE: May 24, 2023

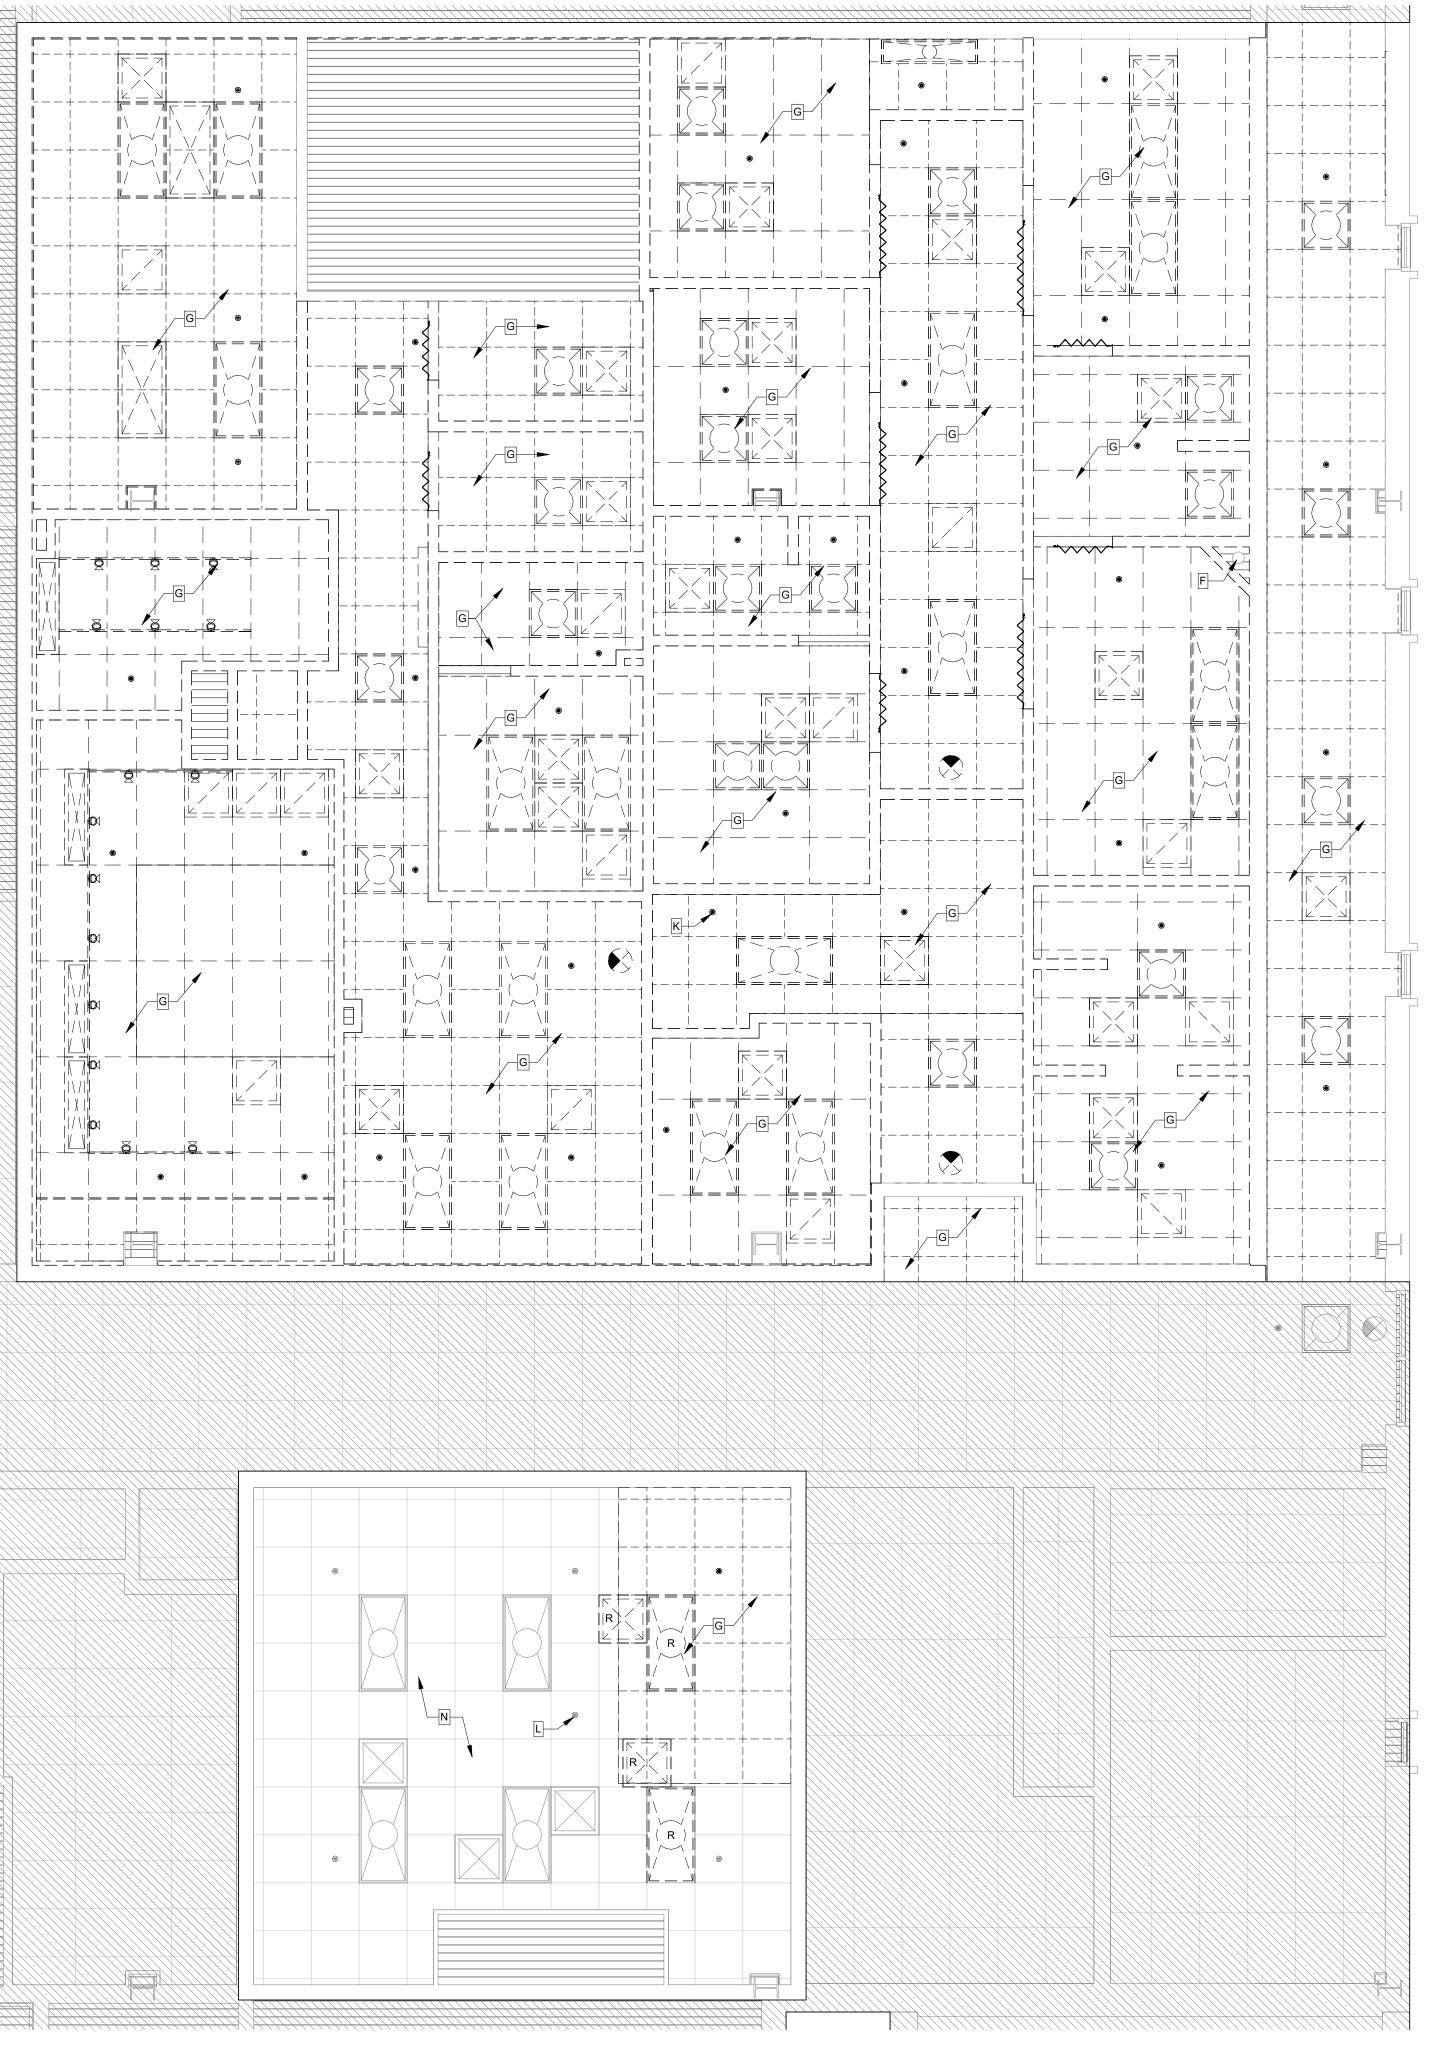

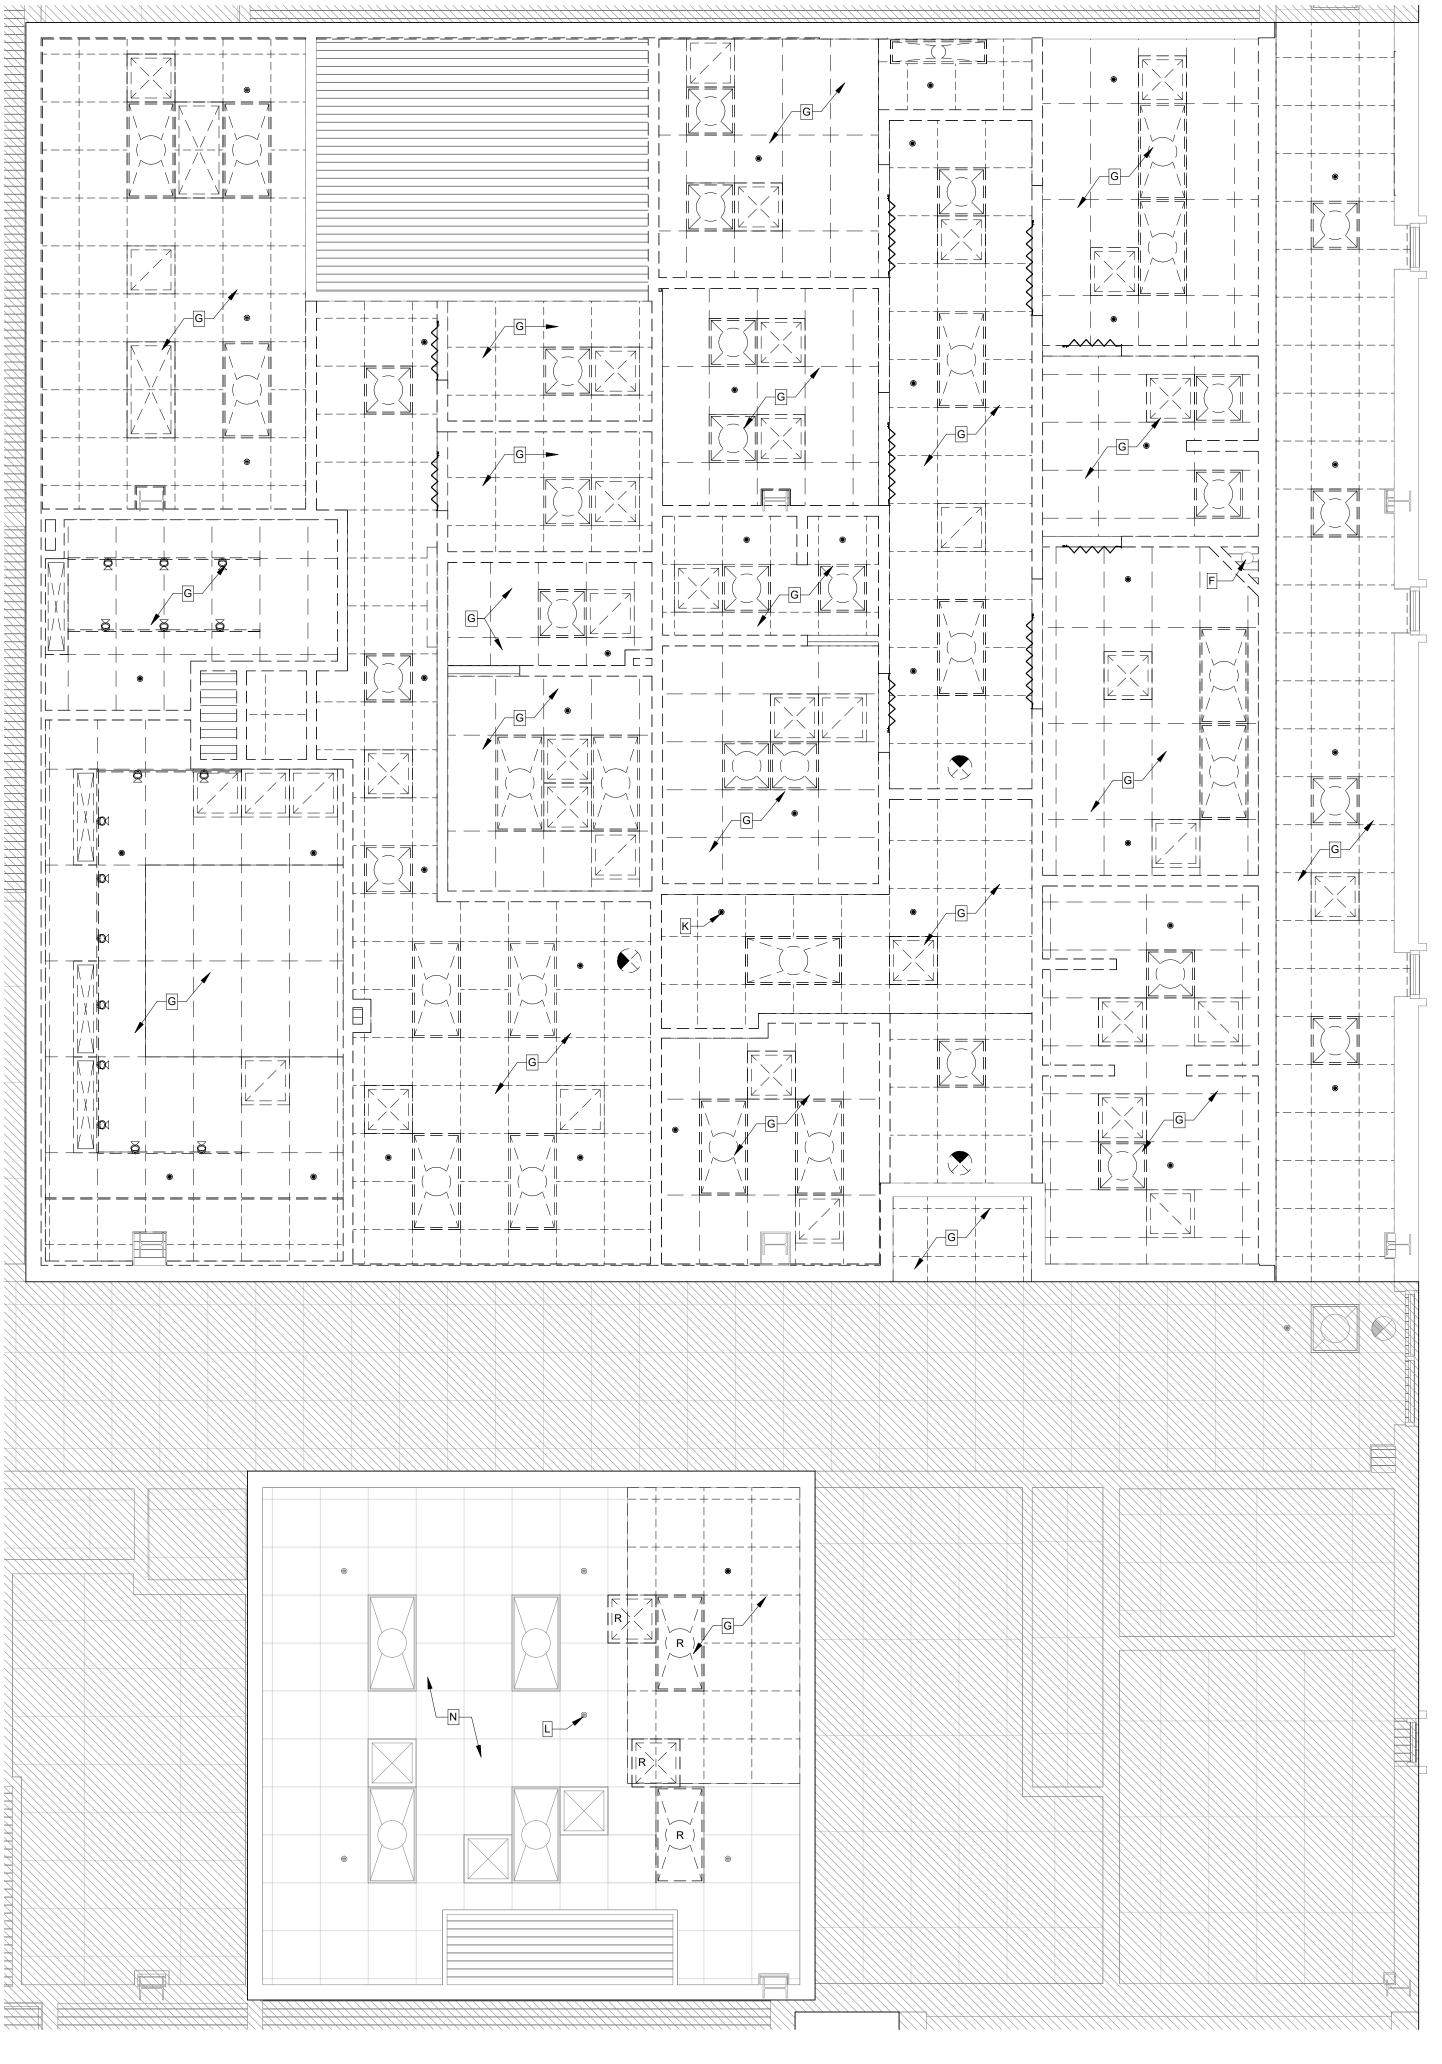

1 Demolition Reflected Ceiling Plan 1/4" = 1'-0"

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Demolition Keynotes:


Der	nolition Keynotes:
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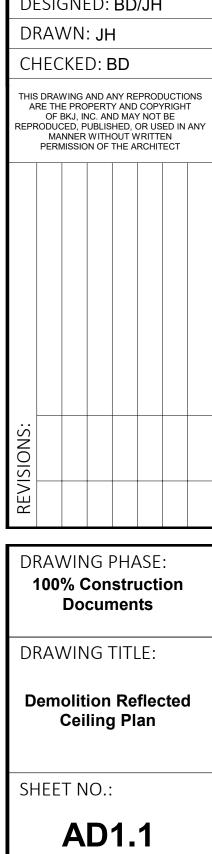
DEFECTS OR DAMAGE FROM AREA TO BECOME TITAN UPS ROOM.



SEAL:

PROJECT TITLE:




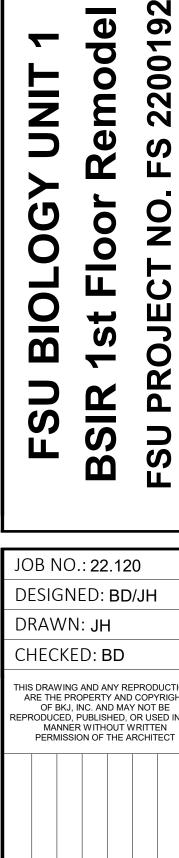

DATE: May 24, 2023

С	DDE REVIEW				
			Allowed/ Required	Provided	Comments
Ge	neral Project Information				
\vdash	Project Name:	FSU BSIR Suite 1900			
\vdash	Project Location: City:	89 Chieftan Way Tallahassee			
\vdash	County:	Leon			
F		Florida			
Us	e and Occupancy Classification				
	Occupancy Group Classification				
⊢	FBC-B (304.1)	Business Group B			Professional Services
\vdash	FFPC (6.1.11) Hazard Classification (FFPC: 39.1.5 & 6.2.2.3)	Business Ordinary Hazard			
\vdash		ordinary nazaru			
La	boratory Unit Hazard Classification (NFPA 45 - Chpt 425)	Class D			Per Table 9.1.1(b).
Le	vel of Alteration	Level 2 Alteration			No change in occupancy
Bu	ilding Area	00.007.05			
\vdash	Total Building Area 1st Floor Area	80,607 SF 26,869 SF			
⊢	Renovated Area	3,311			12% of 1st Floor, 4% of Building
⊢		5,511			
0	cupant Loads (FBC-B: Table 1004.5, FFPC: Table 7.3.1.2)				
	Renovated Area - GSF	3,311			
Ĺ					
	Suite 119 - Business Areas - GSF	2,847/150 = 19			N. 1
\vdash	Total Occupant Load	19			No change in occupancy
\vdash	Wet Lab 116 - Business Areas - GSF	464/150 = 4			
\vdash	Total Occupant Load	464/150 = 4 4			No change in occupancy
\vdash					
Вι	ilding will be provided with a Fire Alarm System (FFPC: 39.	3.4.1)	yes	yes	
Co	nstruction Type:				
\vdash	Type II B, Unprotected, Sprinklered				
F :	e Resistance Rating for Building Elements (Type II B, Unpro	atostad)			
FI	Table 601 (FBC-B)	otected)			
\vdash	Structural Columns		Ohr	Ohr	
F	Bearing Walls Exterior		Ohr	Ohr	
	Nonbearing Walls Exterior (see table 602) ("x" distance >	= 30')	Ohr	0hr	
	Nonbearing Interior Walls and Partitions		Ohr	0hr	
	Floor Construction		Ohr	Ohr	
\vdash	Roof Construction		Ohr	Ohr	
N/	inimum Fire Resistance				
	Stair	FBC-B: 713.4	1hr	1hr	
F	Shaft/Elev. Equip. Rm.	FBC-B: 713.4	1hr	1hr	
F	Fire Walls		N/A	N/A	
	Occupancy Separations		N/A	N/A	
	Horizontal Exit		N/A	N/A	
L	Corridors	FBC-B: 708.1 & 1020.1	Ohr	Ohr	With sprinkler system
<u> </u>	assification of Finishes (FBC-B: Table 803.11, FFPC: 39.3.3)				
	Interior exit stairways, int. exit ramps and exit passageways		В	А, В	
\vdash	Corridors and enclosure for exit access stairways and exit a		C	А, В	
	Rooms and enclosed spaces		C	A, B, C	
	Exit enclosure and exit access corridors - floor finish		Class II	Class II	
Ĺ					
Co	mmon Path of Egress Travel (FBC-B 1006.2.1 and FFPC 39.2	2.5.3.1)			
\vdash	Maximum Travel Distance		100'	<100'	
Fv	it Travel Distance (FBC-B: Table 1017.2, FFPC: 39.2.6.3)				
F	Maximum Travel Distance		300'	<300'	
			500		
м	inimum Corridor Width (FBC-B: Table 1020.2)				
	Minimum corridor width		36"	60"	
м	inimum Number of Exits Per Story (FBC-B: 1006.3.2, FFPC:	7.4)			
\vdash	Minimum Number of Exits Required - Suite 119		1	2	
\vdash	Minimum Number of Exits Required - Building		2	8	
Sn	 aces With One Exit or Exit Access Doorway (FBC-B: 1006.2.	1)			
F	Maximum Occupant Load of Space - Suite 119	-,	49	19	Renovated area - Suite 119
	Maximum Common Path of Egress Travel Distance - Suite	119	100'		Renovated area - Suite 119
De	ad End Corridor (FBC-B: 1020.4)				
Ĺ	Maximum Dead End Corridor, 1st Floor		50'	N/A	Dead End Corridor N/A, space only requires 1 exit
				7 -	
M	inimum Number of Required Plumbing Fixtures (2nd Floor)	(FBC-P Table 403.1)		N/A	Restrooms not included in scope of work
\vdash	The interior space use and total number of occupants has r	ot changed no changes require	or planned for	the building al	I mbing fixture requirments
\vdash	No fire rated assemblies required in this project. Maintain				
	Ite the rated assertiones required in this project, Maintain	menateu par		on the uld	


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AREAS OF REMODEL

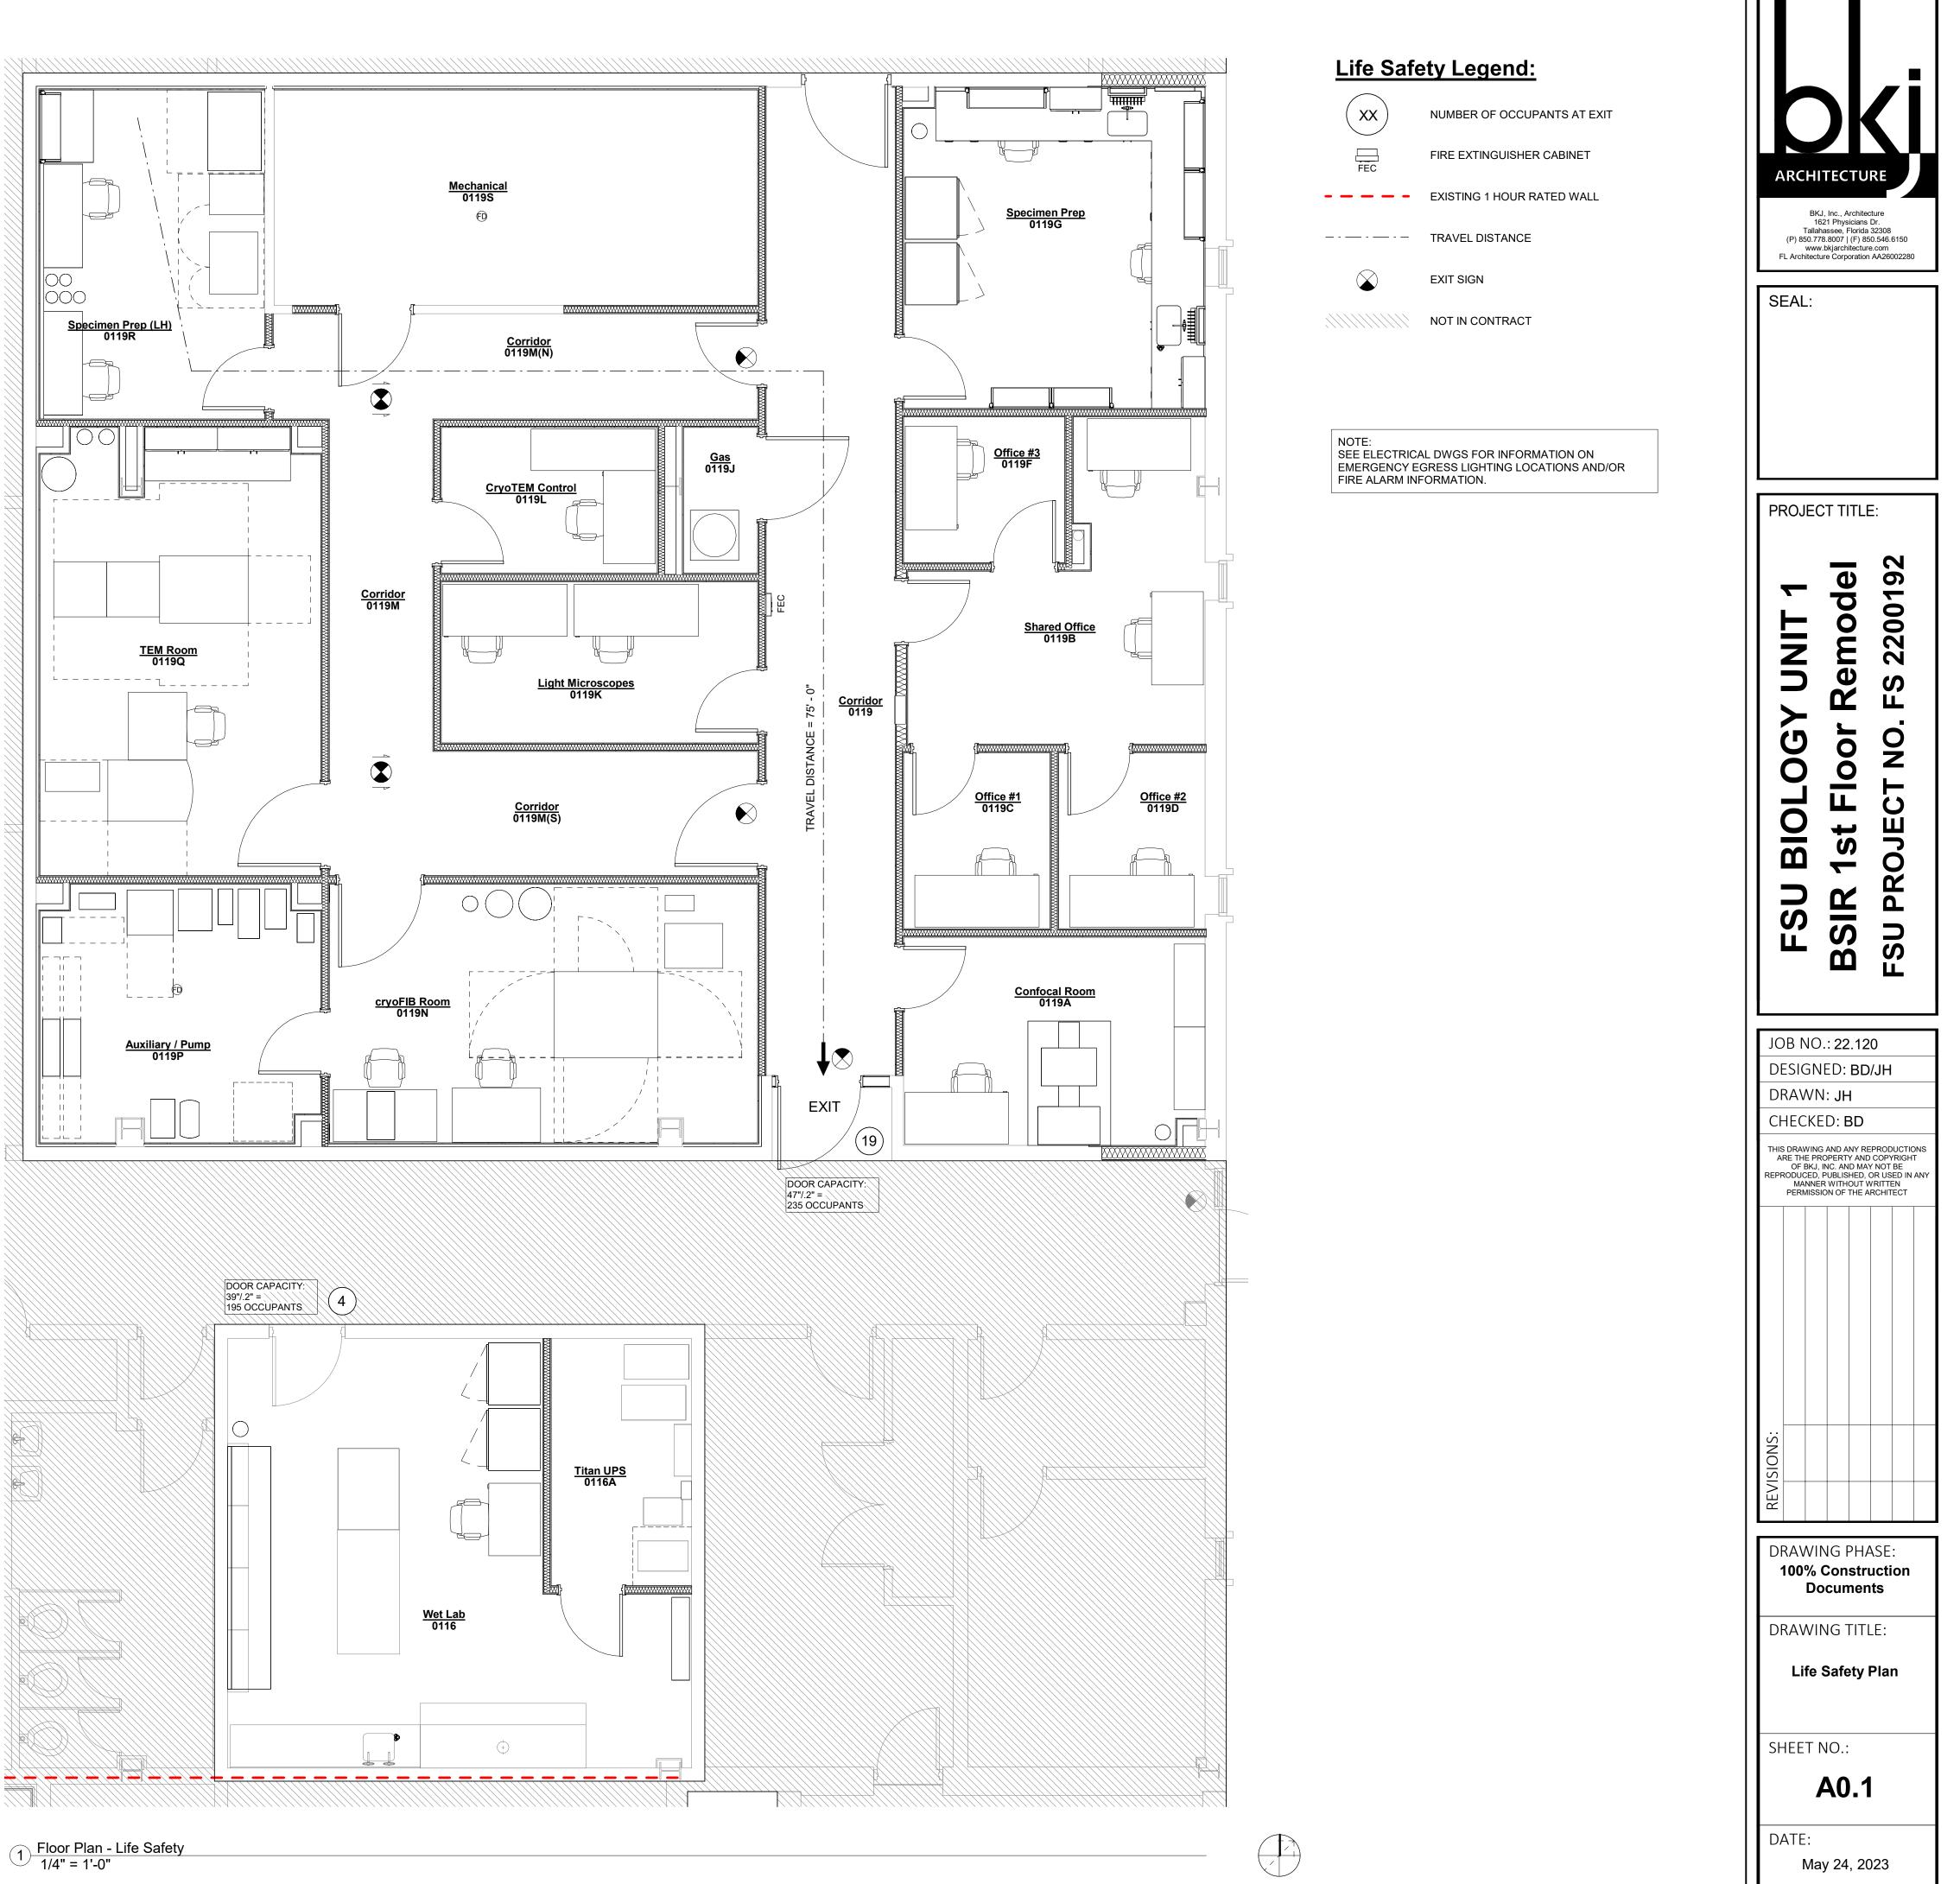


 $1 \frac{\text{Temporary Relcation Plan}}{1/4" = 1'-0"}$

Floor Plan Legend:

	EXISTING WALL TO REMAIN
	EXISTING ELEMENT TO REMAIN
	NEW WALL
	NEW ELEMENT
R	RELOCATED ELEMENT
	VAPOR RETARDER
· – – –	EXISTING 1 HOUR FIRE RATED WALL
	NOT IN CONTRACT
FEC	FIRE EXTINGUISHER CABINET

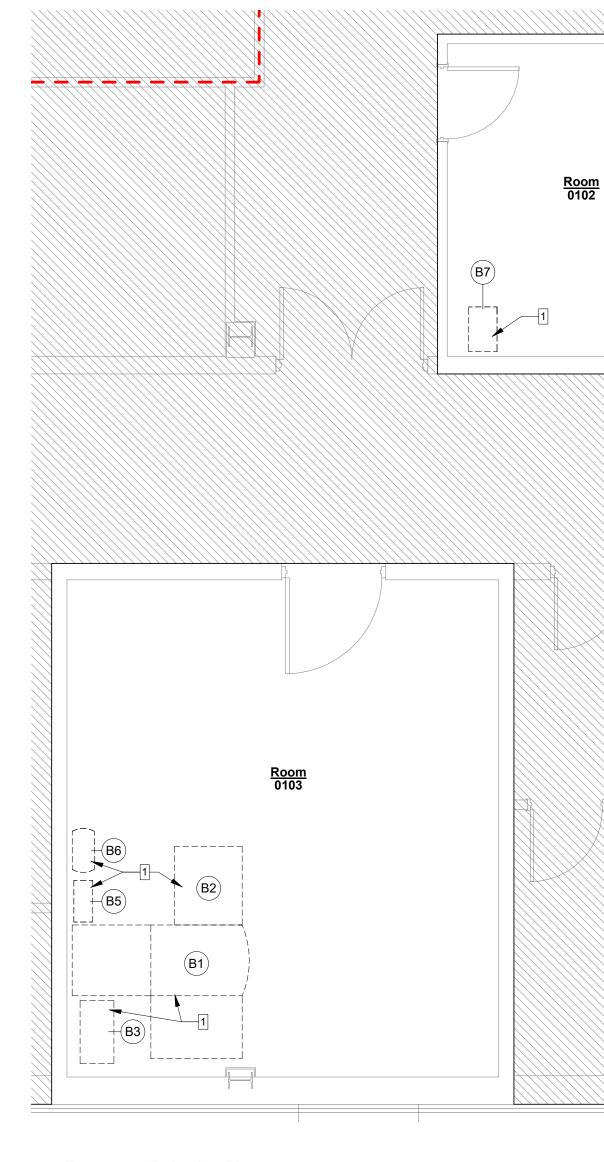Floor Plan Keynotes:

TEMPORARY RELOCATION OF HITACHI & ASSOCIATED EQUIPMENT BY OWNER. PROVIDE ELECTRICAL AND DATA LINES FOR TEMPORARY LOCATION OF HITACHI - SEE ELECTRICAL AND MECHANICAL DWGS. REFER TO EQUIPMENT PLAN FOR CORRESPONDING EQUIPMENT TAGS. 1

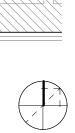


Bk 1 Talla (P) 850.7 www	CJ, Inc., Archite 621 Physicians hassee, Florida 78.8007 (F) 84 w.bkjarchitectur ture Corporation	cture Dr. 1 32308 50.546.6150 re.com
PROJE		 E:
FSU BIOLOGY UNIT 1	BSIR 1st Floor Remodel	FSU PROJECT NO. FS 2200192
DRAWI	NED: BC N: JH	
ARE THE PI OF BKJ REPRODUCED MANNE	G AND ANY RI ROPERTY ANI , INC. AND MA , PUBLISHED,	OR USED IN AN WRITTEN
REVISIONS:		
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DRAWI	NG TIT	LE:

Temporary Relocation Plan

SHEET NO.:

A0.2

DATE: May 24, 2023

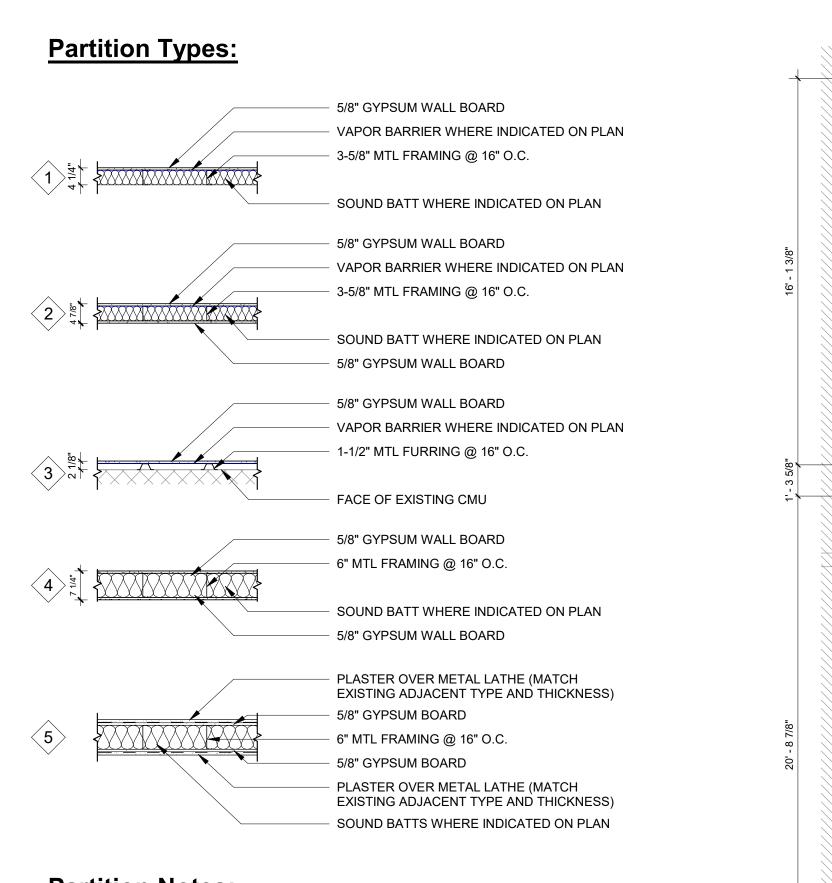

Partition Notes:

1. DEFAULT PARTITION HEIGHT: EXTEND 6" ABOVE HIGHEST ADJACENT CEILING GRID/ STRUCTURE U.N.O. 2. PROVIDE METAL BRACING @ 4' - 0" O.C. MAX ATTACHED TO STRUCTURE ABOVE


ADDITIONAL WALL REQUIREMENTS



- PARTITION TYPE

Additional Requirements:

- A. MOISTURE RESISTANT GYPSUM BOARD ON ONE SIDE
- B. MOISTURE RESISTANT GYPSUM BOARD ON TWO SIDES C. REEF GIFFOLYN 55 VAPOR BARRIER INSTALLED ON FURRING
- BEHIND GYPSUM BOARD D. REEF GIFFOLYN 55 VAPOR BARRIER INSTALLED ON STUDS
- BEHIND GYPSUM BOARD ON HIGHER HUMIDITY SIDE OF WALL
- E. EXTEND WALL TO BOTTOM OF DECK ABOVE F. ACOUSTIC SEALANT EACH SIDE OF MTL STUD BOTTOM TRACK
- G. ACOUSTIC SEALANT EACH SIDE OF MTL STUD TOP & BOTTOM TRACK

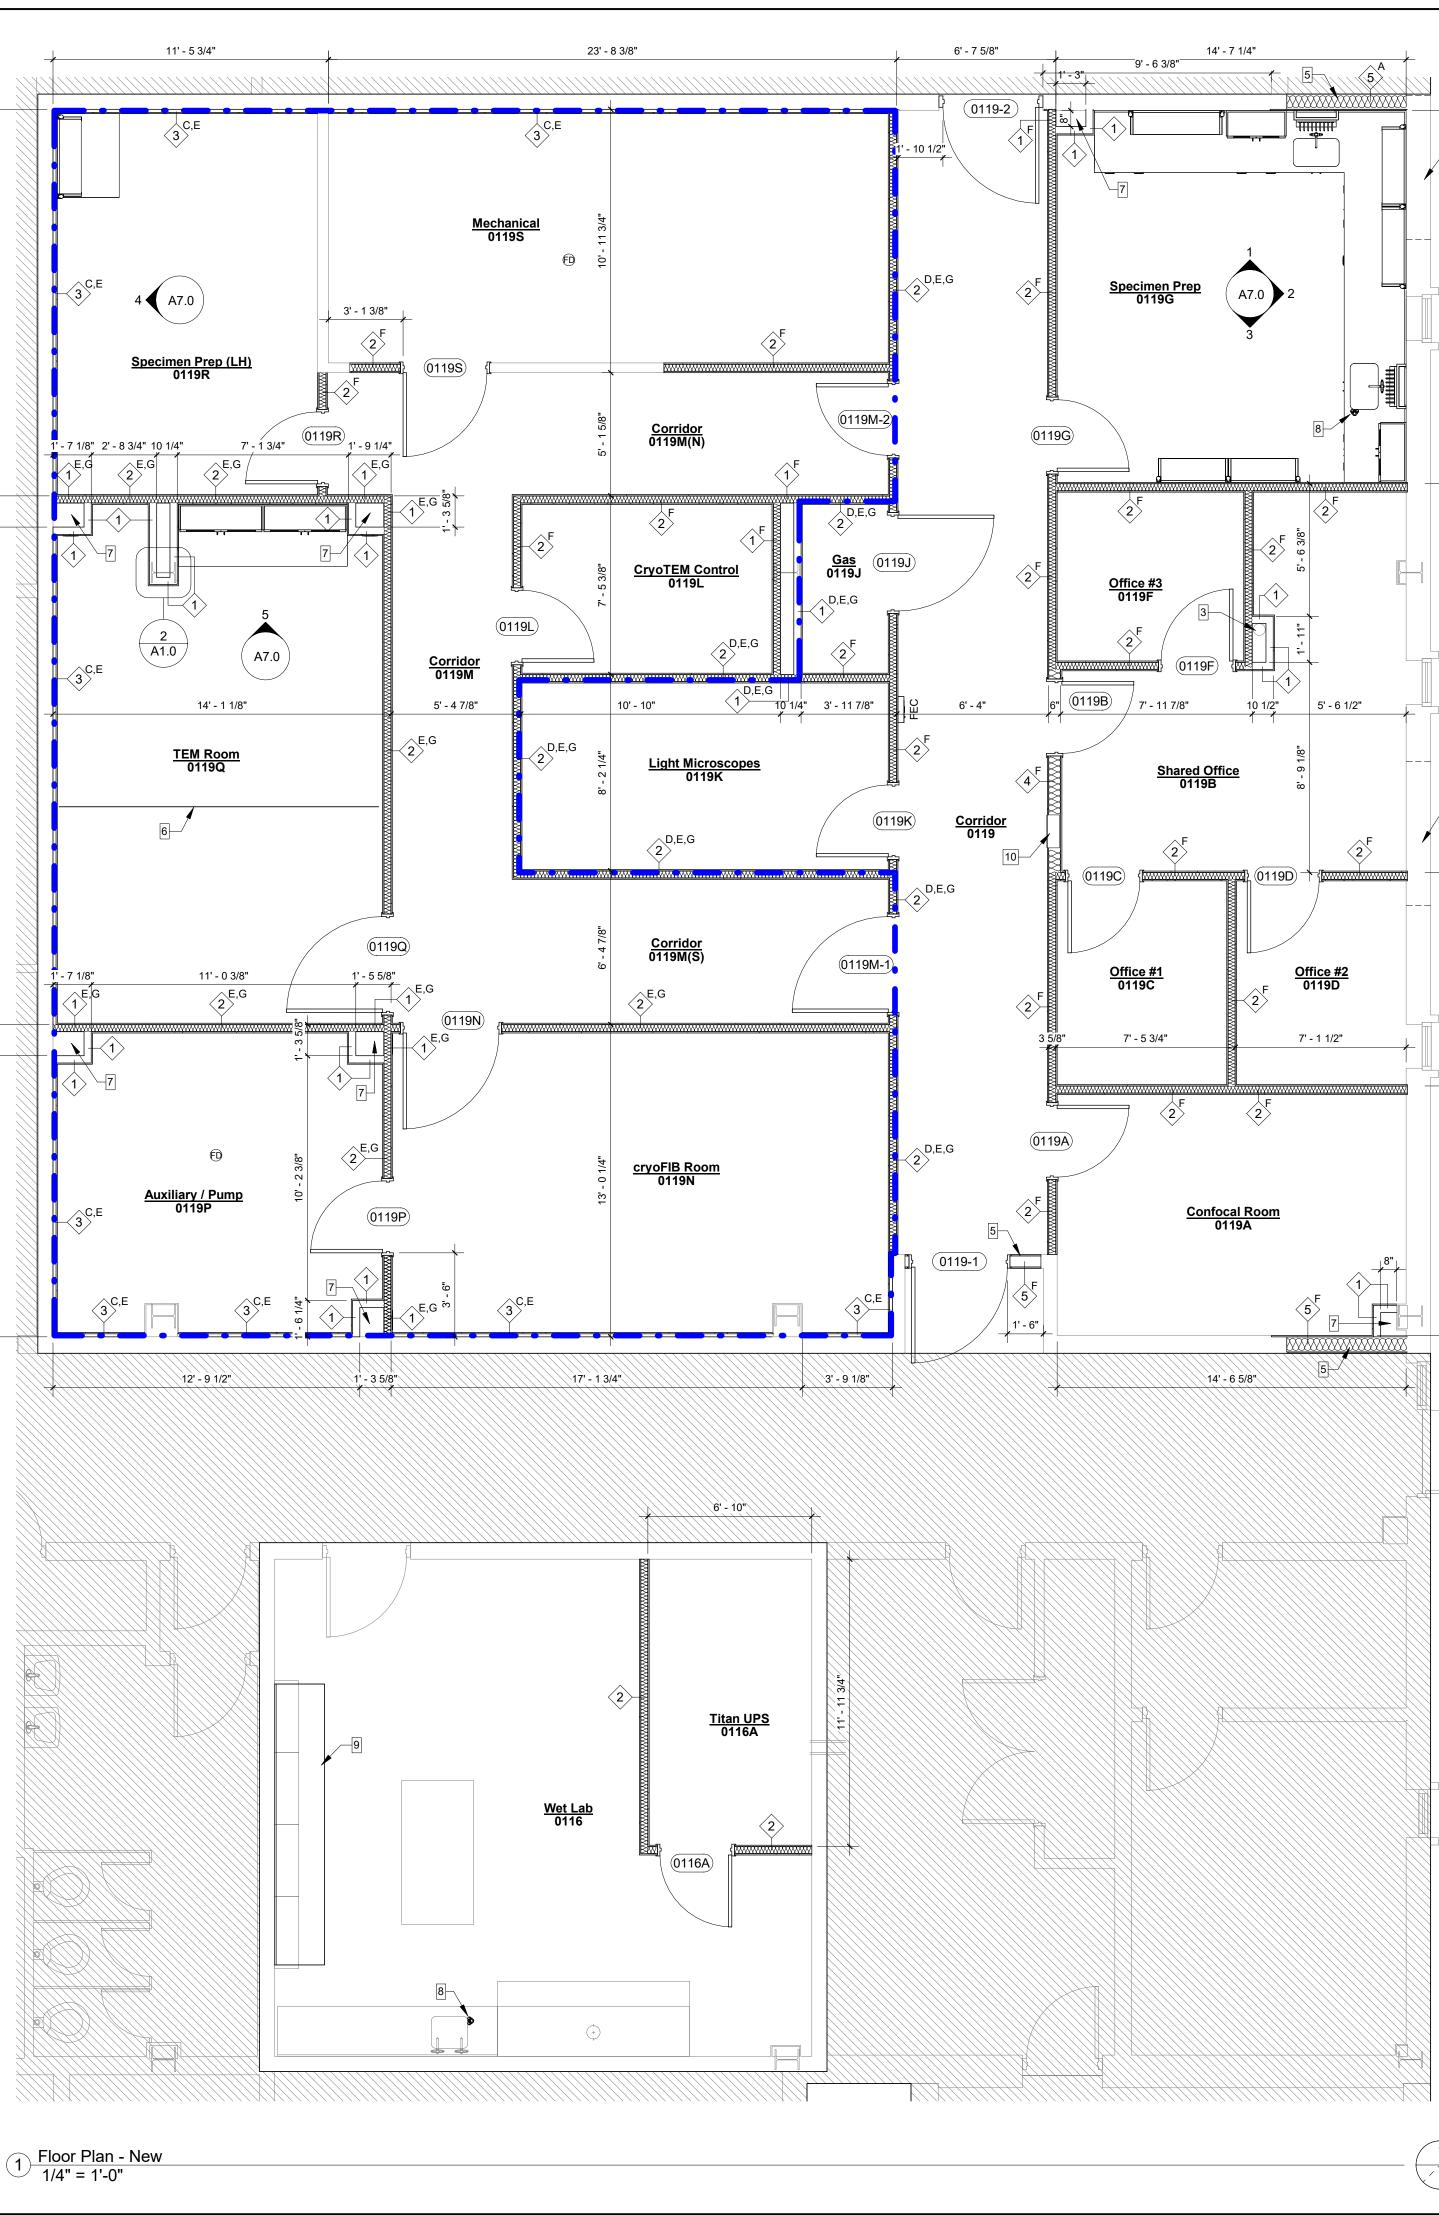

Floor Plan General Notes:

1. ALL DIMENSIONS FOR NEW PARTITIONS ARE TO FACE OF STUD. DIMENSIONS TO EXISTING WALLS ARE TO FACE OF FINISH SURFACE.

2. ALL DOOR OPENINGS TO BE LOCATED 6" FROM FACE OF STUD OF ADJACENT WALL ON HINGE SIDE UNLESS OTHERWISE NOTED. SEE DOOR SCHEDULE COMMENTS AND PLAN DIMENSIONS.

3. FIRE EXTINGUISHERS SHALL BE MOUNTED BETWEEN 41" MIN. AND 48" MAX. ABOVE FINISH FLOOR. PORTABLE FIRE EXTINGUISHERS SHALL BEAR THE LABEL OF AN APPROVED AGENCY, BE AN APPROVED TYPE, AND BE INSTALLED IN A LOCATION VISIBLE AND ACCESSIBLE TO THE OCCUPANTS. VERIFY LOCATION IN FIELD WITH FIRE MARSHALL.

4. ANY PENETRATIONS THROUGH AN EXISTING FIRE RATED ASSEMBLY, EITHER PRIOR TO CONSTRUCTION ACTIVITIES, OR AS A RESULT OF CONSTRUCTION SHALL BE SEALED WITH APPROPRIATE U.L. RATED ASSEMBLY.

5. PROVIDE PLYWOOD BLOCKING BEHIND GYP. BOARD TO SUPPORT EQUIPMENT AND/OR MISC. ITEMS INSTALLED (MILLWORK, TOILET PAPER HOLDERS, GRAB BARS, MIRRORS, KITCHEN SHELVING ETC.).

6. NOT USED.


A2.0

7. CONTRACTOR TO SUBMIT SHOP DRAWINGS FOR ALL MILLWORK.

8. THE DESIGN AND CONSTRUCTION OF ALL NON-LOAD BEARING INTERIOR LIGHT GAUGE METAL FRAMING SHALL BE THE RESPONSIBILITY OF THE CONTRACTOR. AT A MINIMUM, THIS FRAMING SHALL BE CONSTRUCTED OF 20 GAUGE (30 MIL – 33 KSI) OR 20 GAUGE EQ (18 MIL – 70 KSI) METAL STUDS AND TRACK, STUDS SHALL HAVE MAXIMUM SPACING OF 16" O.C., WITH DOUBLE STUDS AT DOOR AND WINDOW JAMBS. PROVIDE A MINIMUM OF TWO #10 SELF TAPPING SCREWS AT ALL CONNECTIONS.


9. AT ALL UTILITY TRENCHES IN EXISTING SLAB, ADD 6 MIL. VAPOR BARRIER AFTER SOIL HAS BEEN TREATED. PROVIDE #3 DOWELS @ 24" O.C. ON BOTH SIDES. DRILL HOLES 6" DEEP IN ADJACENT SLAB. DOWELS TO FIT TIGHT AND SECURE IN HOLES.

Floor Plan Legend:

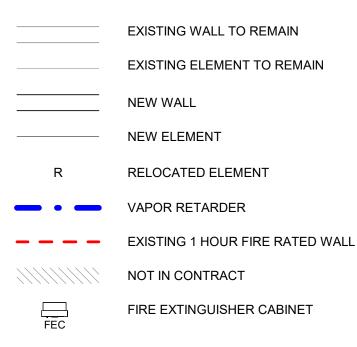


Floor Plan Keynotes:

1	APPROXIMATE LOCATION OF NEW AIR INTAKE LOUVER - SEE MECHANICAL DWGS AND ARCHITECTURAL ELEVATION.
2	APPROXIMATE LOCATION OF NEW AIR EXHAUST LOUVER - SEE MECHANICAL DWGS AND ARCHITECTURAL ELEVATION.
3	APPROXIMATE LOCATION OF EXISTING RAIN LEADER TO REMAIN.
4	RECESSED CEILING MOUNTED EMERGENCY SHOWER. CENTER IN CEILING TILE. SEE PLUMBING DWGS.
5	INFILL OPENING WITH METAL STUDS, GYPSUM BOARD, AND PLASTER FINISH BOTH SIDES OF WALL. MATCH EXISTING ADJACENT WALL THICKNESS. PROVIDE A SMOOTH, SEAMLESS TRANSITION BETWEEN NEW AND EXISTING WALL FACES BOTH SIDES OF WALL.
6	CEILING MOUNTED EMI SHIELD CURTAIN AND TRACK. REFER TO SHEET A6.0 FOR BASIS OF DESIGN.
7	LOW WALL EXHAUST - SEE MECHANICAL DWGS.
8	DECK MOUNTED EYEWASH - SEE PLUMBING DWGS.
9	NEW EPOXY COUNTERTOP ON REUSED BASE CABINET. COLOR AND THICKNESS TO MATCH EXISTING.
10	RECESSED ELECTRICAL PANEL. SEE ELECTRICAL DWGS.

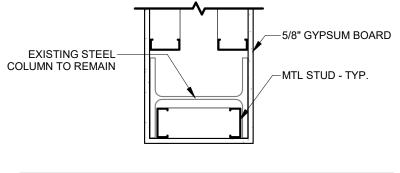


NOTE: SIZE OF THE EXISTING COLUMN IS UNKNOWN. THE INTENT IS TO PROVIDE THE SMALLEST COLUMN WRAP THAT CAN BE ACHIEVED.

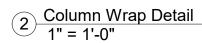





SEAL:

PROJECT TITLE:

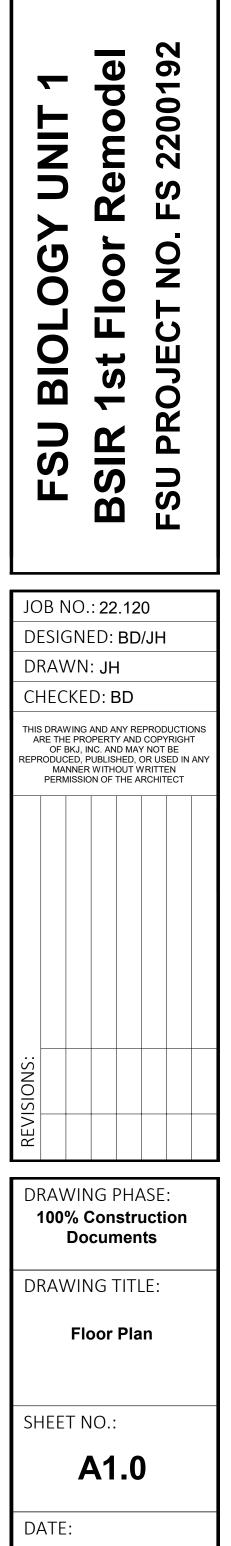


May 24, 2023

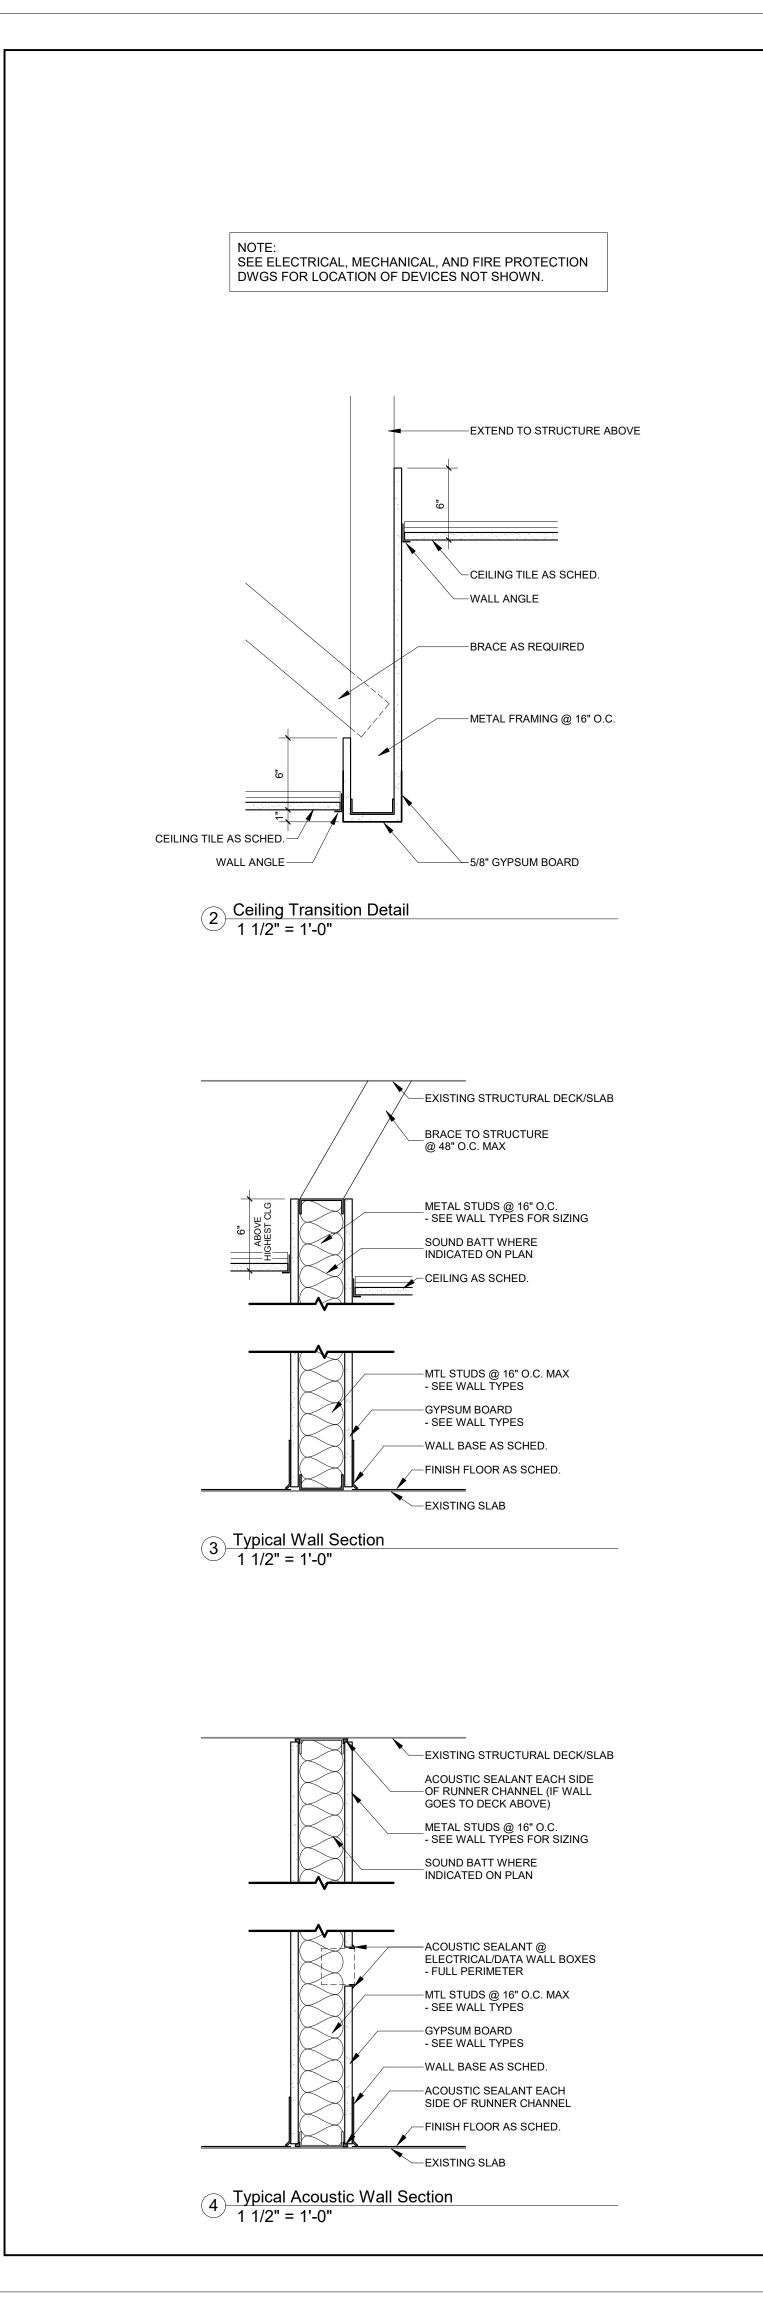

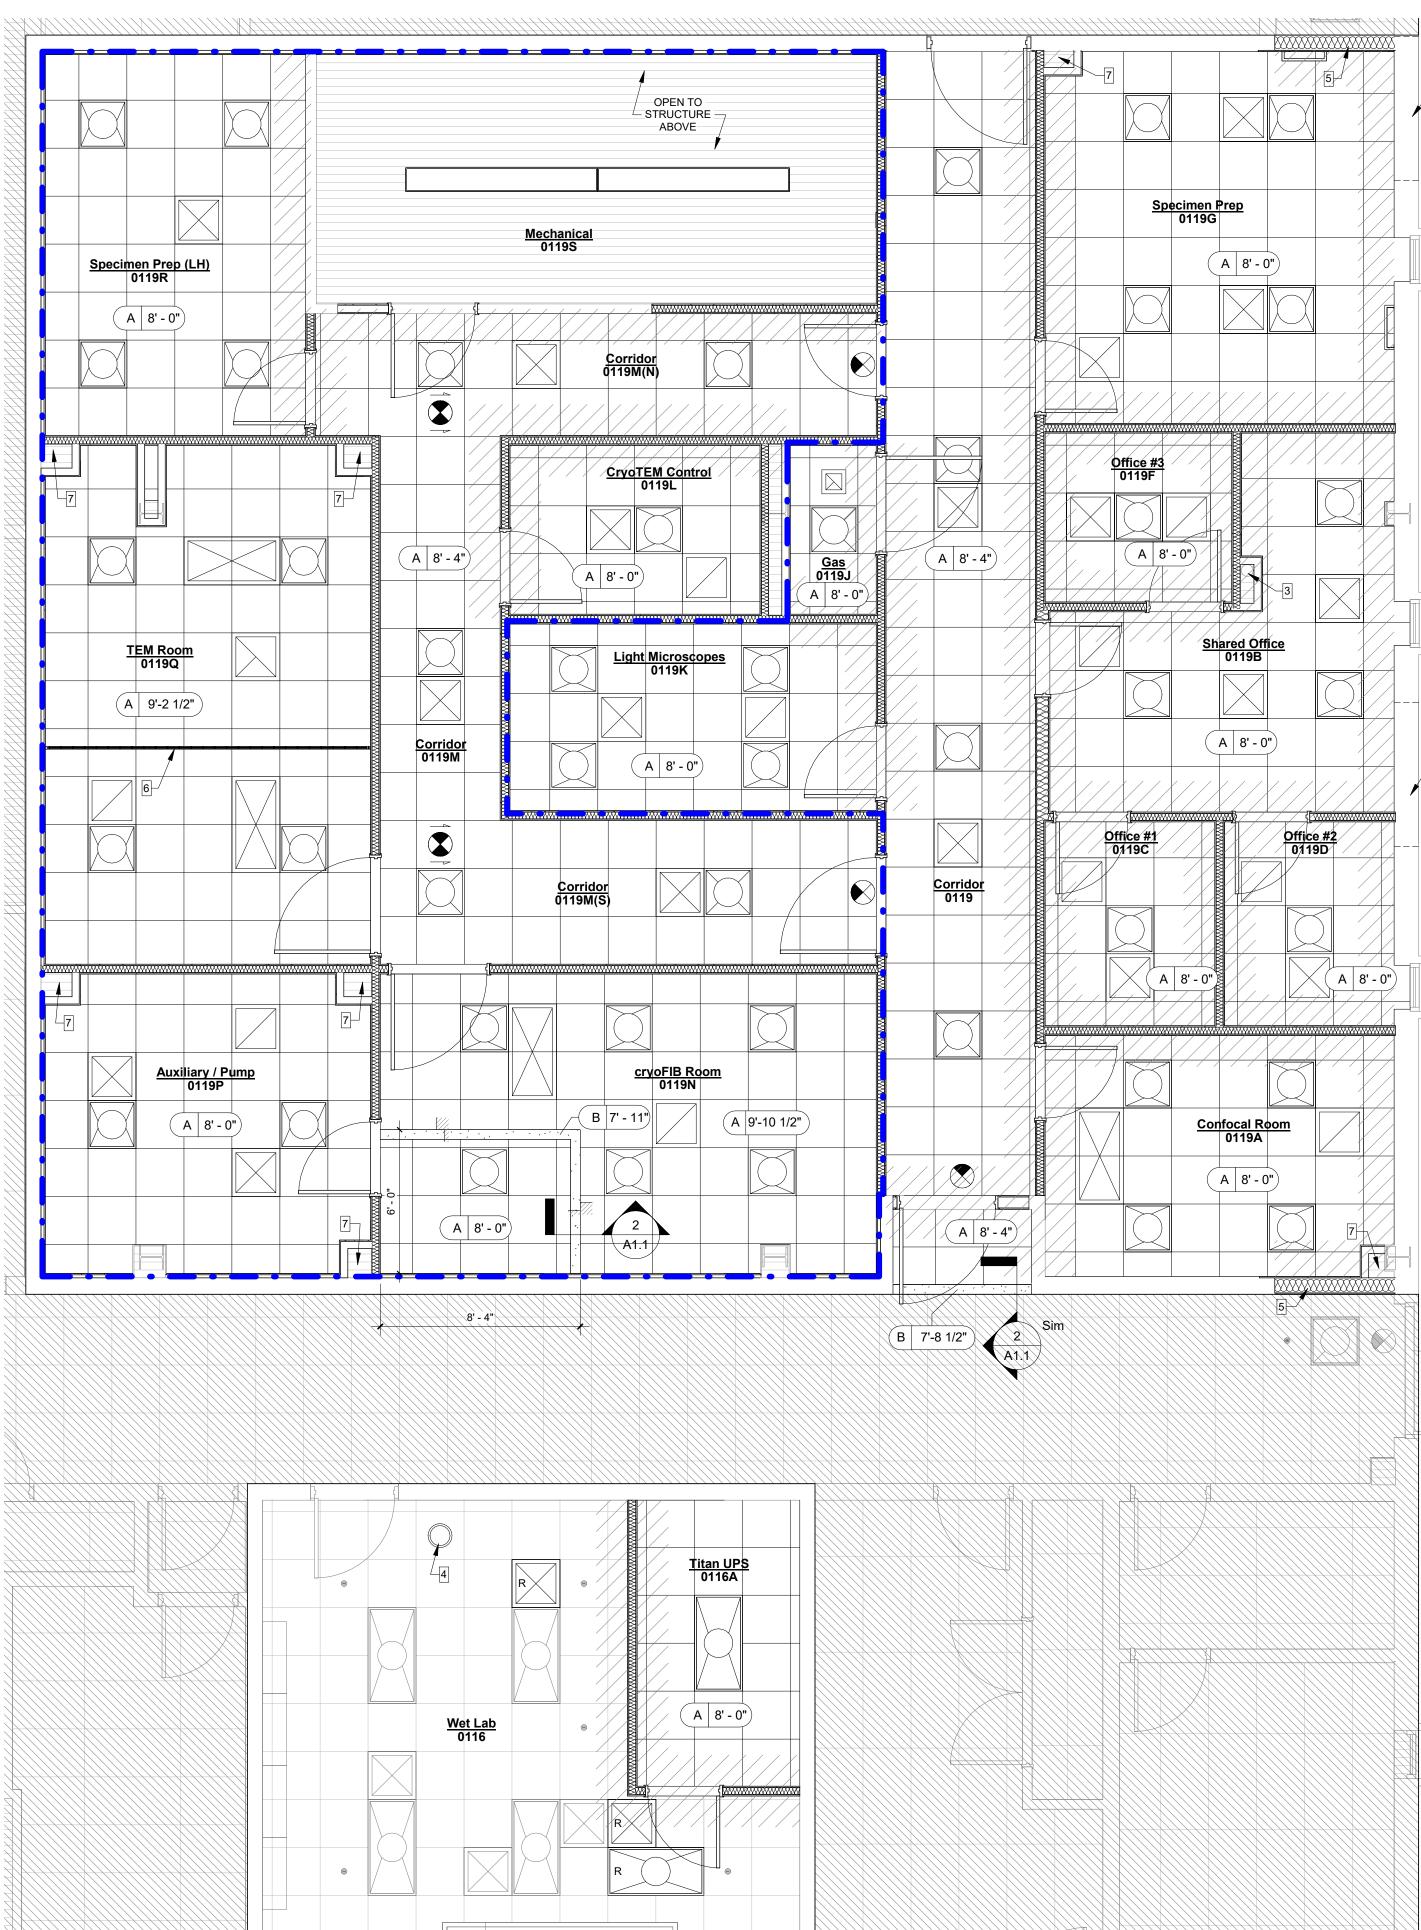

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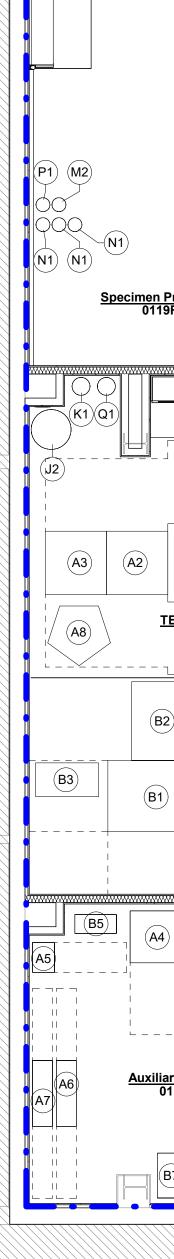


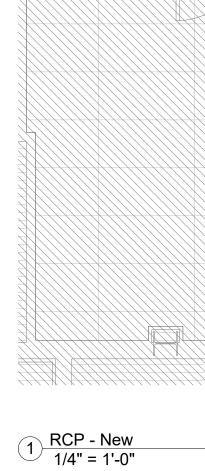	neral Notes:	
AND SWITCHIN	E WITH ELECTRICAL PLAN FOR LOCATION OF FIXTURES IG. ANY DISCREPANCIES DISCOVERED IN THE DRAWINGS UGHT TO THE ATTENTION OF THE ARCHITECT.	
AND DIFFUSEF	E WITH MECHANICAL PLAN FOR LOCATION OF DUCTWORK S. ANY DISCREPANCIES DISCOVERED IN THE DRAWINGS	
3. SEE ELECTE	UGHT TO THE ATTENTION OF THE ARCHITECT. RICAL DWGS FOR INFORMATION ON EMERGENCY EGRESS	
	ATIONS AND/OR FIRE ALARM INFORMATION. KLER LOCATIONS ARE SHOWN IN FIRE PROTECTION	ARCHITECTURE
	E FP SHEETS FOR DETAILS.	BKJ, Inc., Architecture 1621 Physicians Dr. Tallahassee, Florida 32308 (P) 850.778.8007 (F) 850.546.6150
Floor Pl	an Legend:	www.bkjarchitecture.com FL Architecture Corporation AA26002280
	EXISTING WALL TO REMAIN	SEAL:
	EXISTING ELEMENT TO REMAIN	
	NEW WALL	
R	NEW ELEMENT	
	VAPOR RETARDER	
	EXISTING 1 HOUR FIRE RATED WALL	
	NOT IN CONTRACT	PROJECT TITLE:
FEC	FIRE EXTINGUISHER CABINET	⋈ _ ⋈
1 :		de 1
Lighting	<u>a & HVAC Legend:</u>	UNIT 1 Remodel FS 2200192
	1'x8' LINEAR LED PENDANT	UNIT Remo S 220(
	2'x4' RECESSED LED	
	2'x2' RECESSED LED	No. No.
	2'x4' SUPPLY DIFFUSER	
	2'x2' SUPPLY DIFFUSER	R 1st PROJE
	2'x2' RETURN GRILLE	
	2'x2' EXHAUST VENT	BS BS
	1'x1' EXHAUST VENT	
\bigotimes	EXIT LIGHT	JOB NO.: 22.120
	36" WIDE STRIP UNFACED BATTS ABOVE CEILING TILES	DESIGNED: BD/JH DRAWN: JH
۲	SPRINKLER HEAD	CHECKED: BD THIS DRAWING AND ANY REPRODUCTION ARE THE PROPERTY AND COPYRIGH
RCP Le	aend:	OF BKJ, INC. AND MAY NOT BE REPRODUCED, PUBLISHED, OR USED IN MANNER WITHOUT WRITTEN PERMISSION OF THE ARCHITECT
(A 9'-0")		
	CEILING HEIGHT CEILING FINISH	
	Finish Legend:	
A - ACOUSTICA B - GYPSUM BO	AL CEILING TILE	
Floor Pl	an Keynotes:	SNC SNC
	OXIMATE LOCATION OF NEW AIR INTAKE LOUVER MECHANICAL DWGS AND ARCHITECTURAL ELEVATION.	REVISIONS
	OXIMATE LOCATION OF NEW AIR EXHAUST LOUVER MECHANICAL DWGS AND ARCHITECTURAL ELEVATION.	
3 APPR	OXIMATE LOCATION OF EXISTING RAIN LEADER TO REMAIN.	DRAWING PHASE: 100% Construction
	SSED CEILING MOUNTED EMERGENCY SHOWER. CENTER IN CEILING SEE PLUMBING DWGS.	Documents
5 BOTH PROV	. OPENING WITH METAL STUDS, GYPSUM BOARD, AND PLASTER FINISH SIDES OF WALL. MATCH EXISTING ADJACENT WALL THICKNESS. IDE A SMOOTH, SEAMLESS TRANSITION BETWEEN NEW AND EXISTING	DRAWING TITLE:
WALL	FACES BOTH SIDES OF WALL. NG MOUNTED EMI SHIELD CURTAIN AND TRACK. REFER TO SHEET FOR BASIS OF DESIGN.	Reflected Ceiling Pla
	WALL EXHAUST - SEE MECHANICAL DWGS.	SHEET NO.:
8 DECK	MOUNTED EYEWASH - SEE PLUMBING DWGS.	A1.1
	EPOXY COUNTERTOP ON REUSED BASE CABINET. COLOR AND	
	INESS TO MATCH EXISTING.	DATE:


an ID	Equipment Type	New/Exist/Future	Mfr / Model	Location
	cryo Transmission Electron Microscope (TEM)	New	Glacios / PN 107072	TEM Room
	Supporting Equipment:			
A1	Microscope Console	New		TEM Room
A1 A2	Low Box Cabinet	New		TEM Room
A3	E Cabinet	New		TEM Room
A4	Chiller (water)	New	Haskris / LX2-W5	Auxiliary/Pump
A5	MAINS	New		Auxiliary/Pump
A6	UPS 1	New		Auxiliary/Pump
A7	UPS 2	New		Auxiliary/Pump
A8	HT Tank	New	Glasios	TEM Room
A9	Control Station	New		cryoTEM Control
A10	CMTS?	New		NOT SHOWN
A11	Storage Server	New		NOT SHOWN
	Screening Transmission Electron Microscope (TEM)	Existing	Hitachi / HT7800 series	TEM Room
	Supporting Equipment:			
B1	Microscope Console	Existing		TEM Room
B2	Display Station	Existing		TEM Room
B3	HV Power Supply	Existing		TEM Room
B4	Transformer	Existing		NOT SHOWN
B5	Rotary Pump	Existing		Auxiliary/Pump
-	Air Compressor	Existing		Auxiliary/Pump
B6	Chiller (water)	-		Auxiliary/Pump Auxiliary/Pump
B7		Existing		
	Chameleon Vitrification Instrument (CVI)	Existing	SPT Labtech / ?	Specimen Prep (LH)
	Chameleon Vitrincation Instrument (CVI) Supporting Equipment:	LAISTING	ST LableCity !	speamen riep (LII)
C1		Existing		Specimen Prep (LH)
C1	Vitrification Unit			
C2	Monitor & Keyboard	Existing		Specimen Prep (LH)
C3	Air Compressor?	Existing		NOT SHOWN
D1		E. dura		
D1	High Pressure Freezer (ICE)	Future	Leica / EM ICE	Specimen Prep (LH)
		Fishing		
	<u>cryo Focused Ion Beam (FIB)</u> <u>Supporting Equipment:</u>	Future	Aquilos2 / PN 1207264	cryoFIB Room
E1	Microscope console	Future		cryo FIB Room
E2	Electric Console	Future		cryo FIB Room
				-
E3	PC and Monitor	Future		cryo FIB Room
E4	Pump	Future		cryo FIB Room
E5	Pre Vaccum Pump	Future	BOC-Edwards XDS-10	Auxiliary/Pump
E6	Chiller (water)	Future	Haskris LX-1	Auxiliary/Pump
E7	UPS	Future	LP8-11U/LP6-11U	Auxiliary/Pump
E8	UPS (battery cabinet)	Future		Auxiliary/Pump
E9	E-Connection Box	Future		Auxiliary/Pump
E10	Air Compressor	Future		NOT SHOWN
F1	cryo Light Microscope (CLEM)	Existing	Leica ?	cryoFIB Room
	Confocal Microscope	Existing	Nikon CSU-W1	Confocal Room
	Supporting Equipment:			
G1	Microscope Console	Existing		Confocal Room
G2	Air Table	Existing		Confocal Room
G3	Computer Console	Existing		Confocal Room
	Titan Equipment	Existing		Titan UPS Room
	Supporting Equipment:			
H1	Battery Cabinet	Existing		Titan UPS Room
H2	UPS	Existing		Titan UPS Room
	Transformer	Existing		Titan UPS Room
H3	Bypass	-		
H4		Existing		Titan UPS Room
H5	Disconnect	Existing		Titan UPS Room
H6	Server	Existing		Titan UPS Room
	Other Equipment			
-	Other Equipment	Evicting		
R	Air Table	Existing		Wet Lab
S	Fridge	Existing		Wet Lab
Т	Freezer	Existing		Wet Lab
	Fridge	Existing		Specimen Prep
U			1	
U V	Freezer	Existing		Specimen Prep
	Freezer Chemical Storage Cabinet	Existing Existing		Wet Lab


Equipment Schedule (Gases)


Plan ID	Gas Type	New/Exist/Future	Size	Location
	Liquid Nitrogen			
J1	LN2	Existing	230L Dewar	Gas
J2	LN2	Existing	120L Dewar	TEM Room
J3	LN2	Existing	50L	TEM Room
J4	LN2	Existing	35L	TEM Room
	Gaseous Nitrogen			
К1	N2	Existing	size K	TEM Room
	Carbon Dioxide			
L1	CO2	Existing	size K	Confocal
L2	CO2	Existing	size K (qty:2)	Wet Lab
	Argon			
M1	Ar	Existing	size K	Specimen Prep
M2	Ar	Existing	size 35 (qty:3)	Specimen Prep (LH)
M3	Ar	Existing	size K	cryoFIB Room
	Ethane			
N1	C2H6	Existing	size 35	Specimen Prep (LH)
	<u>Helium</u>			
P1	Не	Existing	size 35	Specimen Prep (LH)
	Sulfur Hexafluoride			
Q1	SF6	Existing	size k?	TEM Room



1 Equipment Plan 1/4" = 1'-0"

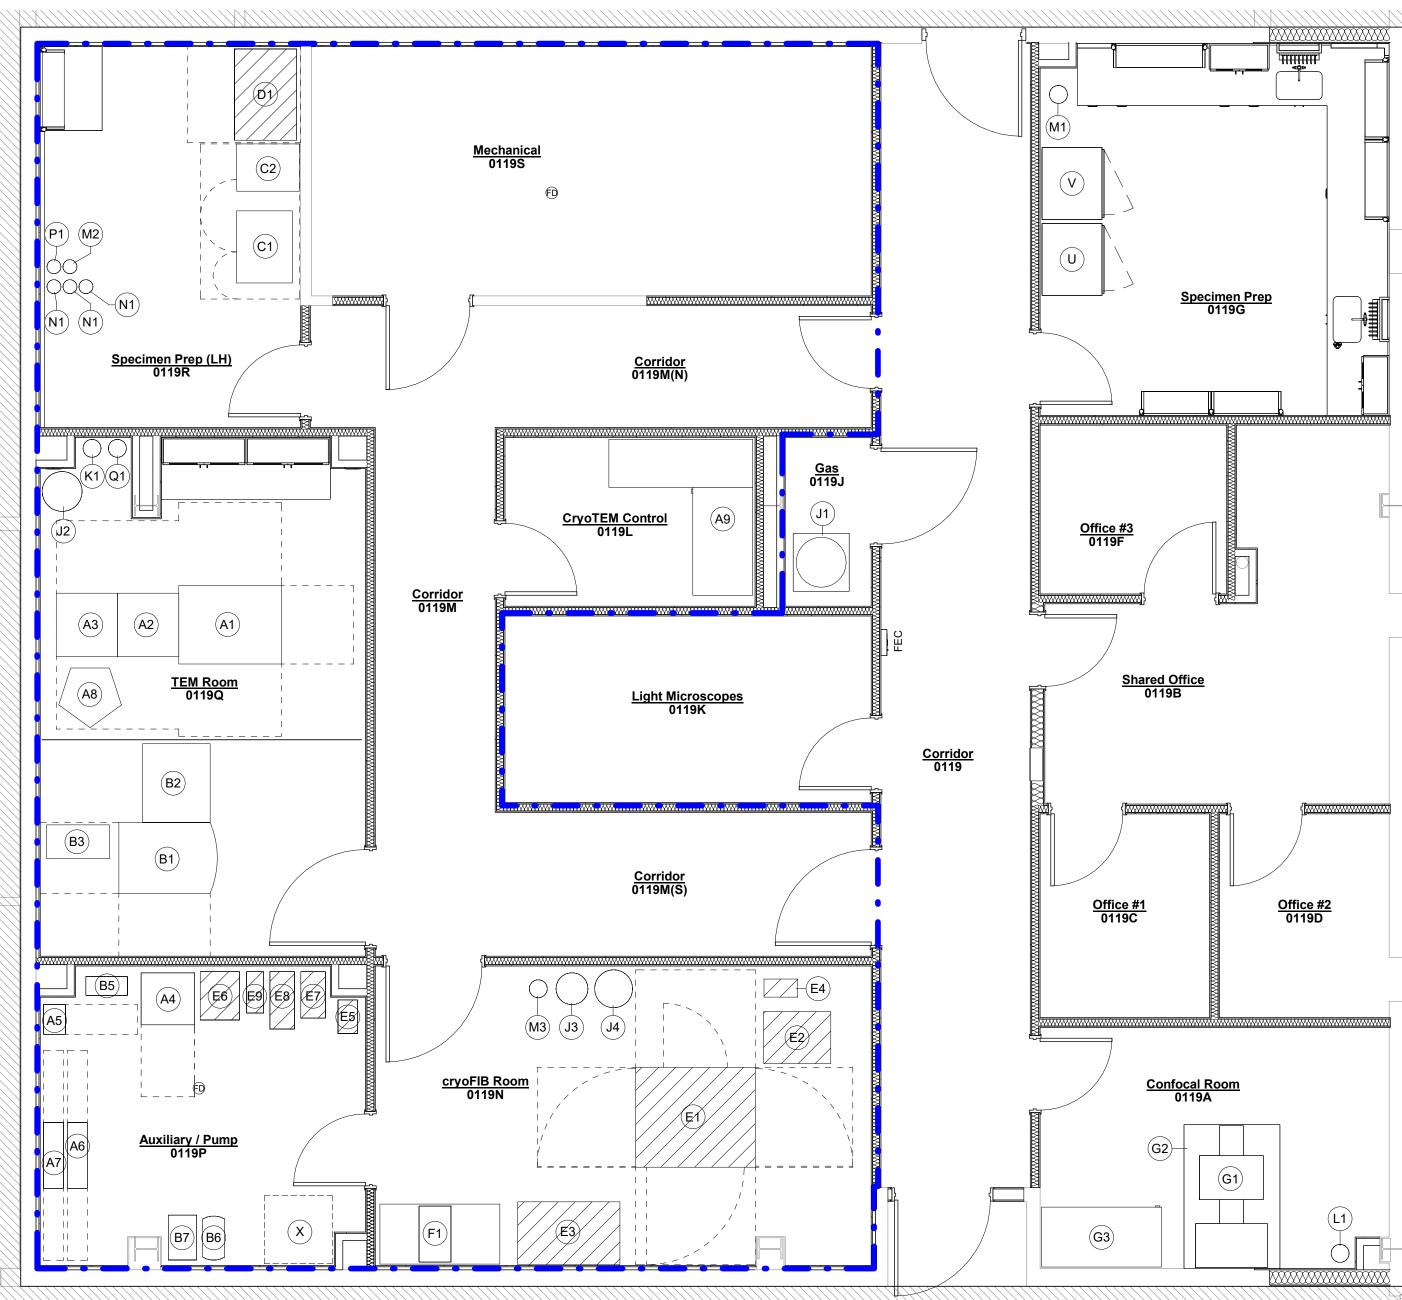

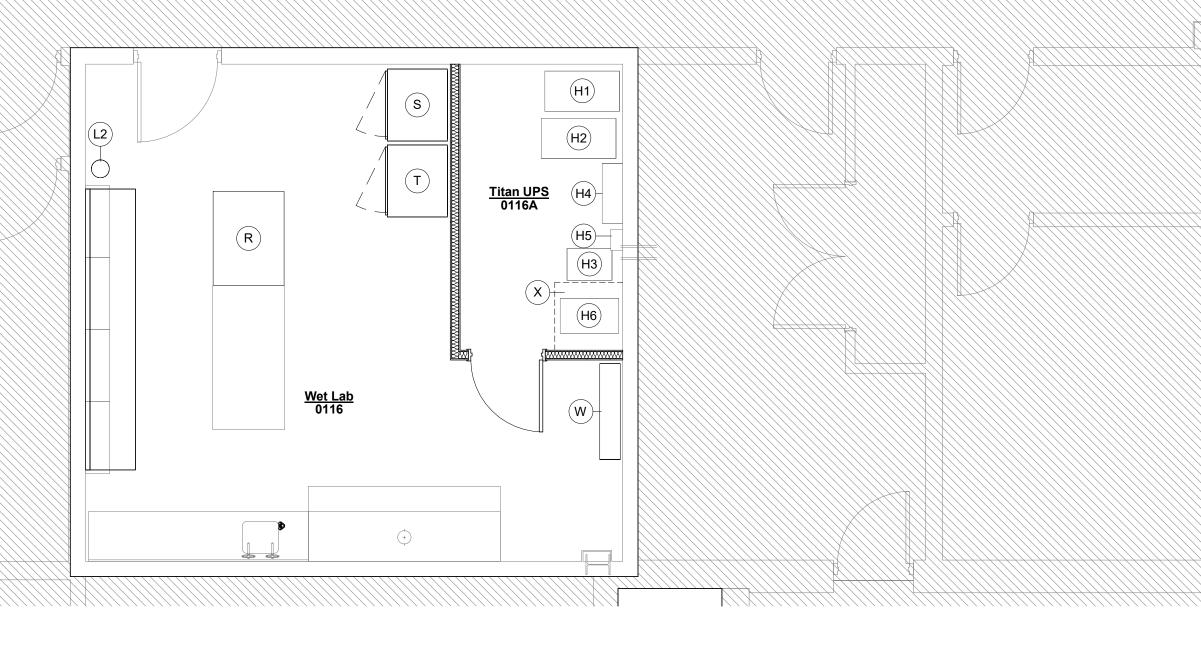

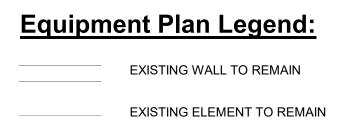

NEW WALL

-

FEC

(X#)

_ _ _ _ _ _ _ _ _

NEW ELEMENT

• • VAPOR RETARDER

NOT IN CONTRACT

FUTURE EQUIPMENT

FIRE EXTINGUISHER CABINET

EQUIPMENT TAG

EQUIPMENT SERVICE CLEARANCE

Equipment Schedule Notes:


1. OWNER TO CONFIRM WITH EQUIPMENT VENDOR(S) THAT ALL EQUIPMENT SHOWN, INCLUDING SUPPORTING EQUIPMENT, OPTIONAL ADD ON COMPONENTS FOR EQUIPMENT, AND CLEARANCES FOR EQUIPMENT HAS NOT CHANGED, IS CORRECT, AND PROPERLY SHOWN IN THE DESIGN. 2. TEM ROOM EQUIPMENT TO BE INSTALLED AS SHOWN TO MEET EQUIPMENT CLEARANCE REQUIREMENTS. 3. PER THE EQUIPMENT SCHEDULE, EXISTING, NEW, AND FUTURE ARE DEFINED AS


FOLLOWS: EXISTING: EQUIPMENT CURRENTLY OWNED AND TO BE REINSTALLED AS SHOWN

NEW: EQUIPMENT TO BE PURCHASED AND INSTALLED AS SHOWN FUTURE: SELECTED EQUIPMENT COULD CHANGE. INSTALLATION DATE


UNKNOWN. 4. ALL GAS CYLINDERS WILL BE SECURED WITH OWNER PROVIDED BASES. 5. REFER TO MECHANICAL AND ELECTRICAL SHEETS FOR ADDITIONAL EQUIPMENT SCHEDULE AND INFORMATION.


BKJ, Inc., Architecture 1621 Physicians Dr. Tallahassee, Florida 32308 (P) 850.778.8007 [(F) 850.546.6150 www.bkjarchitecture.com FL Architecture Corporation AA26002280	
FSU BIOLOGY UNIT 1 BSIR 1st Floor Remodel FSU PROJECT NO. FS 2200192	
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Equipment Plan SHEET NO.: A1.2 DATE: May 24, 2023	

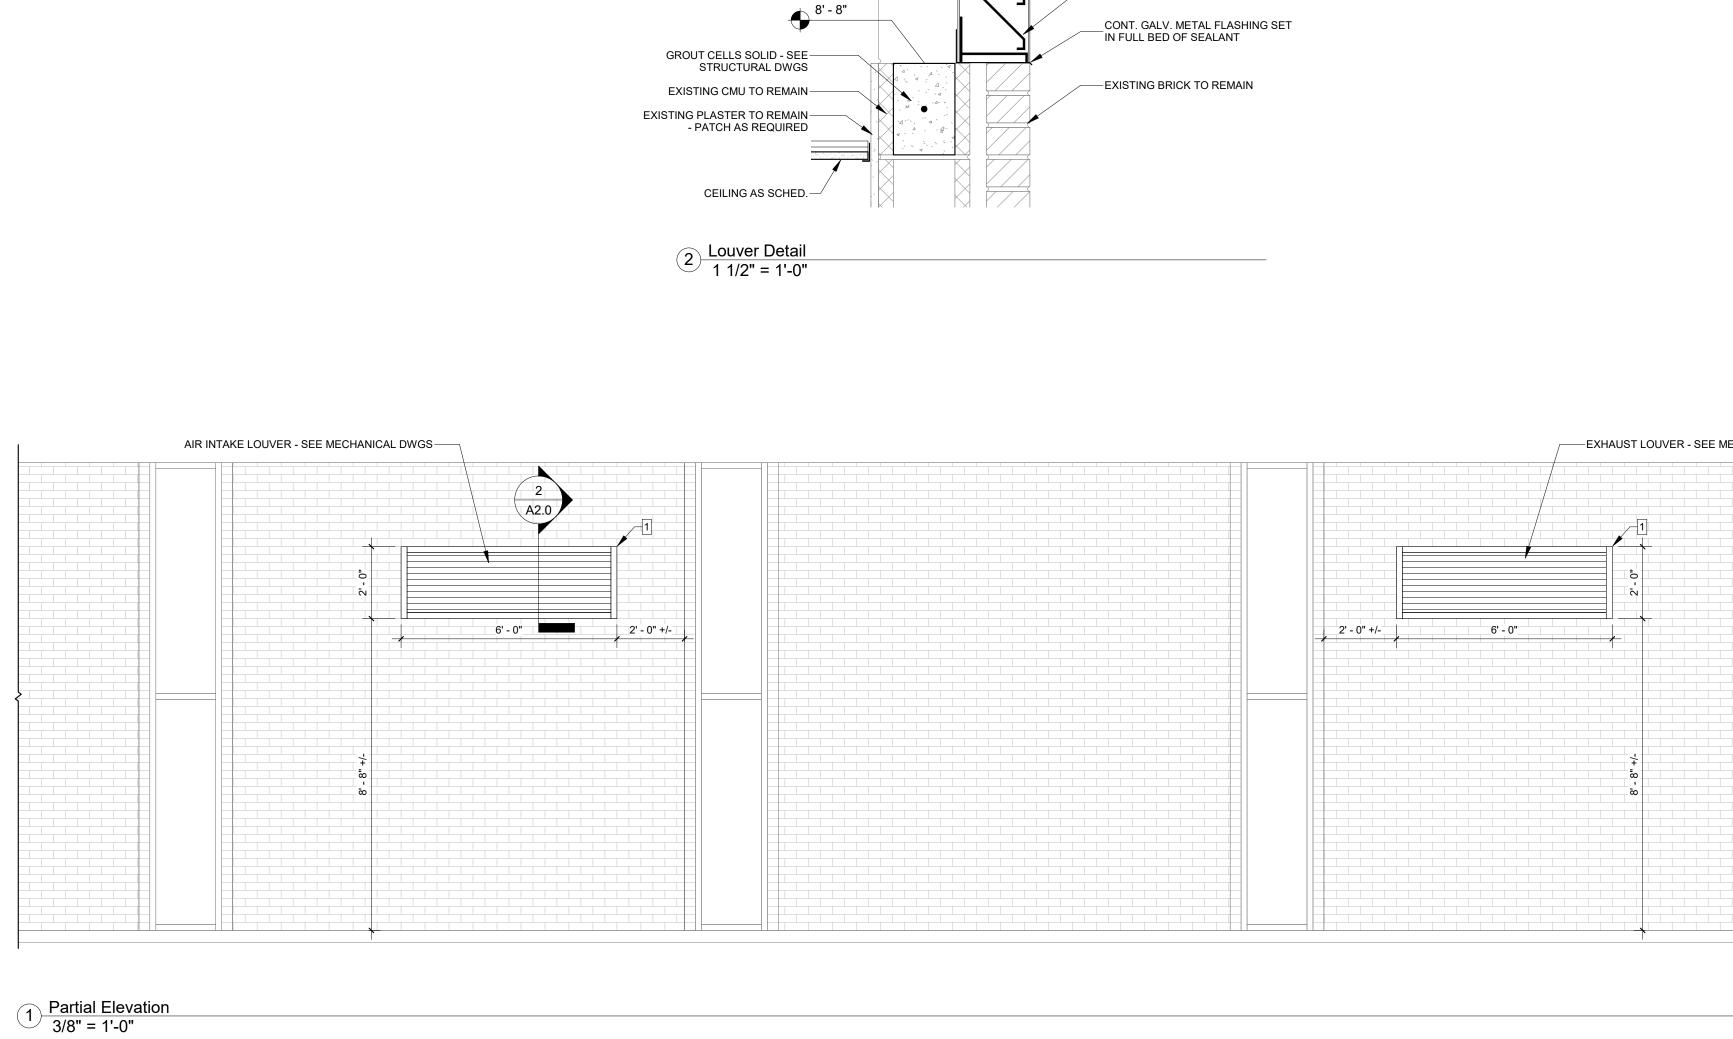

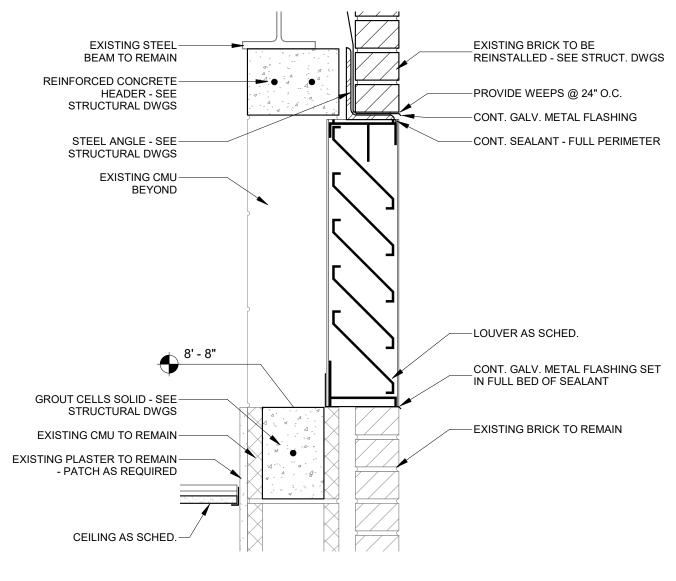


		ARCHITECT BKJ, Inc., Arc 1621 Physic Tallahassee, Fic (P) 850.778.8007 [(www.bkjarchite FL Architecture Corpor SEAL:	chitecture ians Dr. orida 32308 F) 850.546.6150 scture.com
		PROJECT TIT	
Elevation Keynot 1 Align OPENING WITH HREFER TO STRUCTURA	IORIZONTAL AND VERTICAL BRICK COURSING.	BIOLOGY UNIT 1 1st Floor Remodel	JECT NO. FS 22001
	2nd Floor 13' - 0"	JOB NO.: 22. JOB NO.: 22. DESIGNED: E DRAWN: JH CHECKED: BI THIS DRAWING AND AN ARE THE PROPERTY OF BKJ, INC. AND REPRODUCED, PUBLISH MANNER WITHOU PERMISSION OF TH	120 3D/JH D Y REPRODUCTIONS AND COPYRIGHT MAY NOT BE ED, OR USED IN ANY UT WRITTEN
		REVISIONS:	
		DRAWING P 100% Cons Docum DRAWING T Partial Bu Elevat	ents ITLE:
		SHEET NO.:	
		A2 . DATE: May 24,	

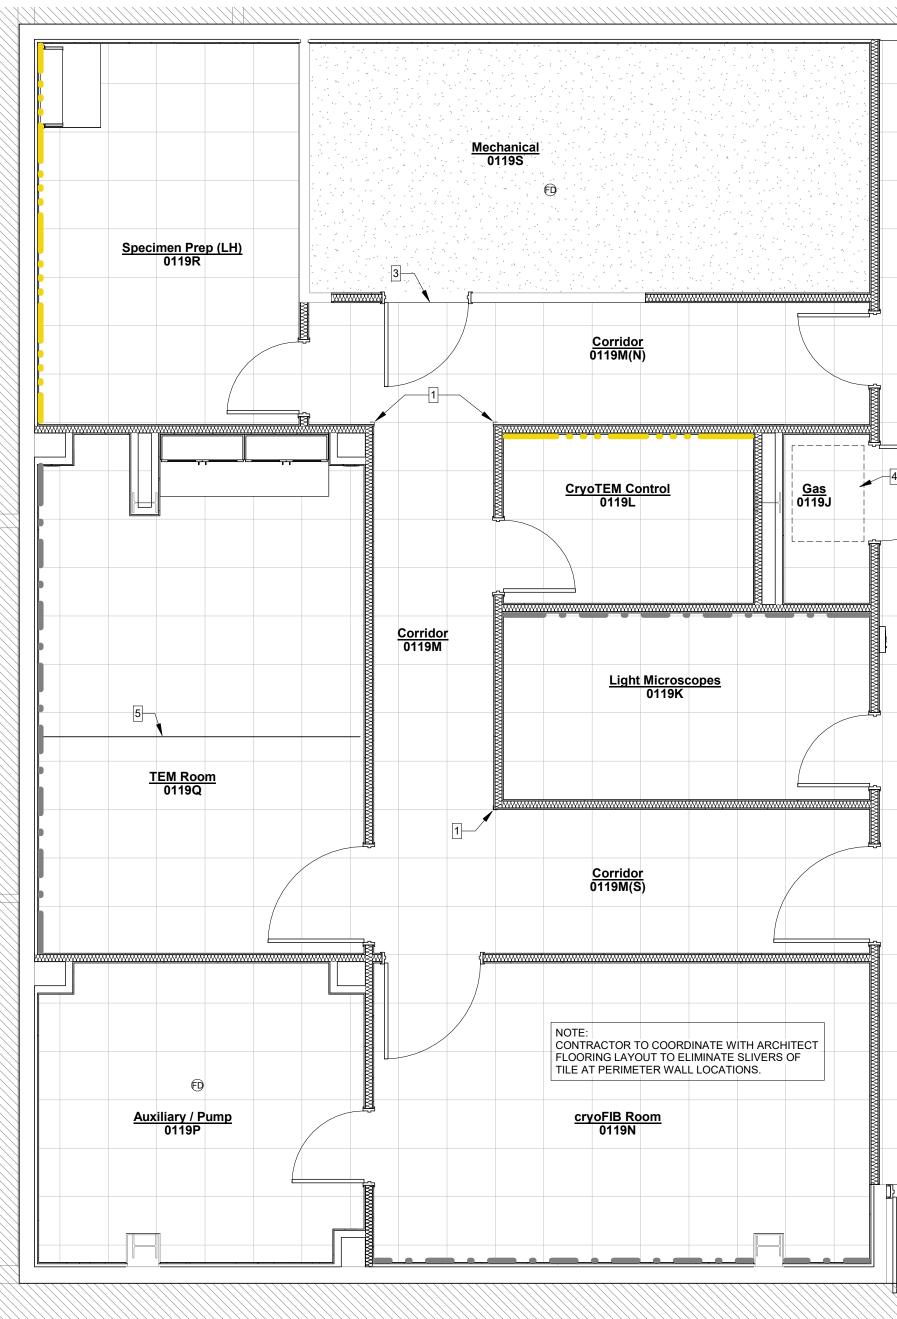

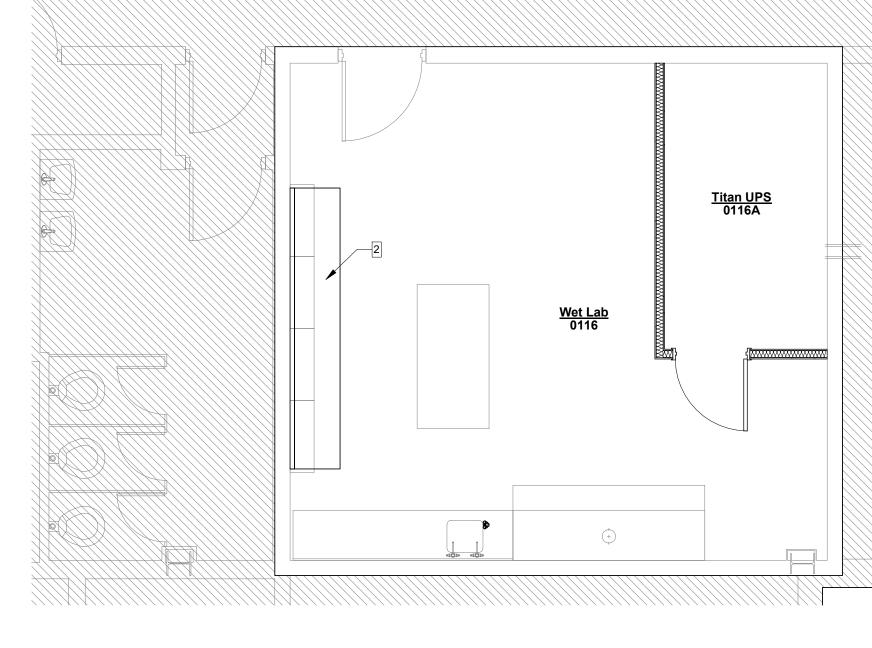

 $1 \frac{\text{Floor Plan - Finish Plan}}{1/4" = 1'-0"}$

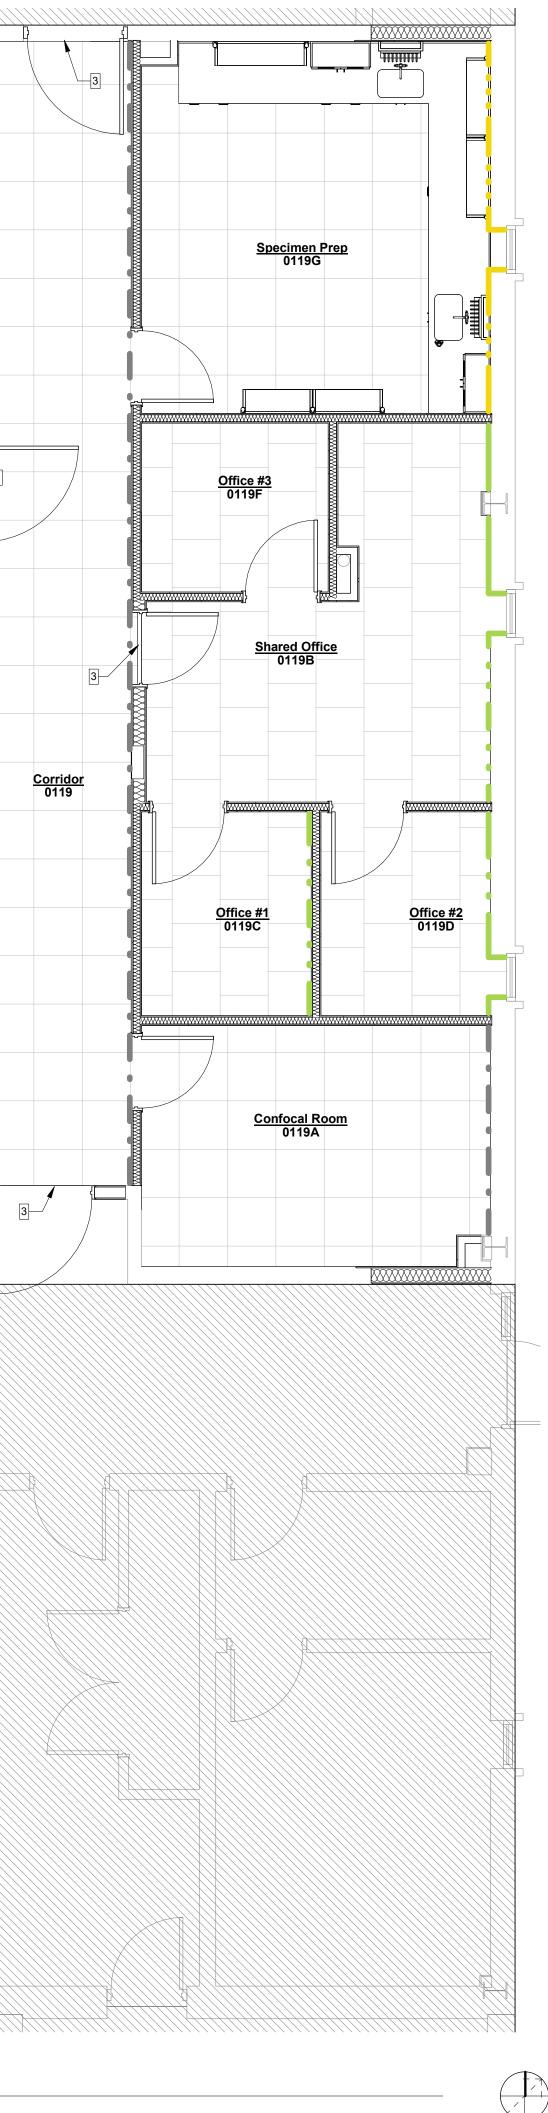

				Fir	nish Schedule)				
Number	Name	Base Finish	Floor Finish	North Wall	East Wall	South Wall	West Wall	Ceiling Finish	Ceiling Height	Notes
0116	Wet Lab	EX	EX	W1	W1	W1	W1	EX	EX	1, 2, 3
0116A	Titan UPS	WB1	EX	W1	W1	W1	W1	ACT1	8' - 0"	3
0119	Corridor	WB1	SD1	W1	W2	W1	W1	ACT1	8' - 4"	
0119A	Confocal Room	WB1	SD1	W1	W4	W1	W1	ACT1	8' - 0"	
0119B	Shared Office	WB2	CPT1	W1	W2	W1	W1	ACT1	8' - 0"	
0119C	Office #1	WB2	CPT1	W1	W3	W1	W1	ACT1	8' - 0"	
0119D	Office #2	WB2	CPT1	W1	W3	W1	W1	ACT1	8' - 0"	
0119F	Office #3	WB2	CPT1	W1	W1	W1	W3	ACT1	8' - 0"	
0119G	Specimen Prep	WB1	SD1	W1	W4	W1	W1	ACT1	8' - 0"	
0119J	Gas	WB1	SD1	W1	W1	W1	W1	ACT1	8' - 0"	
0119K	Light Microscopes	WB1	SD1	W2	W1	W1	W1	ACT1	8' - 0"	
0119L	CryoTEM Control	WB1	SD1	W4	W1	W1	W1	ACT1	8' - 0"	
0119M	Corridor	WB1	SD1	W1	W1	W1	W1	ACT1	8' - 4"	
0119M(N)	Corridor	WB1	SD1	W1	W1	W1	W1	ACT1	8' - 4"	
0119M(S)	Corridor	WB1	SD1	W1	W1	W1	W1	ACT1	8' - 4"	
0119N	cryoFIB Room	WB1	SD1	W1	W1	W2	W1	ACT1	8' - 0" / 9' - 10-1/2"	
0119P	Auxiliary / Pump	WB1	SD1	W1	W1	W1	W1	ACT1	8' - 0"	
0119Q	TEM Room	WB1	SD1	W1	W1	W1	W2	ACT2	9' - 2-1/2"	
0119R	Specimen Prep (LH)	WB1	SD1	W1	W1	W1	W4	ACT1	8' - 0"	
0119S	Mechanical	WB1	SC	W1	W1	W1	W1	OTS	EX	

Finish Schedule Notes:

1. REPLACE DAMAGED ACT AS NEEDED. 2. MATCH EXISTING WALL BASE. 3. PATCH TO MATCH EXISTING VCT.


Interior Finish Schedule Legend:

<u>FLOORS:</u> SD1 - CPT1 - SC - EX -	STATIC DISSIPATIVE FLOOR TILE, FORBO FLOORING, COLOREX S CARPET TILE, MANNINGTON COMMERCIAL, COLLECTION: CONNE SEALED CONCRETE EXISTING TO REMAIN AND/OR MATCH EXISTING
<u>WALL BASE:</u> WB1 - WB2 - EX -	4" RESILIENT BASE, FORBO FLOORING, STYLE: COVE, COLOR: C3 4" RESILIENT BASE, MANNINGTON COMMERCIAL, COLLECTION: B EXISTING TO REMAIN AND/OR MATCH EXISTING
<u>WALLS:</u> W1 - W2 - W3 - W4 - EX -	GYPSUM BOARD, PAINTED PT1 GYPSUM BOARD, PAINTED PT2 GYPSUM BOARD, PAINTED PT3 GYPSUM BOARD, PAINTED PT4 EXISTING TO REMAIN AND/OR MATCH EXISTING
<u>CEILING:</u> ACT1 - ACT2 - OTS - EX -	ACOUSTICAL CEILING TILE, ARMSTRONG OPTIMA TEGULAR, 24"x2 ACOUSTICAL CEILING TILE, SONEX CONTOUR CEILING TILE, 24"x2 OPEN TO STRUCTURE EXISTING TO REMAIN AND/OR MATCH EXISTING
<u>PAINT:</u> PT1 - PT2 - PT3 - PT4 - PT5 -	FIELD COLOR: PPG, COLOR: ARIA 1001-2 ACCENT COLOR: PPG, COLOR: FLAGSTONE 1001-4 ACCENT COLOR: PPG, COLOR: HOPSCOTCH 1219-6 ACCENT COLOR: PPG, COLOR: VAVAVOOM 1210-6 HM FRAMES: PPG, DOVER GRAY 1001-5

<u>SOLID SURFACE:</u> SS1 - KEWAUNEE, KEMRESIN EPOXY RESIN, 1" THICK, GREY (LAB SINKS TO MATCH COUNTERTOP)

<u>DOORS:</u> D1 -MASONITE ARCHITECTURAL, RED OAK, HONEY STAIN

Finish Plan Legend:

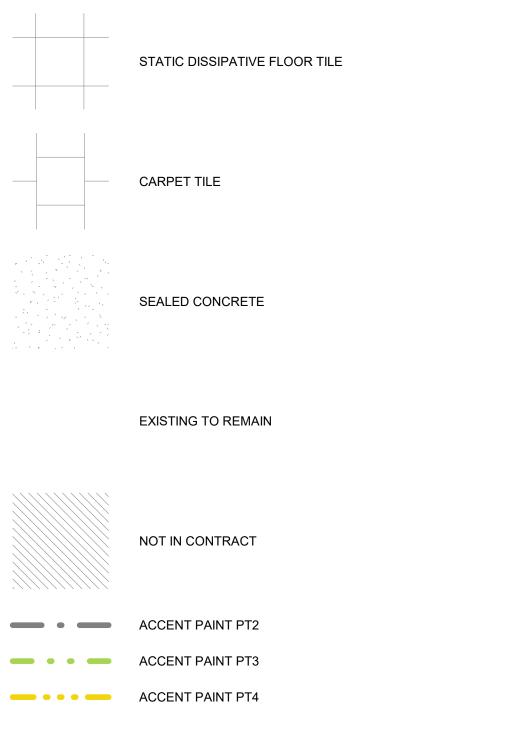

X SD, 615mm x 615mm, COLOR: MOONSTONE NECTED, OFFLINE, 24"x24", COLOR: DISCLOSE 13210

C33 NICKEL I: BURKE, COLOR: ORE 628

"x24", ITEM 3251, WHITE, W/ 9/16" GRID "x24", WHITE, W/ 15/16" GRID

Finish Plan Keynotes:

- PROVIDE CORNER GUARD. REFER TO BASIS OF DESIGN BELOW. 1
- 2 NEW EPOXY COUNTERTOP ON REUSED BASE CABINET. COLOR AND THICKNESS TO MATCH EXISTING.
- 3 FLOOR TRANSITION. SEE DOOR DETAILS AND SCHEDULE.
- 4 FLOOR PROTECTIVE MAT BY OWNER.
- CEILING MOUNTED EMI SHIELD CURTAIN AND TRACK. REFER TO BASIS OF DESIGN BELOW. 5

BASIS OF DESIGN: EMI SHIELD CURTAIN, DOUBLE LAYER CONSTRUCTION w/ GROMMETS EVERY 12", 15'-0" (L) x 8'-11 1/2"(H), SINGLE SECTION, GREY, CHAIN/CABLE MOUNT, TROLLEY TRACK, NYLON ROLLER CURTAIN HOOKS (1"), PROVIDE END STOPS EACH END MANUFACTURER: AKON CURTAIN AND DIVIDER WWW.CURTAIN-AND-DIVIDER.COM 989-414-1209

BASIS OF DESIGN: CORNER GUARD, VA SERIES, ACROVYN CORNER GUARD, MODEL: VA-200N, 1-1/2"x1-1/2", 90° ANGLE, COLOR: FOG 265 MANUFACTURER: CONSTRUCTION SPECIALTIES WWW.C-SGROUP.COM 800-233-8493


BKJ, Inc., Architecture 1621 Physicians Dr. Talahassee, Florida 32088 (P 850.778.8007] (F) 850.546.6150 www.bkjarchitecture.com T Architecture Corporation AA26002280
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May 24, 2023


							Do	or Sched	ule							
Number	Elevation	Width	Height	Thickness	Material	Finish	Frame Elevation	Head	Jamb	Thr.	Frame Material	Frame Finish	Hardware Set	Fire Rating	Signage Type	Notes
)116A	A	3' - 0"	7' - 0"	1 3/4"	WD	ST	HM1	1/A6.1	2/A6.1	3/A6.1	HM	PT5	HW5		A	
119-1	B	4' - 0"	8' - 0"	1 3/4"	WD	ST	HM1	1/A6.1	2/A6.1	4/A6.1	HM	PT5	HW1		A	2, 3
119-2	В	4' - 0"	7' - 0"	1 3/4"	WD	ST	HM2	6/A6.1	7/A6.1	5/A6.1	HM	PT5	HW1		A	3
119A	A	3' - 0"	7' - 0"	1 3/4"	WD	ST	HM1	1/A6.1	2/A6.1	8/A6.1	HM	PT5	HW2		A	1
119B	В	3' - 0"	7' - 0"	1 3/4"	WD	ST	HM1	1/A6.1	2/A6.1	4/A6.1	HM	PT5	HW2		A	3
119C	В	3' - 0"	7' - 0"	1 3/4"	WD	ST	HM1	1/A6.1	2/A6.1	3/A6.1	HM	PT5	HW4		В	
119D	В	3' - 0"	7' - 0"	1 3/4"	WD	ST	HM1	1/A6.1	2/A6.1	3/A6.1	HM	PT5	HW4		В	
119F	В	3' - 0"	7' - 0"	1 3/4"	WD	ST	HM1	1/A6.1	2/A6.1	3/A6.1	HM	PT5	HW4		В	
119G	В	3' - 0"	7' - 0"	1 3/4"	WD	ST	HM1	1/A6.1	2/A6.1	3/A6.1	HM	PT5	HW2		A	
119J	A	4' - 0"	7' - 0"	1 3/4"	WD	ST	HM1	1/A6.1	2/A6.1	3/A6.1	HM	PT5	HW2		A	
119K	A	3' - 0"	7' - 0"	1 3/4"	WD	ST	HM1	1/A6.1	2/A6.1	8/A6.1	HM	PT5	HW2		A	1
119L	В	3' - 0"	7' - 0"	1 3/4"	WD	ST	HM1	1/A6.1	2/A6.1	3/A6.1	HM	PT5	HW2		A	
119M-1	В	4' - 0"	8' - 0"	1 3/4"	WD	ST	HM1	1/A6.1	2/A6.1	8/A6.1	HM	PT5	HW3		A	1
119M-2	В	3' - 0"	7' - 0"	1 3/4"	WD	ST	HM1	1/A6.1	2/A6.1	8/A6.1	HM	PT5	HW3		A	1
119N	A	4' - 0"	8' - 0"	1 3/4"	WD	ST	HM1	1/A6.1	2/A6.1	8/A6.1	HM	PT5	HW2		A	1
119P	A	3' - 0"	7' - 0"	1 3/4"	WD	ST	HM1	1/A6.1	2/A6.1	8/A6.1	HM	PT5	HW2		А	1
119Q	A	4' - 0"	8' - 0"	1 3/4"	WD	ST	HM1	1/A6.1	2/A6.1	8/A6.1	HM	PT5	HW2		A	1
119R	В	3' - 0"	7' - 0"	1 3/4"	WD	ST	HM1	1/A6.1	2/A6.1	3/A6.1	HM	PT5	HW2		A	
119S	A	3' - 6"	7' - 0"	1 3/4"	WD	ST	HM1	1/A6.1	2/A6.1	5/A6.1	HM	PT5	HW5		A	3


Signage Elevations



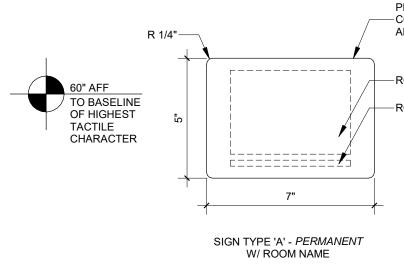


PLASTIC MOLDED SIGN —COLORS AND FONTS TO BE APPROVED BY ARCHITECT

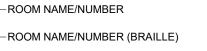


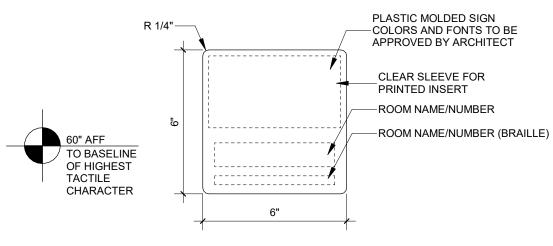



3 Signage Elevations 3" = 1'-0"

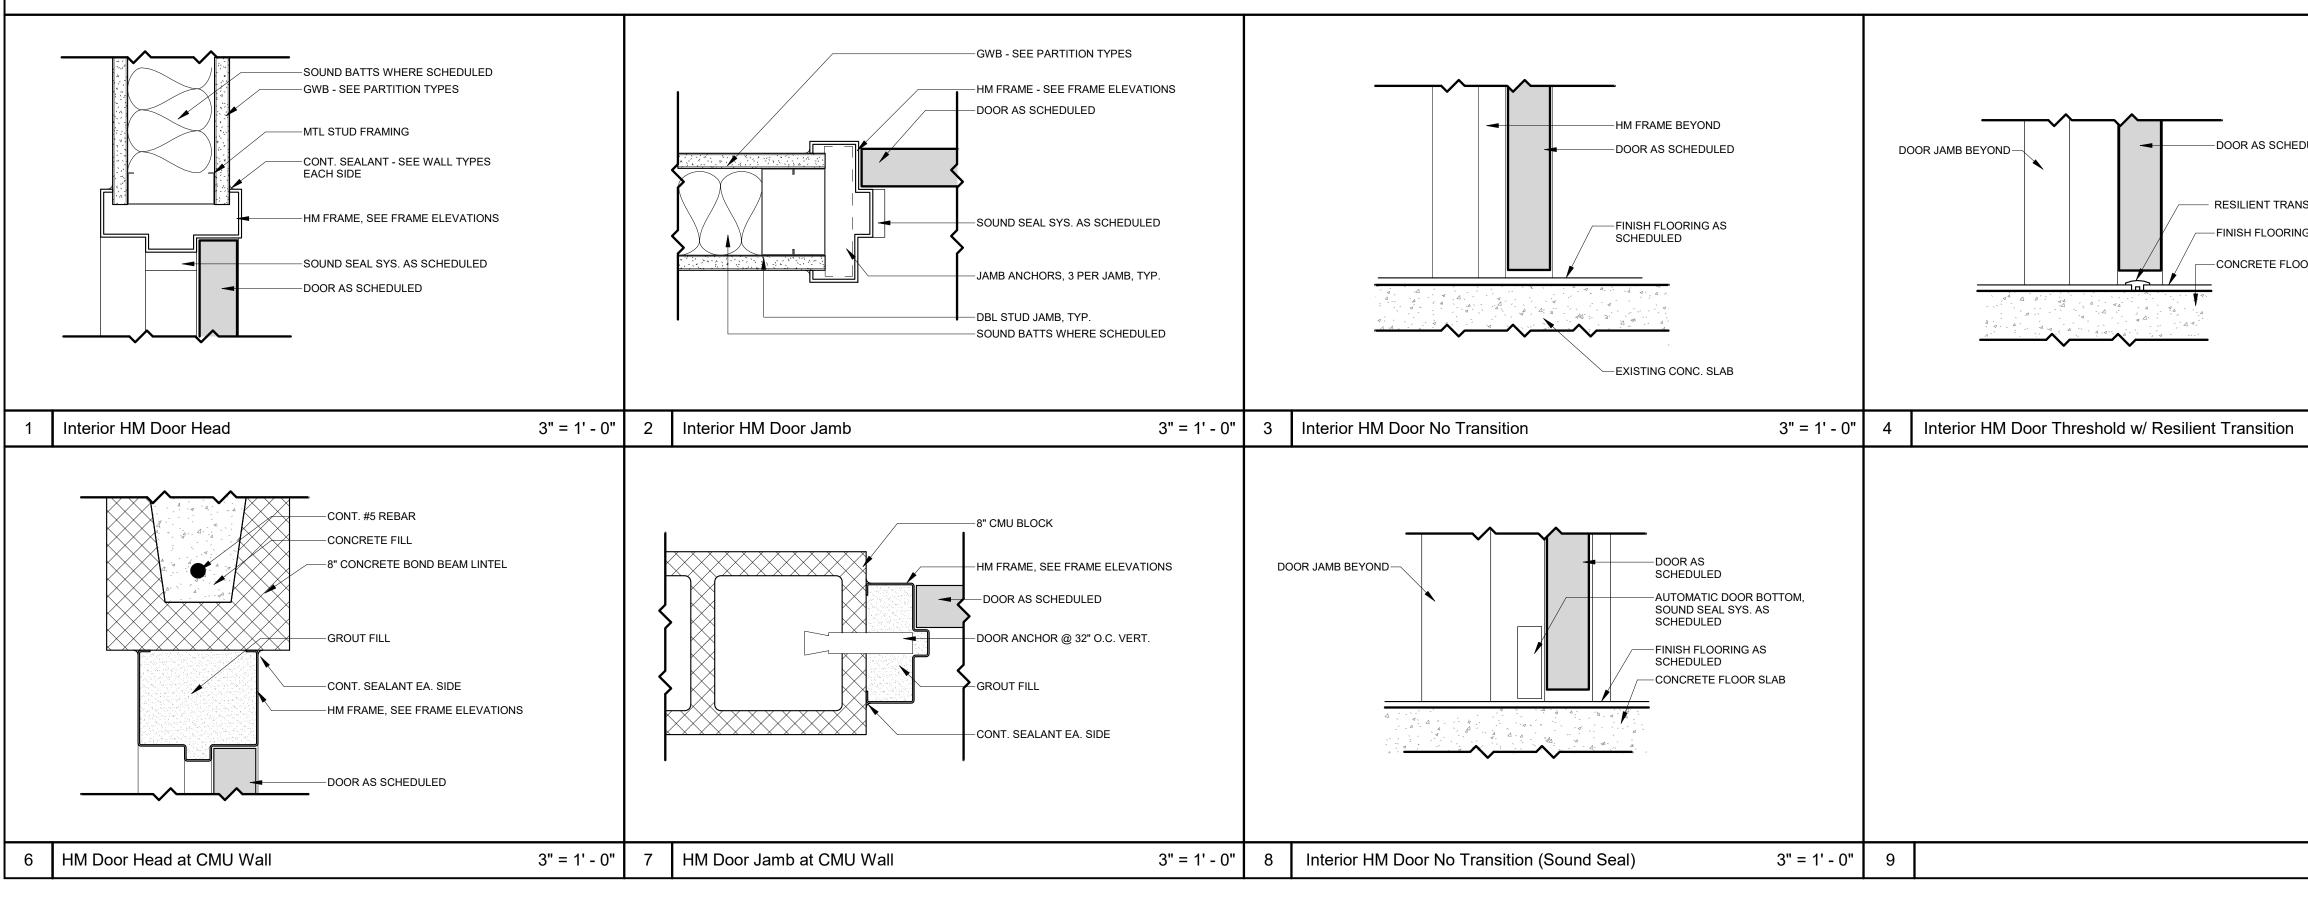


SIGN TYPE 'B' - CHANGEABLE

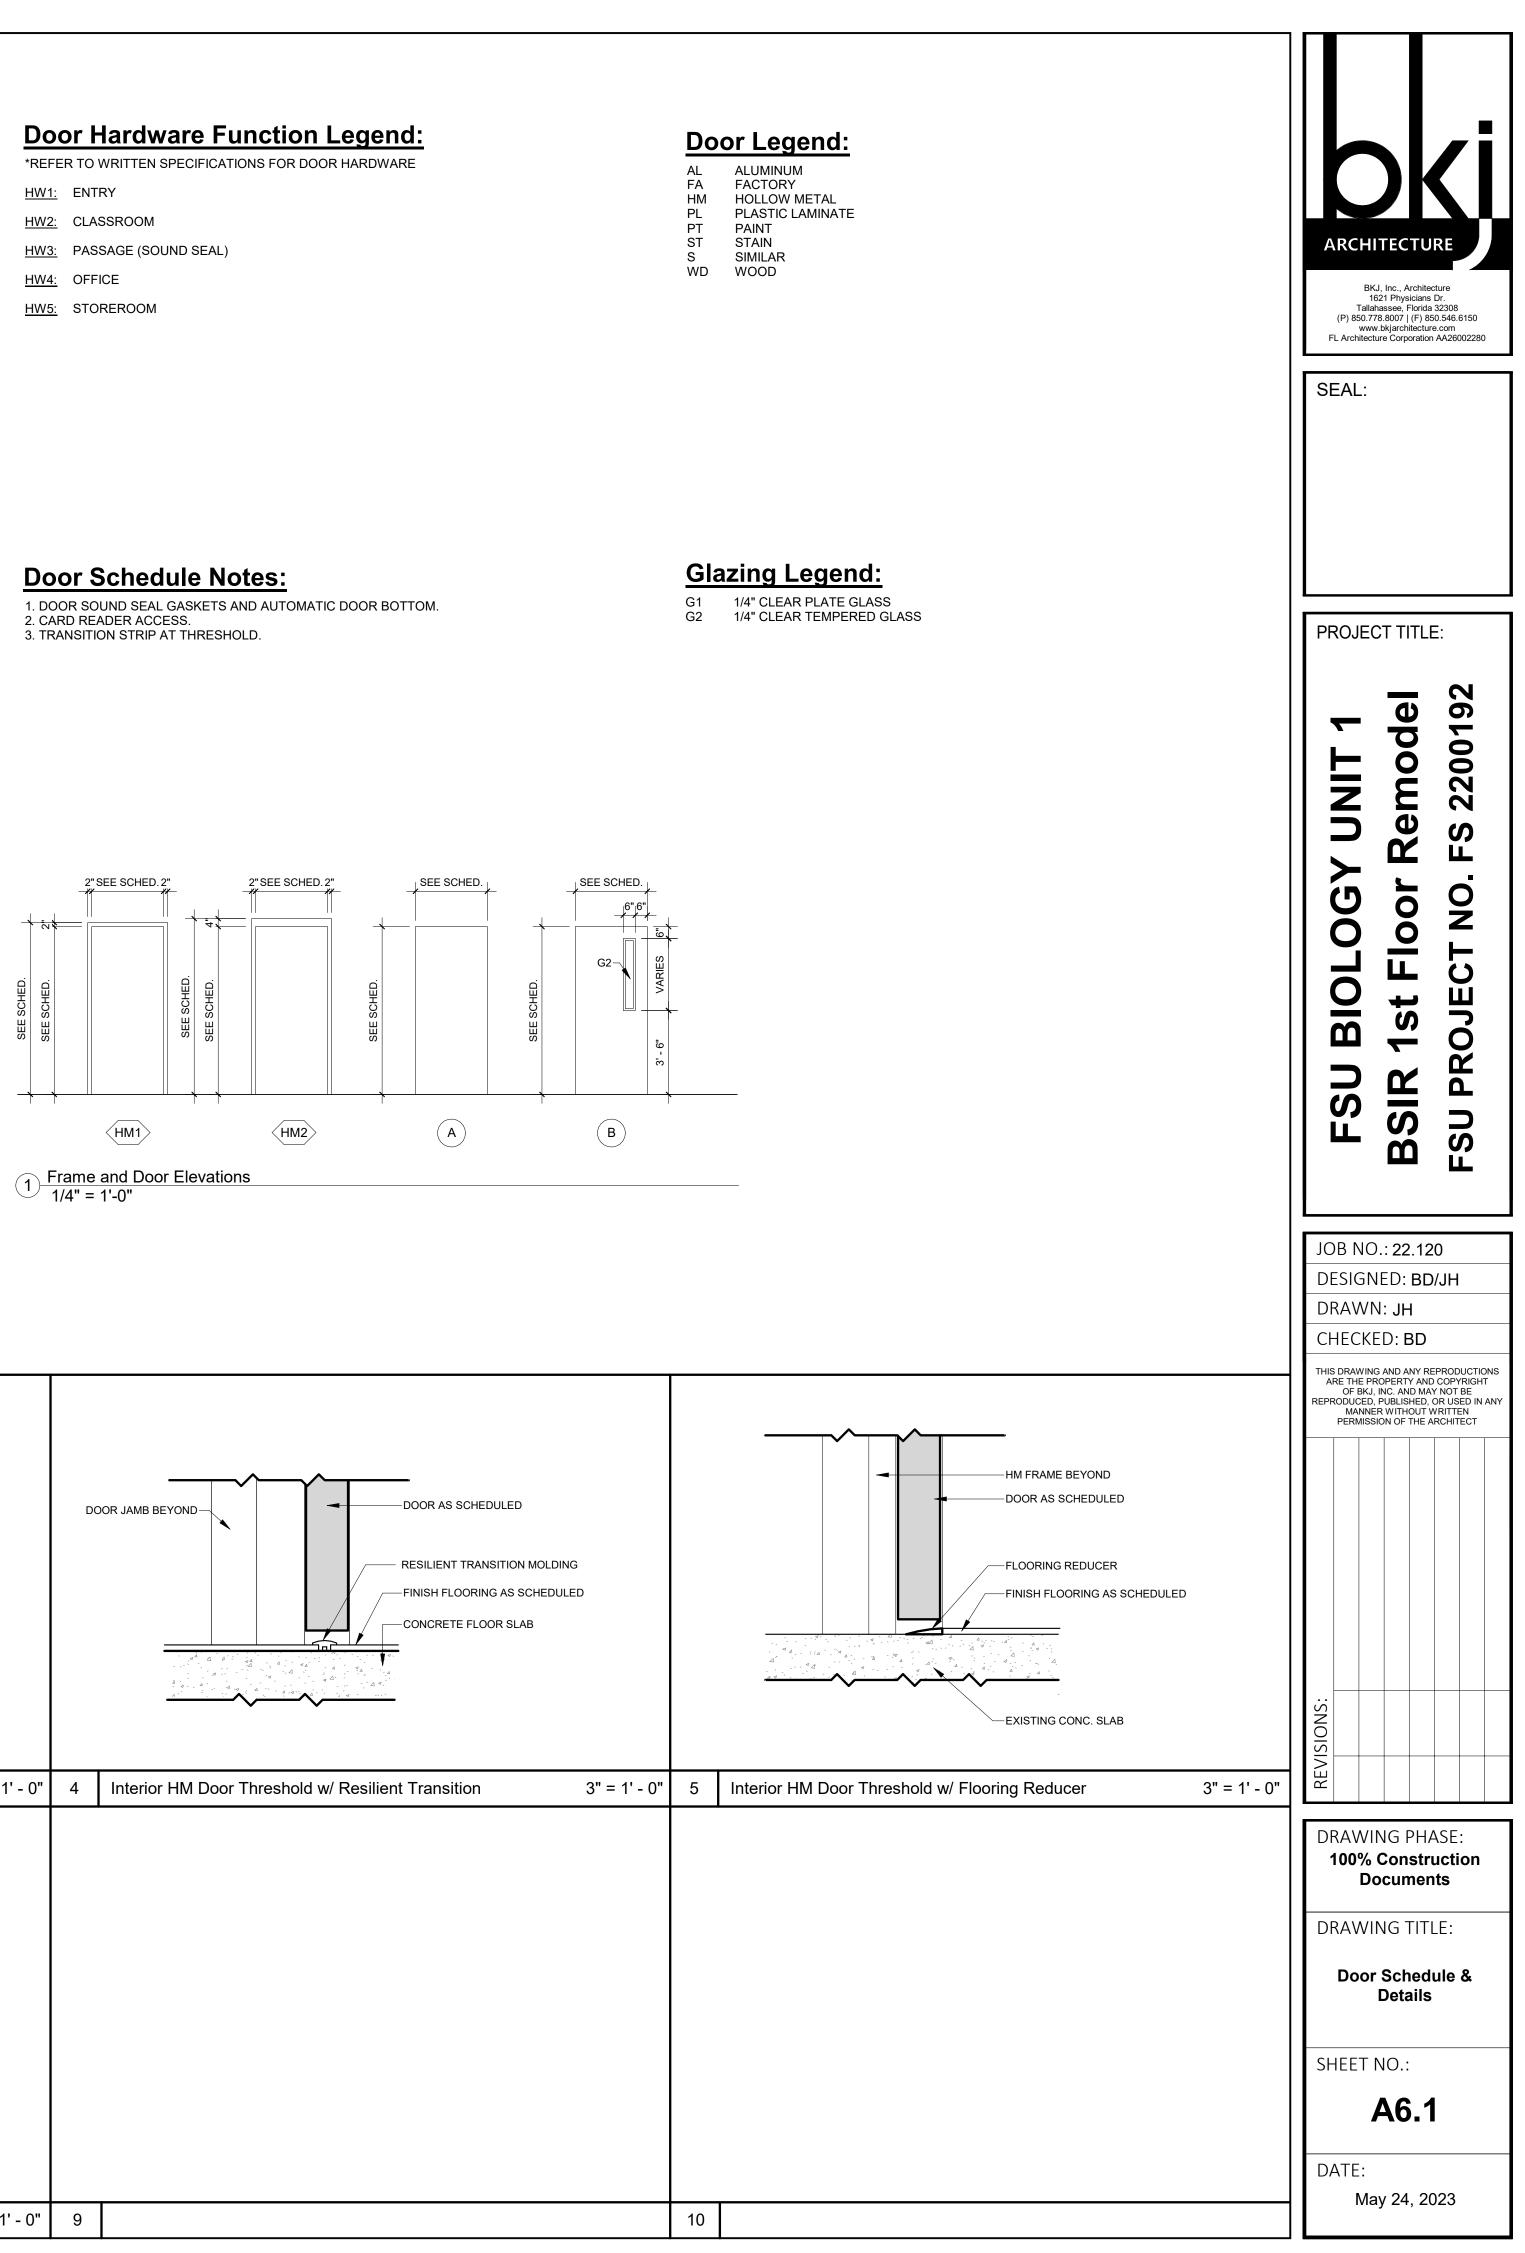

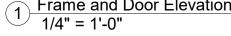

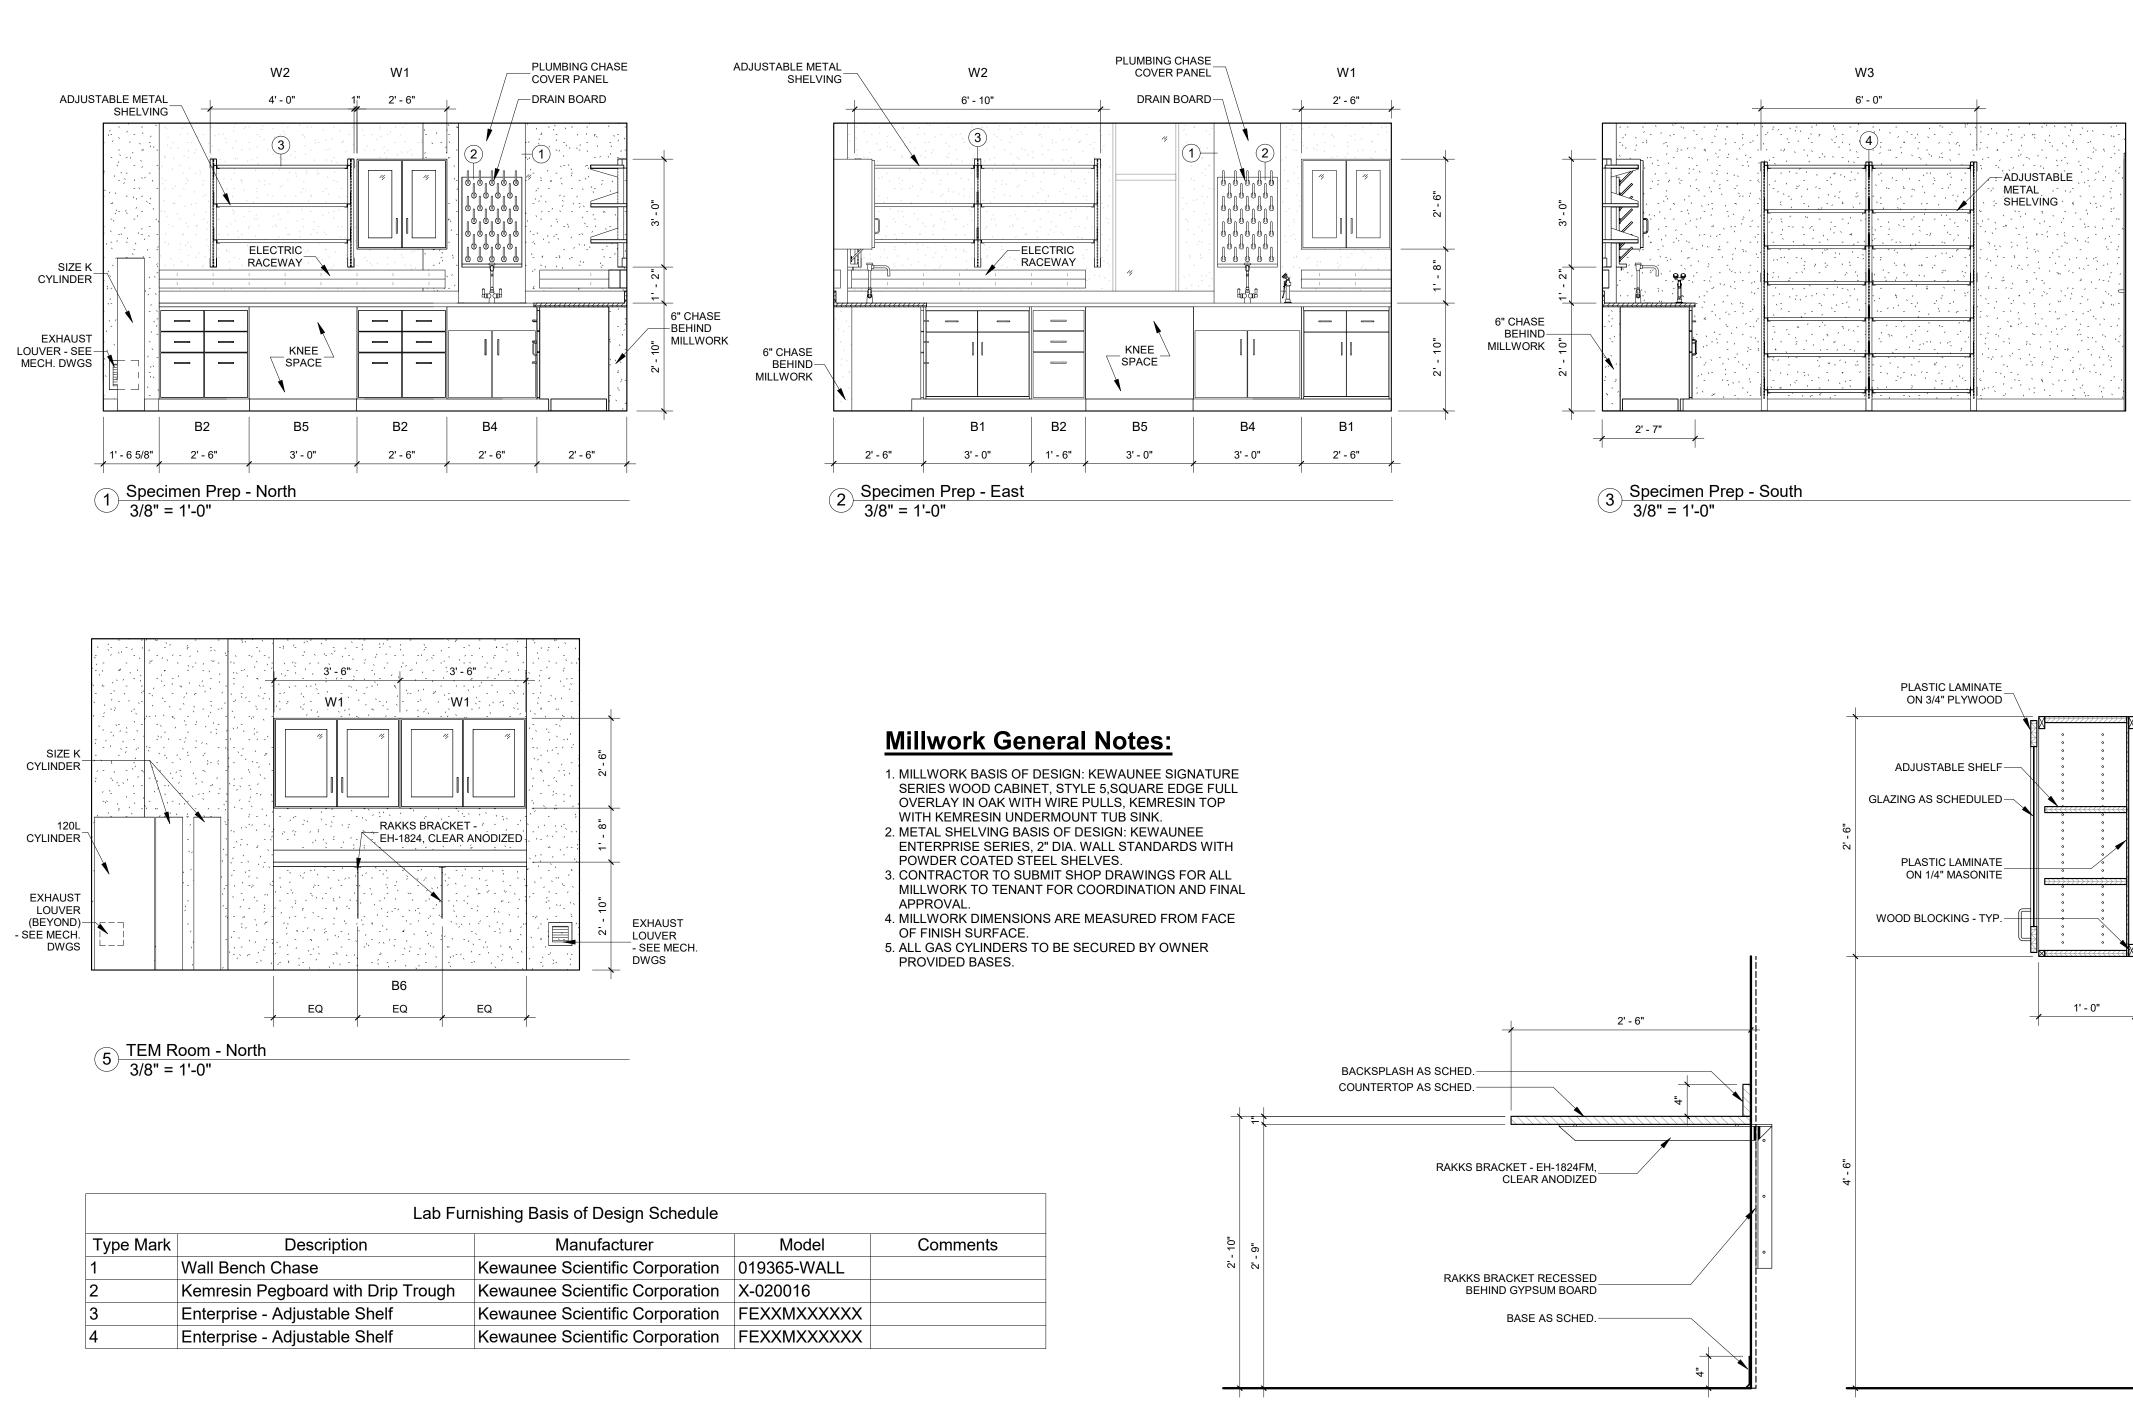

Type Mark	Description	Manufacturer	Model	Comments
1	Wall Bench Chase	Kewaunee Scientific Corporation	019365-WALL	
2	Kemresin Pegboard with Drip Trough	Kewaunee Scientific Corporation	X-020016	
3	Enterprise - Adjustable Shelf	Kewaunee Scientific Corporation	FEXXMXXXXXX	
4	Enterprise - Adjustable Shelf	Kewaunee Scientific Corporation	FEXXMXXXXXX	

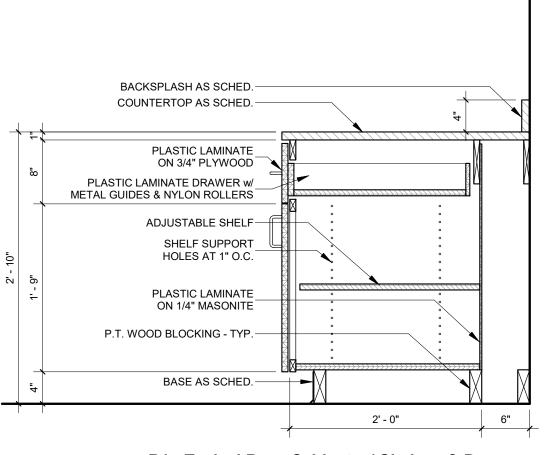

B1 - Typical Base Cabinet w/ Shelves & Drawer

B2 - Typical Base Cabinet w/ 3 Drawers

BACKSPLASH AS SCHED.-

COUNTERTOP AS SCHED.-

PLASTIC LAMINATE DRAWER w/___

METAL GUIDES & NYLON ROLLERS

PLASTIC LAMINATE

PLASTIC LAMINATE

ON 1/4" MASONITE


BASE AS SCHED.


P.T. WOOD BLOCKING - TYP.-

ON 3/4" PLYWOOD

6 Typical Millwork Sections 1" = 1'-0"



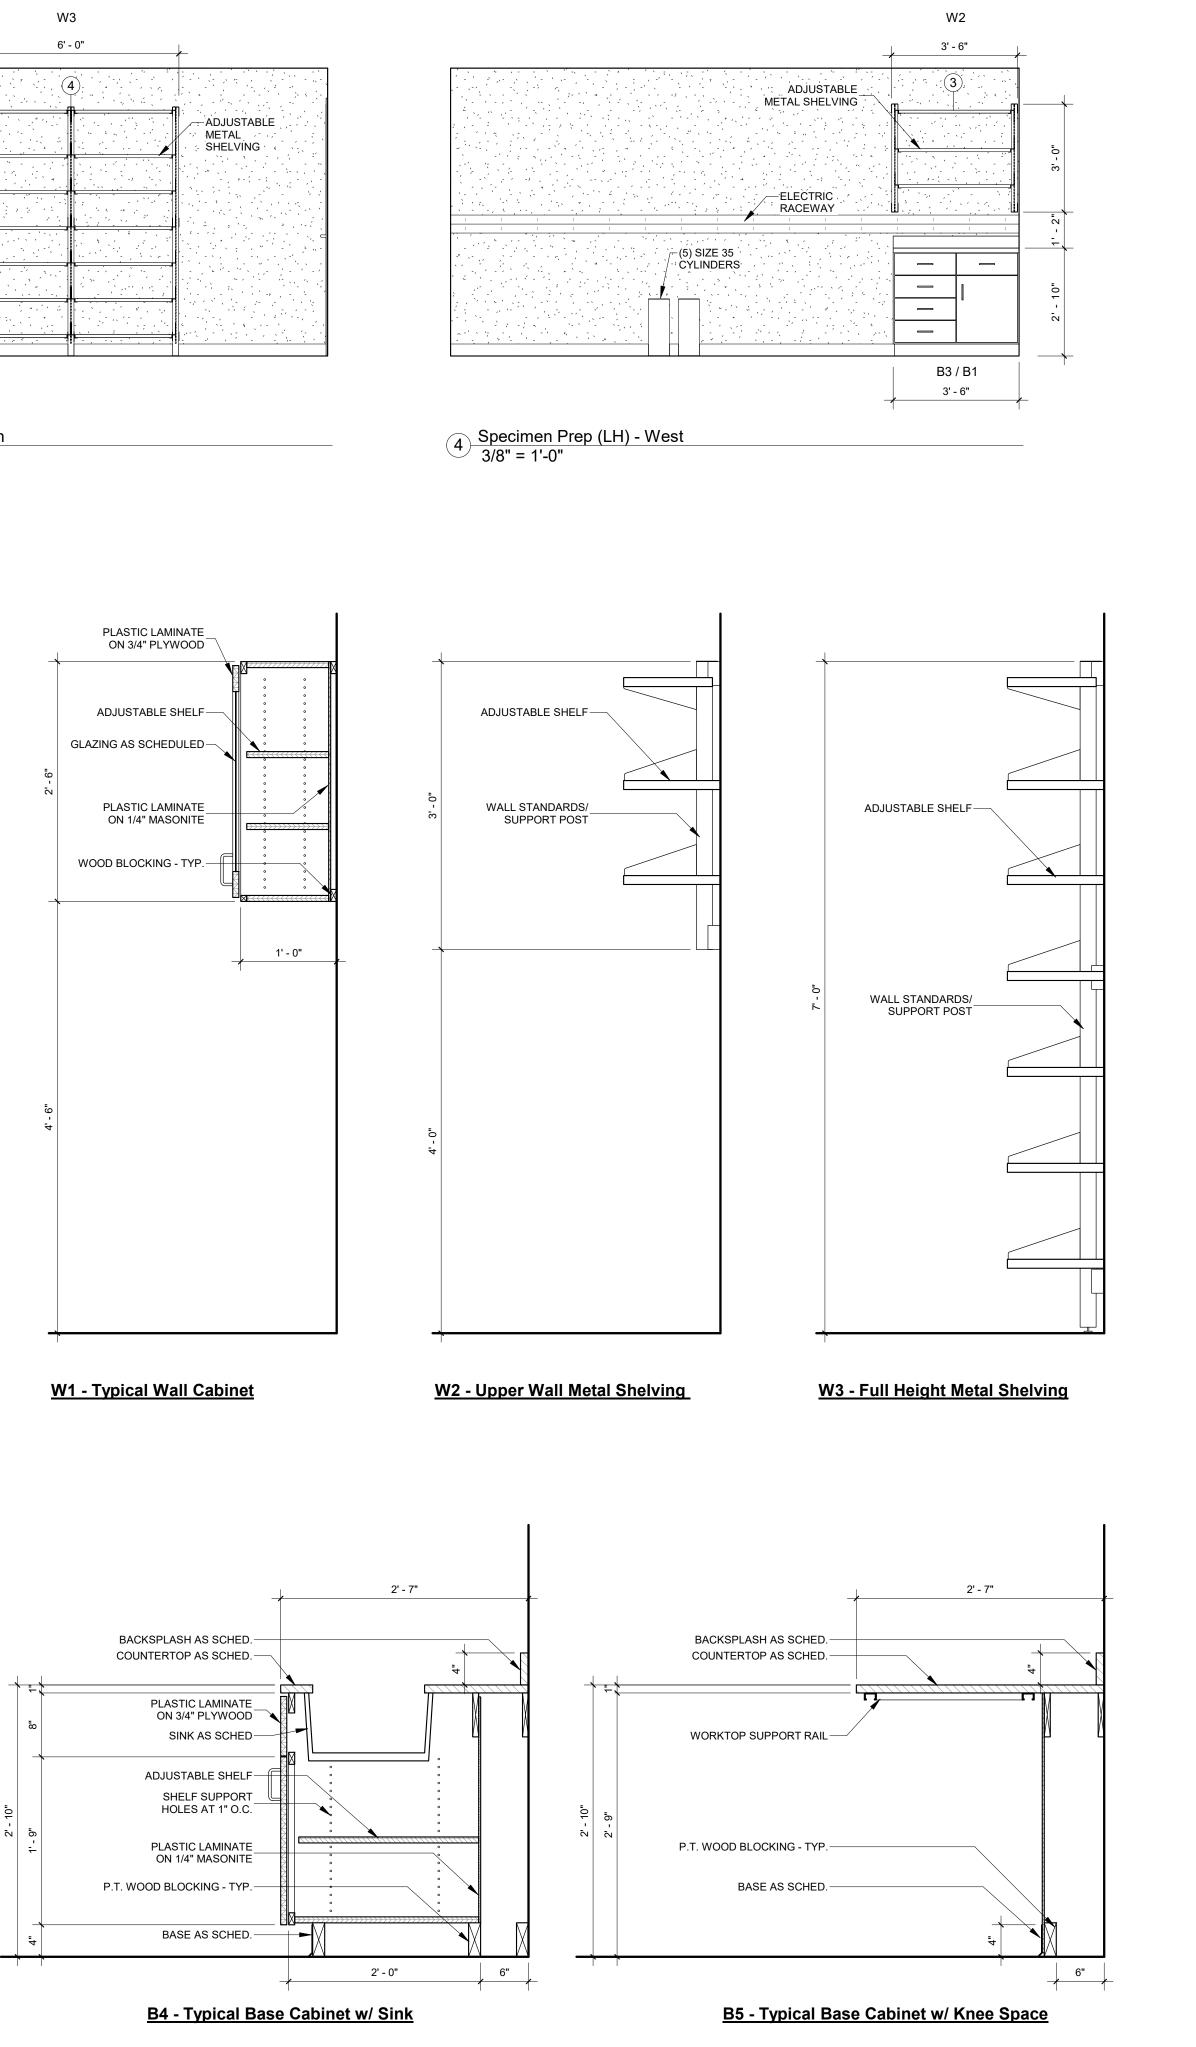

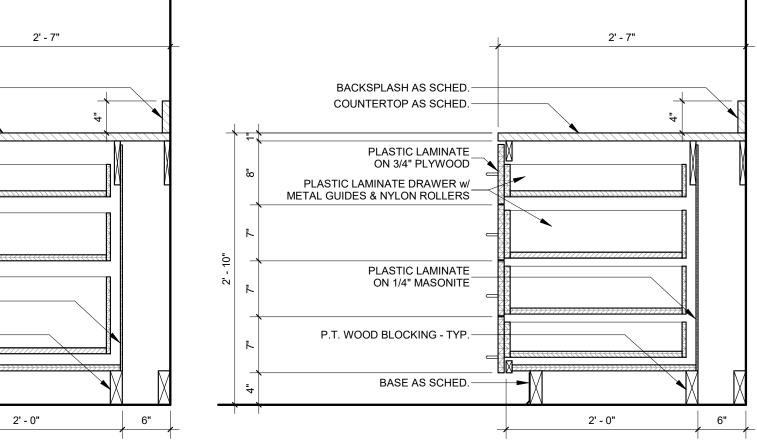

B3 - Typical Base Cabinet w/ 4 Drawers

