PLUMBING NOTES

GENERAL CONDITIONS

1. SEE SPECIFICATIONS FOR ADDITIONAL REQUIREMENTS.

STATE AND LOCAL CODES AND ORDINANCES

ALL FACTORS GOVERNING HIS WORK.

- 2. CONTRACTOR SHALL FURNISH ALL LABOR, MATERIALS, EQUIPMENT AND INCIDENTALS REQUIRED TO COMPLETE ALL WORK SHOWN ON THE CONTRACT DRAWINGS.
- 3. ALL CONSTRUCTION SHALL CONFORM TO APPLICABLE CODE STANDARDS INCLUDING:
 - FLORIDA BUILDING CODE, BUILDING, 8TH EDITION (2023) FLORIDA BUILDING CODE, PLUMBING, 8TH EDITION (2023)
 - FLORIDA BUILDING CODE, MECHANICAL, 8TH EDITION (2023)
 - FLORIDA BUILDING CODE, ENERGY CONSERVATION CODE, 8TH EDITION (2023) NFPA 70, NATIONAL ELECTRIC CODE (NEC) 2020 EDITION
- 4. THE BIDDERS SHALL INSPECT THE PRESENT JOB SITE CONDITIONS BEFORE PREPARING A BID. THE SUBMISSION OF A BID WILL BE CONSIDERED EVIDENCE THAT SUCH A VISIT AND INSPECTION WAS PERFORMED BY THE BIDDER AND THAT HE TAKES FULL RESPONSIBILITY FOR
- 5. THE CONTRACTOR IS EXPECTED TO PROVIDE PROFESSIONAL WORK PERFORMED IN ACCORDANCE WITH INDUSTRY STANDARDS AND GOOD PRACTICE. WORK SHALL CONFORM TO THE MANUFACTURER'S INSTRUCTIONS AND THE REQUIREMENTS OF THE LOCAL HEALTH DEPARTMENT.
- 6. THE CONTRACTORS ARE EXPECTED TO FIELD VERIFY ALL DIMENSIONS. CONTRACTORS ARE EXPECTED TO ACCOUNT FOR FIELD CONDITIONS. CONTRACTORS ARE EXPECTED TO COORDINATE IN ORDER TO AVOID INTERFERENCE BETWEEN TRADES. CONTRACTORS ARE EXPECTED TO INSTALL EQUIPMENT SUCH THAT PROPER MAINTENANCE CLEARANCES ARE MAINTAINED FOR EQUIPMENT OF ALL TRADES. IF CHANGES TO THE CONTRACT DOCUMENTS ARE NECESSARY TO AVOID CONFLICTS, THE CONTRACTOR IS RESPONSIBLE FOR REQUESTING CLARIFICATION IN A TIMELY FASHION. THE CONTRACTOR SHALL BE RESPONSIBLE FOR ANY DEFICIENCIES ASSOCIATED WITH WORK PERFORMED BEFORE OBTAINING CLARIFICATION.
- 7. UPON COMPLETION OF THE WORK THE CONTRACTOR SHALL CLEAN SPACES THAT WERE OCCUPIED BY TEMPORARY WORK AND TEMPORARY FACILITIES. REMOVE DEBRIS, RUBBISH AND EXCESS MATERIALS FROM THE SITES. REPAIR DAMAGES CAUSED BY INSTALLATION OR USE OF TEMPORARY FACILITIES.

GENERAL PLUMBING NOTES

- 1. PLUMBING PLANS ARE SCHEMATIC. LOCATE PIPING TO AVOID FIELD INTERFERENCES. CHANGES IN THE PIPING SCHEMATIC REQUIRE PRIOR APPROVAL OF THE ENGINEER.
- 2. TRANSITION CONNECTION BETWEEN SITE PIPING AND BUILDING PLUMBING SHALL OCCUR IN AN ACCESSIBLE GREEN SPACE.
- 3. THE CONTRACTOR IS EXPECTED TO VERIFY DIMENSIONS AND FIELD FABRICATE PIPING AS NECESSARY TO ACCOMMODATE CONDITIONS.
- 4. PRIOR TO ANY NEW WORK THE CONTRACTOR SHALL VERIFY BY ALL MEANS AVAILABLE THE DIRECTION OF FLOW OF ALL EXISTING PIPING THAT WILL BE TIED INTO FOR THE NEW WORK. REPORT TO THE ENGINEER ANY DIFFERENCES FROM WHAT THE CONTRACT DOCUMENTS SHOW.

MATERIALS AND DEVICES

- 1. ALL MATERIALS, EQUIPMENT AND APPARATUS COVERED BY THIS SPECIFICATION SHALL BE NEW, OF CURRENT MANUFACTURE.
- 2. SEE PROJECT SPECIFICATIONS FOR MATERIALS.
- 3. CONNECTION JOINTS BETWEEN PLASTIC AND METALLIC PIPE SHALL BE MADE WITH TRANSITION FITTING FOR THE SPECIFIC PURPOSE.
- 4. CONNECTIONS TO WATER HEATERS AND BETWEEN FERROUS AND NONFERROUS METALLIC PIPE SHALL BE MADE WITH DIELECTRIC FITTINGS.

PIPING NOTES

- 1. INSTALL GRAVITY LINES AT UNIFORM GRADES.
- 2. INSTALL SLEEVES AT ALL PENETRATIONS WHERE CONCRETE MIGHT CONTACT COPPER PIPING. PROVIDE SLEEVES AND SEAL ALL PENETRATIONS OF FULL HEIGHT WALLS AIR TIGHT. PROVIDE SLEEVES AT ALL PENETRATIONS OF FLOOR. PROVIDE POLY PIPE COVER OR INSULATION WHERE COPPER PIPING IS ENCASED WITHIN CMU WALLS.
- 3. LOCATE ALL VALVES AND OTHER DEVICES WHICH REQUIRE MAINTENANCE IN ACCESSIBLE LOCATIONS. PROVIDE ACCESS PANELS IF NECESSARY.
- 4. PIPING INSTALLATIONS ARE EXPECTED TO BE RIGID. SUPPORT AND SECURE PIPING IN ACCORDANCE WITH GOOD PRACTICE.
- 5. SEE SPECIFICATIONS FOR HOT WATER PIPING INSULATION REQUIREMENTS. PROFESSIONAL INSTALLATION IS EXPECTED.
- 6. LABEL ALL HOT, TEMPERED & COLD DOMESTIC WATER SUPPLY & RETURN PIPING AT EACH VALVE LOCATION & NO LESS THAN 20' O.C.
- 7. HOT WATER PIPE INSULATION SHALL BE RIGID GLASS FIBER INSULATION WITH A NOMINAL DENSITY OF 3 POUNDS PER CUBIC FOOT WITH A THERMAL CONDUCTIVITY BETWEEN 0.21 AND 0.28 AT 100 DEG F MEAN TEMPERATURE. INSULATION COVER SHALL BE AN ALL SERVICE JACKET WITH DOUBLE SELF-SEALING LAPS, WITH SELF-SEALING BUTT STRIPS. INSULATION THICKNESS SHALL BE ONE INCH (1") THICK FOR PIPE SIZES 3/4" TO 1-1/2", AND (1-1/2") THICK FOR PIPE SIZES 1-1/2" TO 4" PER FBC-PLUMBING 607.5 AND FBC-ENERGY CONSERVATION TABLE C403.2.10.

FIXTURES AND TRIM:


- 1. EQUIPMENT SHALL BE UNDAMAGED AND CLEANED.
- 2. ALL EXPOSED SINK AND LAVATORY DRAIN PIPING SHALL BE CHROME PLATED BRASS NO LESS THAN 17 GAUGE. TRAPS SHALL BE 17 GAUGE FULLY CAST BRASS WITH CLEANOUT PLUGS.
- 3. ESCUTCHEONS SHALL BE CHROME PLATED CAST BRASS WITH SET SCREW.

CLOSEOUT, TESTING AND INSPECTIONS

- COORDINATE INSPECTIONS WITH THE SPECIFICATIONS.
- 2. ALL DOMESTIC WATER PIPING SHALL BE STERILIZED IN ACCORDANCE WITH THE PROCEDURE OUTLINED IN THE FBC, PLUMBING CODE.
- 3. ALL WATER SUPPLY PIPING SHALL BE LEAK TESTED IN ACCORDANCE WITH THE FBC, PLUMBING CODE BUT NOT LESS THAN 100 PSI.
- 4. ALL WASTE AND VENT PIPING SHALL BE LEAK TESTED IN ACCORDANCE WITH THE FBC, PLUMBING CODE BUT NOT LESS THAN 10' OF HEAD.
- 5. CONTRACTOR SHALL CAMERA SEWER LINES AND PROVIDE SMOKE TEST OF THE ENTIRE WASTE AND VENT SYSTEM.
- NO PIPING SHALL BE COVERED OR CLOSED UP BEFORE INSPECTION AND APPROVAL. PROVIDE TEST TEES AT CONNECTION TO EXISTING AT EACH FLOOR & AS NEEDED FOR COMPLETE TESTING.

PLUMBING LEGEND EXISTING SANITARY PIPING ---- 1"V ----EXISTING VENT PIPING ----3"WM----EXISTING WM PIPING EXISTING CW PIPING —— - ½"CW - —— EXISTING PIPING/EQUIPMENT TO BE REMOVED OR DEMOLISHED SANITARY PIPING — · 4"S · — ---- 2"V ----VENT PIPING NATURAL GAS PIPING —— ¾"G —— CW PIPING — - ¾"CW - — CONDENSATE PIPING TRAP PRIMER LINE (½" U.N.O.) ____tp-___ ELBOW TURNED UP ELBOW TURNED DOWN TEE, OUTLET UP TEE, OUTLET DOWN BALL VALVE PRESSURE REGULATOR FIRE ALARM SHUT-OFF VALVE SWING CHECK VALVE

WATER HAMMER ARRESTER CONNECTION, NEW TO EXISTING LIMIT OF DEMOLITION

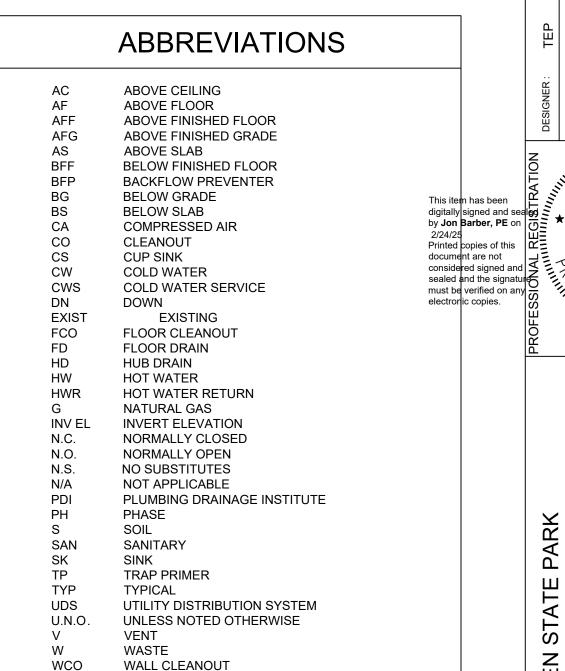

WM

XT

WATER MAIN

EXPANSION TANK

∑ LL Ш M. BARD No. 55427 STATE OF

LEGEND PARK STATE

IMPROVEMENT AND PLUMBING NOTES

SHEET NO.

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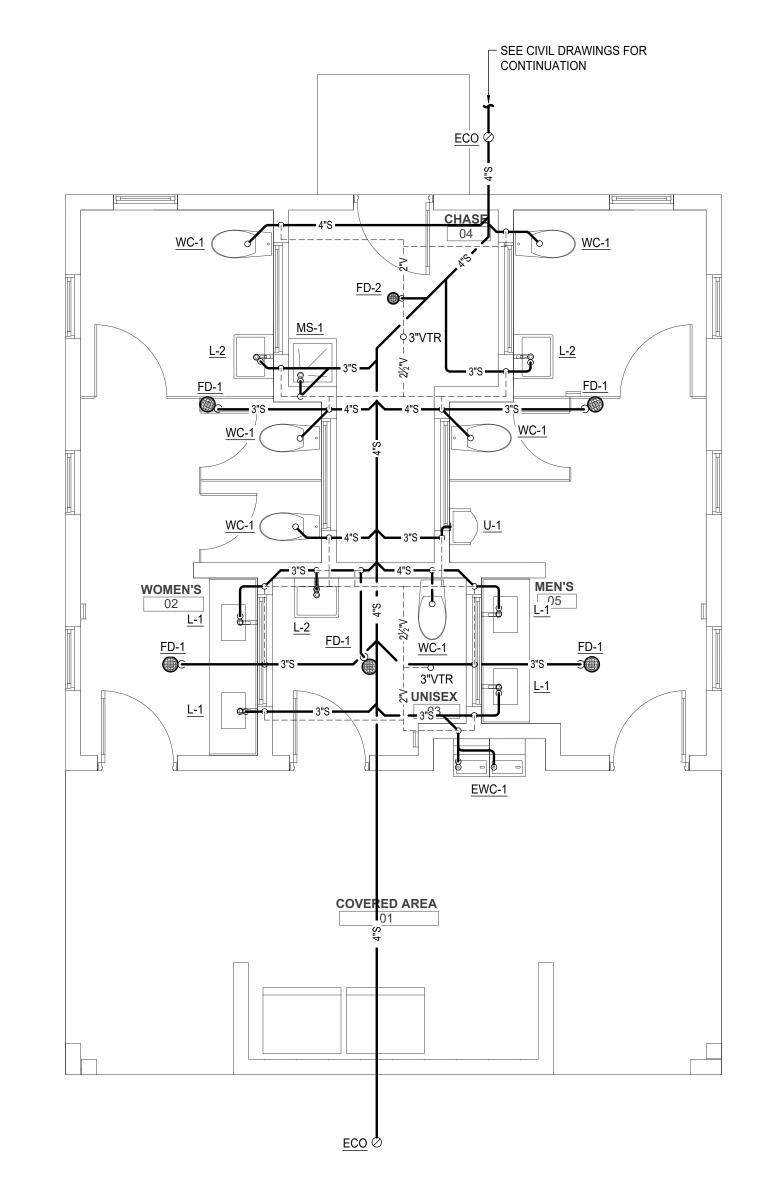
P100

	DRAIN S	CHEDULE	E (BASIS OF DESIGN)				
T)/DE	DECODIDATION	MODEL	TDIM A ACCEDOODIES	RE CONNECTIONS			
TYPE	DESCRIPTION	MODEL	TRIM & ACCESSORIES	CW	WASTE	VENT	
FD-1	STAINLESS STEEL ADJUSTABLE FLOOR DRAIN WITH ANCHOR FLANGE AND AUXILIARY TRAP PRIMER FITTING. ROUND TOP, MEDIUM DUTY.	ZURN Z1726	STAINLESS STEEL BODY W/ FLASHING COLLAR AND ADJUSTABLE 8" SQUARE STAINLESS STEEL STRAINER HEAD. PRECISION PLUMBING PRODUCTS PVC TRAP PRIMER FITTING WITH $1/2$ " NPT TAPPING.	1/2"	3"	2"	
FD-2	STAINLESS STEEL ADJUSTABLE FLOOR DRAIN WITH ANCHOR FLANGE. ROUND TOP, MEDIUM DUTY.	ZURN Z1726	STAINLESS STEEL BODY W/ FLASHING COLLAR AND ADJUSTABLE 7" ROUND STAINLESS STEEL STRAINER HEAD, STAINLESS STEEL SEDIMENT BUCKET. PROVIDE J.R. SMITH 2692 TRAP SEAL IN LIEU OF TRAP PRIMER CONNECTION.		3"	2"	


	TANKLESS ELECTRIC WATER HEATER SCHEDULE									
TYPE	MANUFACTURE R/ MODEL NO.	TEMP. RISE @ GPM	MAXIMUM FLOW (GPM)	ACTIVATION GPM	KW	VOLTS/PH	AMPS	RECOMMENDED WIRE SIZE	NOTES	
EWH-1	EEMAX PRO08240	55°@1.0 36°@1.5	5.0	0.3	8.0	240 / 1	33.0	8 AWG	TANKLESS WATER HEATER TO BE MOUNTED VERTICALLY ON WALL ABOVE MOP SINK WITH THE HW OUTLET ON THE BOTTOM. ADJUSTABLE OUTLET TEMPERATURE SET TO 110°. PROVIDE W/ EEMAX INLINE FLOW REGULATOR. INSULATE ALL PIPE, CONNECTIONS, VALVES, AND FITTINGS.	

		REVISION	FIXTURE CONNECTIONS WASTE CW HW WASTE VENT IED FLUSH VALVE, DIAPHRAGM-TYPE, HROME PLATED. BEMIS 1955SSCT ASTIC SELF-SUSTAINING OPEN FRONT NGE AND BOLT CAPS. ESCUTCHEON I. POSED MANUAL FLUSH VALVE, 0.5 HRAGM VALVE. TOP SPUD. F SINGLE-HANDLED ADA LAVATORY NT. CHROME PLATED SOLID BRASS DAL RESISTANT LEVER HANDLE. P-UP ASSEMBLY. METAL GRID	BING FIXTURE SCHEDULE	PLUMB					
		RE					TRIM & ACCESSORIES	MODEL	DESCRIPTION	TYPE
nmenta		DATE SYMBOL	2"	4"		1"	SLOAN 111-1.6 EXPOSED FLUSH VALVE, DIAPHRAGM-TYPE, 1.6 GALLON FLUSH, CHROME PLATED. BEMIS 1955SSCT ELONGATED SOLID PLASTIC SELF-SUSTAINING OPEN FRONT SEAT WITH CHECK HINGE AND BOLT CAPS. ESCUTCHEON PLATE W/ SET SCREW.	KOHLER K-96058 (N.S.)	WATER CLOSET - FLOOR MOUNT, WHITE VITREOUS CHINA, ELONGATED BOWL, SIPHON JET FLUSH, 1½" TOP SPUD, 11" ROUGH-IN. 165%" RIM HEIGHT. 1.6 GALLON FLUSH. MOUNT PER ADA REQUIREMENTS.	WC-1
Enviro			2"	2"		3/4"	SLOAN REGAL 186 EXPOSED MANUAL FLUSH VALVE, 0.5 GALLON FLUSH. DIAPHRAGM VALVE. TOP SPUD.	KOHLER K-5016-ET (N.S.)	URINAL - WALL MOUNT, WHITE VITREOUS CHINA, ¾" TOP SPUD, 0.5 GALLON FLUSH, 14½" EXTENDED RIM. MOUNT PER ADA REQUIREMENTS.	U-1
at of		REVISION	1 1/2"	2"		1/2"	DELTA 501LF-HGMHDF SINGLE-HANDLED ADA LAVATORY FAUCET. 3-HOLE MOUNT. CHROME PLATED SOLID BRASS CONSTRUCTION, VANDAL RESISTANT LEVER HANDLE.	KOHLER K-2196-4 (N.S.)	20¼"x17½" DROP-IN VITREOUS CHINA LAVATORY. 3- HOLE INSTALLATION, ADA COMPLIANT.	L-1
artmer		NNS SYMBOL					0.5GPM. WITHOUT POP-UP ASSEMBLY. METAL GRID STRAINER. MCGUIRE 1-1/4" TRAP W/ PRODRAIN OFFSET ASSEMBLY, PRE-WRAPPED CHROME PLATED HEAVY CAST BRASS ADJUSTABLE P-TRAP W/ CLEANOUT, TAILPIECE, SLIP NUTS, 17A. SEAMLESS TUBULAR BRASS WALL BEND. MCGUIRE 167LK ANGLE SUPPLY STOPS, FLEXIBLE CHROME PLATED RISERS, CHROME ESCUTCHEON PLATES W/ SET			
STATE PROJECT No.: 61307C - N3803	FILE No.: 21-5436	ISSUE DATE: 02/24/2025 100% PLAN	1 1/2"	2"		1/2"	DELTA 501LF-HGMHDF SINGLE-HANDLED ADA LAVATORY FAUCET. 3-HOLE MOUNT. CHROME PLATED SOLID BRASS CONSTRUCTION, VANDAL RESISTANT LEVER HANDLE. 0.5GPM. WITHOUT POP-UP ASSEMBLY. METAL GRID STRAINER. MCGUIRE 1-1/4" TRAP W/ PRODRAIN OFFSET ASSEMBLY, PRE-WRAPPED CHROME PLATED HEAVY CAST BRASS ADJUSTABLE P-TRAP W/ CLEANOUT, TAILPIECE, SLIP NUTS, 17A. SEAMLESS TUBULAR BRASS WALL BEND. MCGUIRE 167LK ANGLE SUPPLY STOPS, FLEXIBLE CHROME PLATED RISERS, CHROME ESCUTCHEON PLATES W/ SET SCREWS.	KOHLER K-2005-0 (N.S.)	21½"x18½" WALL-HUNG VITREOUS CHINA LAVATORY. 3-HOLE INSTALLATION, ADA COMPLIANT.	L-2
156+			2"	3"	1/2"	1/2"	T&S BRASS B-0665-BSTR FAUCET W/ VACUUM BREAKER MUSTEE63.700 HOSE AND HOSE BRACKET MUSTEE 65.600 MOP HANGER MUSTEE 63.403 STAINLESS STEEL BUMPER GUARD MUSTEE 67.2424 STAINLESS STEEL WALL GUARD	MUSTEE 63M	24"x24"x10" HIGH IMPACT RESISTANT STRUCTURAL FIBERGLASS MOP SERVICE BASIN. COMPLETE WITH 3" PVC DRAIN.	MS-1
Consultant:		DESIGNER: TEP	0'-1 1/2"	0'-2"		0'-0 1/2"	McGUIRE 8872 1-1/4" HEAVY CAST BRASS POLISHED CHROME 17 GA. ADJUSTABLE P-TRAP WITH CLEANOUT, SLIP NUTS, AND SEAMLESS TUBULAR BRASS WALL BEND. McGUIRE 2165 1/2" IPS 3/8" O.D. ANGLE SUPPLIES AND STOPS, 12" FLEXIBLE CHROME PLATED COPPER RISERS. STEEL WALL MOUNT BRACKET. PROVIDE WITH CANE APRON - ELKAY 98324C.	ELKAY VRCTLFR8SC	WALL MOUNTED, VANDAL RESISTANT, BI-LEVEL ADA WATER COOLER. FROST RESISTANT, NON-FILTERED, REFRIGERATED. STAINLESS STEEL FINISH. DELIVERS 8 GPH OF 50 DEGREE DRINKING WATER. SEE ARCHITECTURAL PLANS FOR MOUNTING HEIGHT.	EWC-1
M. BAR	inning.	TRATION	This item has been			1/2"	1/2" IPS FEMALE INLET, TEE KEY HANDLE, ATMOSPHERIC VACUUM BREAKER, 3/4" GARDEN HOSE OUTLET.	T&S BRASS B-0720-POL	BRASS ANTI-SIPHON WALL FAUCET.	HB-1
No. 55427 ★ STATE OF	P	IAL REGIS	This item has been digitally signed and sea by Jon Barber , PE on 2/24/25 Printed copies of this document are not considered signed and sealed and the signature must be verified on any electronic copies			3/4"	3/4" NPT MALE INLET, LOOSE TEE KEY. ADJUSTABLE PACKING NUT WITH DEEP STEM GUARD.	WOODFORD MODEL 24	BRASS ANTI-SIPHON WALL FAUCET.	HB-2
SIONALE	OF ESTIVITION OF THE STREET	JFESSION.	sealed and the signature must be verified on any electronic copies.			1/2"	MIN. ACTIVATION FLOW RATE OF 0.25 GPM AT 20 PSIG	PPP PRO1-500	TRAP PRIMER VALVE, FLOW ACTIVATED	TP-1
		PRC		FOR SIZES	SEE PLANS		POLISHED BRONZE COVER. BRONZE PLUG.	ZURN Z1446	CLEANOUT TEE, DURA-COATED CAST IRON BODY, GAS AND WATERTIGHT ABS TAPERED THREAD PLUG, AND ROUND, SMOOTH STAINLESS STEEL WALL ACCESS COVER WITH SECURING SCREW.	wco
DULES	·	PARK		FOR SIZES	SEE PLANS		FLASHING CLAMP AND FLASHING FLANGE, BRONZE PLUG.	ZURN CO2452	ADJUSTABLE FLOOR CLEANOUT, PVC OR ABS BODY WITH ADJUSTABLE PVC HEAD ASSEMBLY, NICKEL BRONZE FRAME AND COVER, AND ABS TAPER THREAD PLUG	FCO
PLUMBING SCHEDI		CAMP HELEN STATE		FOR SIZES	SEE PLANS		FLASHING CLAMP AND FLASHING FLANGE, BRONZE PLUG.	ZURN CO2452	ADJUSTABLE FLOOR CLEANOUT, PVC OR ABS BODY WITH ADJUSTABLE PVC HEAD ASSEMBLY, NICKEL BRONZE FRAME AND COVER, AND ABS TAPER THREAD PLUG	ECO
I.	SHEET TITLE									
	T NO.	SHEE								

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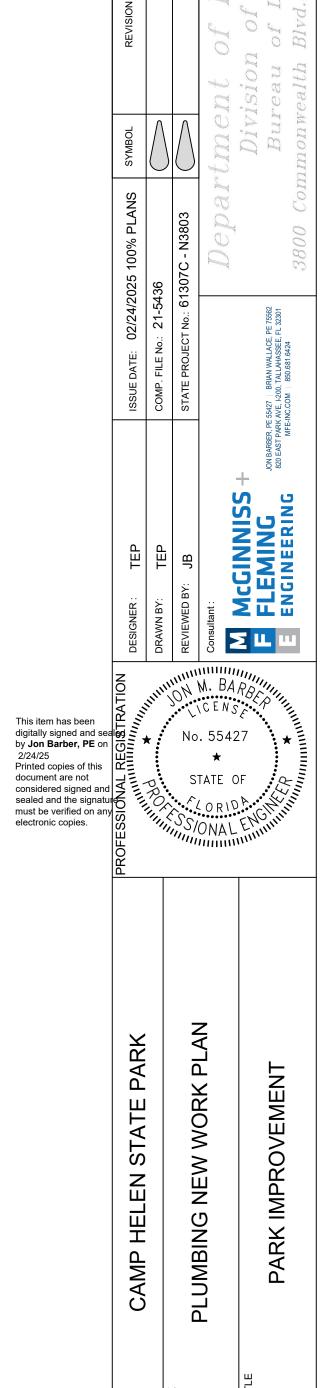




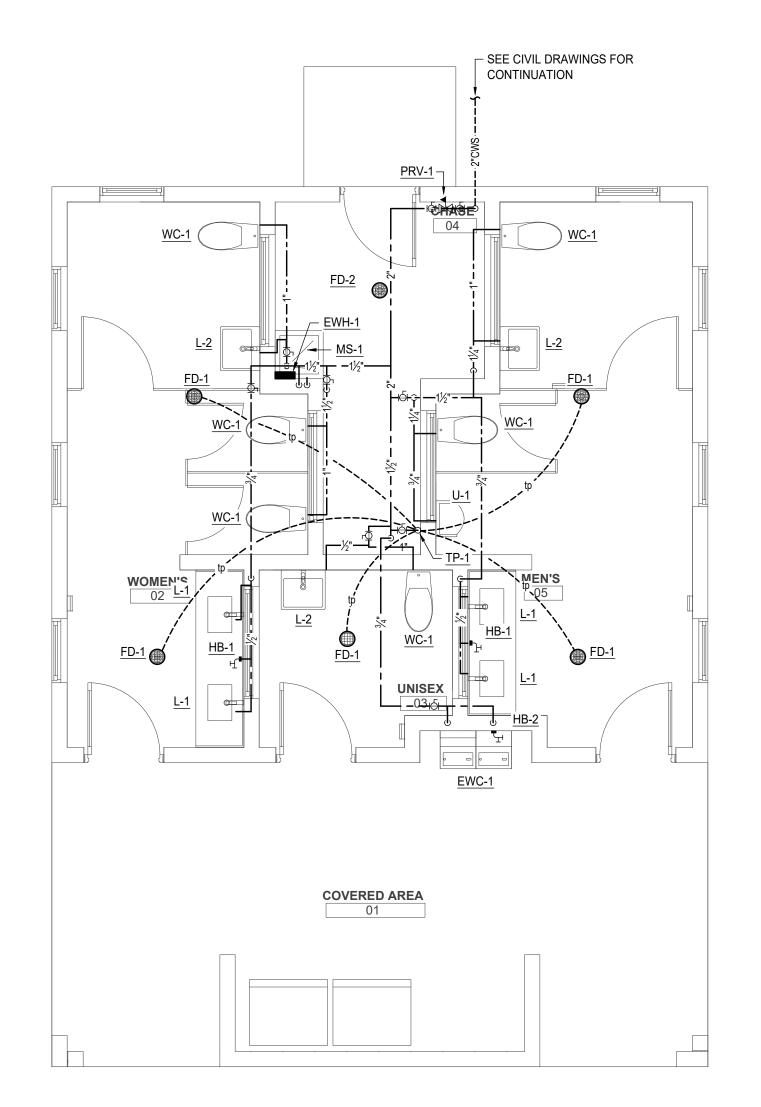


FLOOR PLAN - PLUMBING - DOMESTIC WATER

SCALE: 1/4" = 1'-0"



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P200

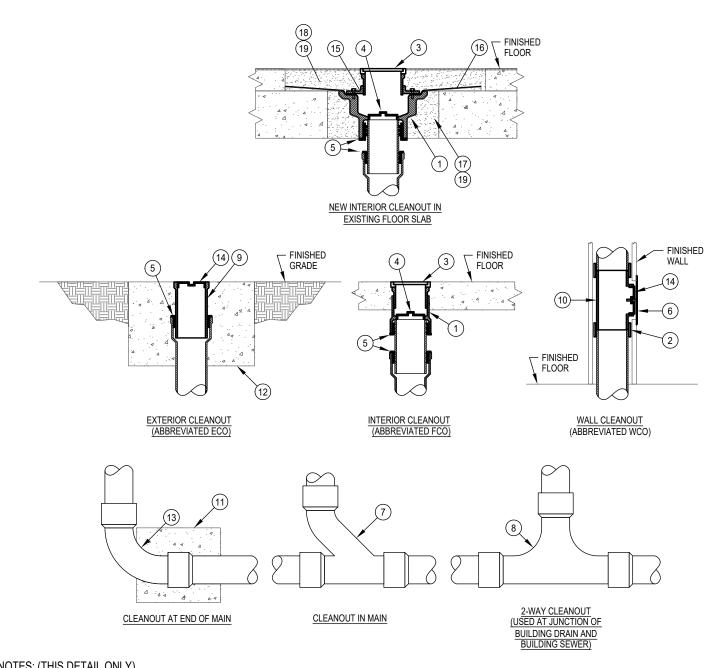


KEY NOTES: (THIS DETAIL ONLY)

- (1) SCHEDULE 40 PVC 2-PIECE CLEANOUT BODY WITH ADJUSTABLE HEAD.
- (2) NO-HUB COUPLING (FOR ABOVE GROUND APPLICATION ONLY).
- 3 SATIN STAINLESS STEEL TOP
- (4) BRONZE TAPERED THREAD, RAISED HEAD CLEANOUT PLUG.
- PUSH-ON NEOPRENE RUBBER COMPRESSION GASKET.
- (6) STAINLESS STEEL ROUND WALL ACCESS COVER.
- (7) COMBINATION WYE AND EIGHTH BEND FITTING.
- TWO-WAY CLEANOUT FITTING.
- (9) SCHEDULE 40 PVC CLEANOUT FERRULE.
- (10) DURA-COATED CAST IRON CLEANOUT TEE.
- (11) 12" x 12" x 12" CONCRETE THRUST BLOCK.
- CLEAN OUT DETAIL

 NTS
- (12) 24" x 24" x 12" CONCRETE PAD FLUSH WITH GRADE. (13) LONG SWEEP ELBOW. (14) BRONZE TAPERED THREAD, RECESSED HEAD CLEANOUT PLUG. (15) INVERTIBLE CLAMPING COLLAR. (16) NON-FERROUS WATERPROOFING MEMBRANE CLAMPED TIGHTLY TO DRAIN BODY. (17) BREAK OUT EXISTING STRUCTURAL CONCRETE FLOOR SLAB. (18) CUT TOPPING MINIMUM 12" BEYOND BROKEN-OUT STRUC-TURAL FLOOR SLAB TO NEAREST FLOOR TILE JOINT TO


ALLOW FOR INSTALLATION OF NEW LEAD PAN FLASHING.

(19) GROUT SOLID AROUND NEW FLOOR DRAIN.

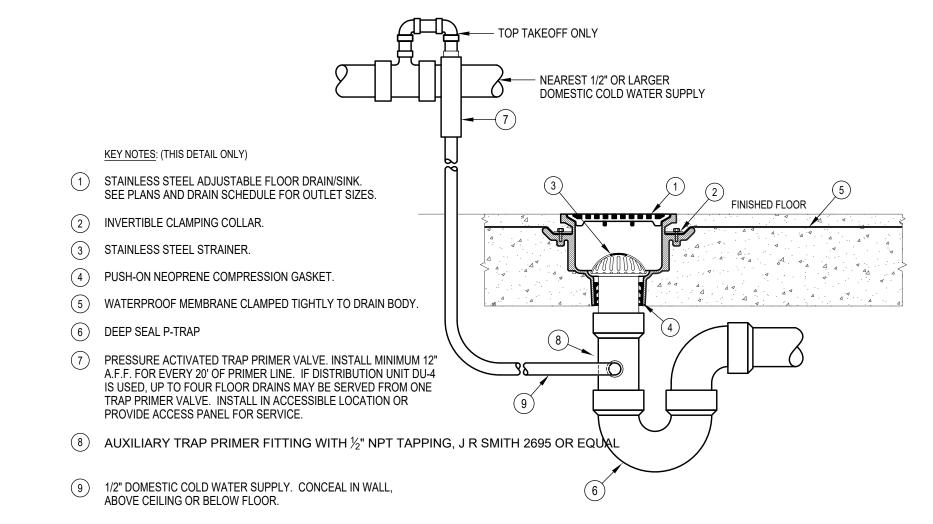

TYPICAL FLOOR DRAIN/SINK INSTALLATION DETAIL


NTS

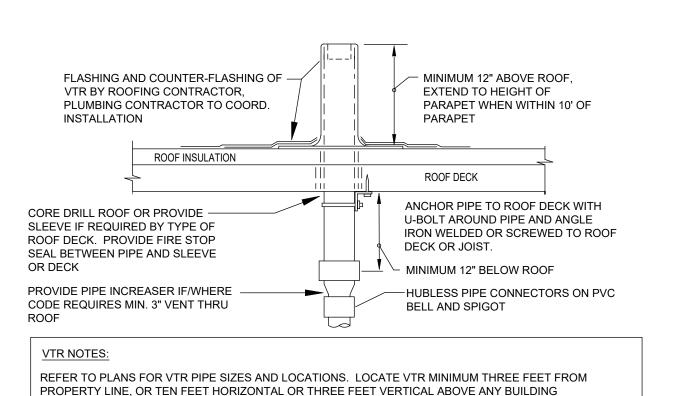





OPENING OR FRESH AIR INTAKE, OR ONE FOOT FROM ANY VERTICAL SURFACE. LOCATE VTR MINIMUM 18" FROM PARAPET, EXPANSION JOINT, EQUIPMENT CURB, ETC. OFFSET IN CEILING SPACE

WHERE REQUIRED TO MEET THESE CONDITIONS.

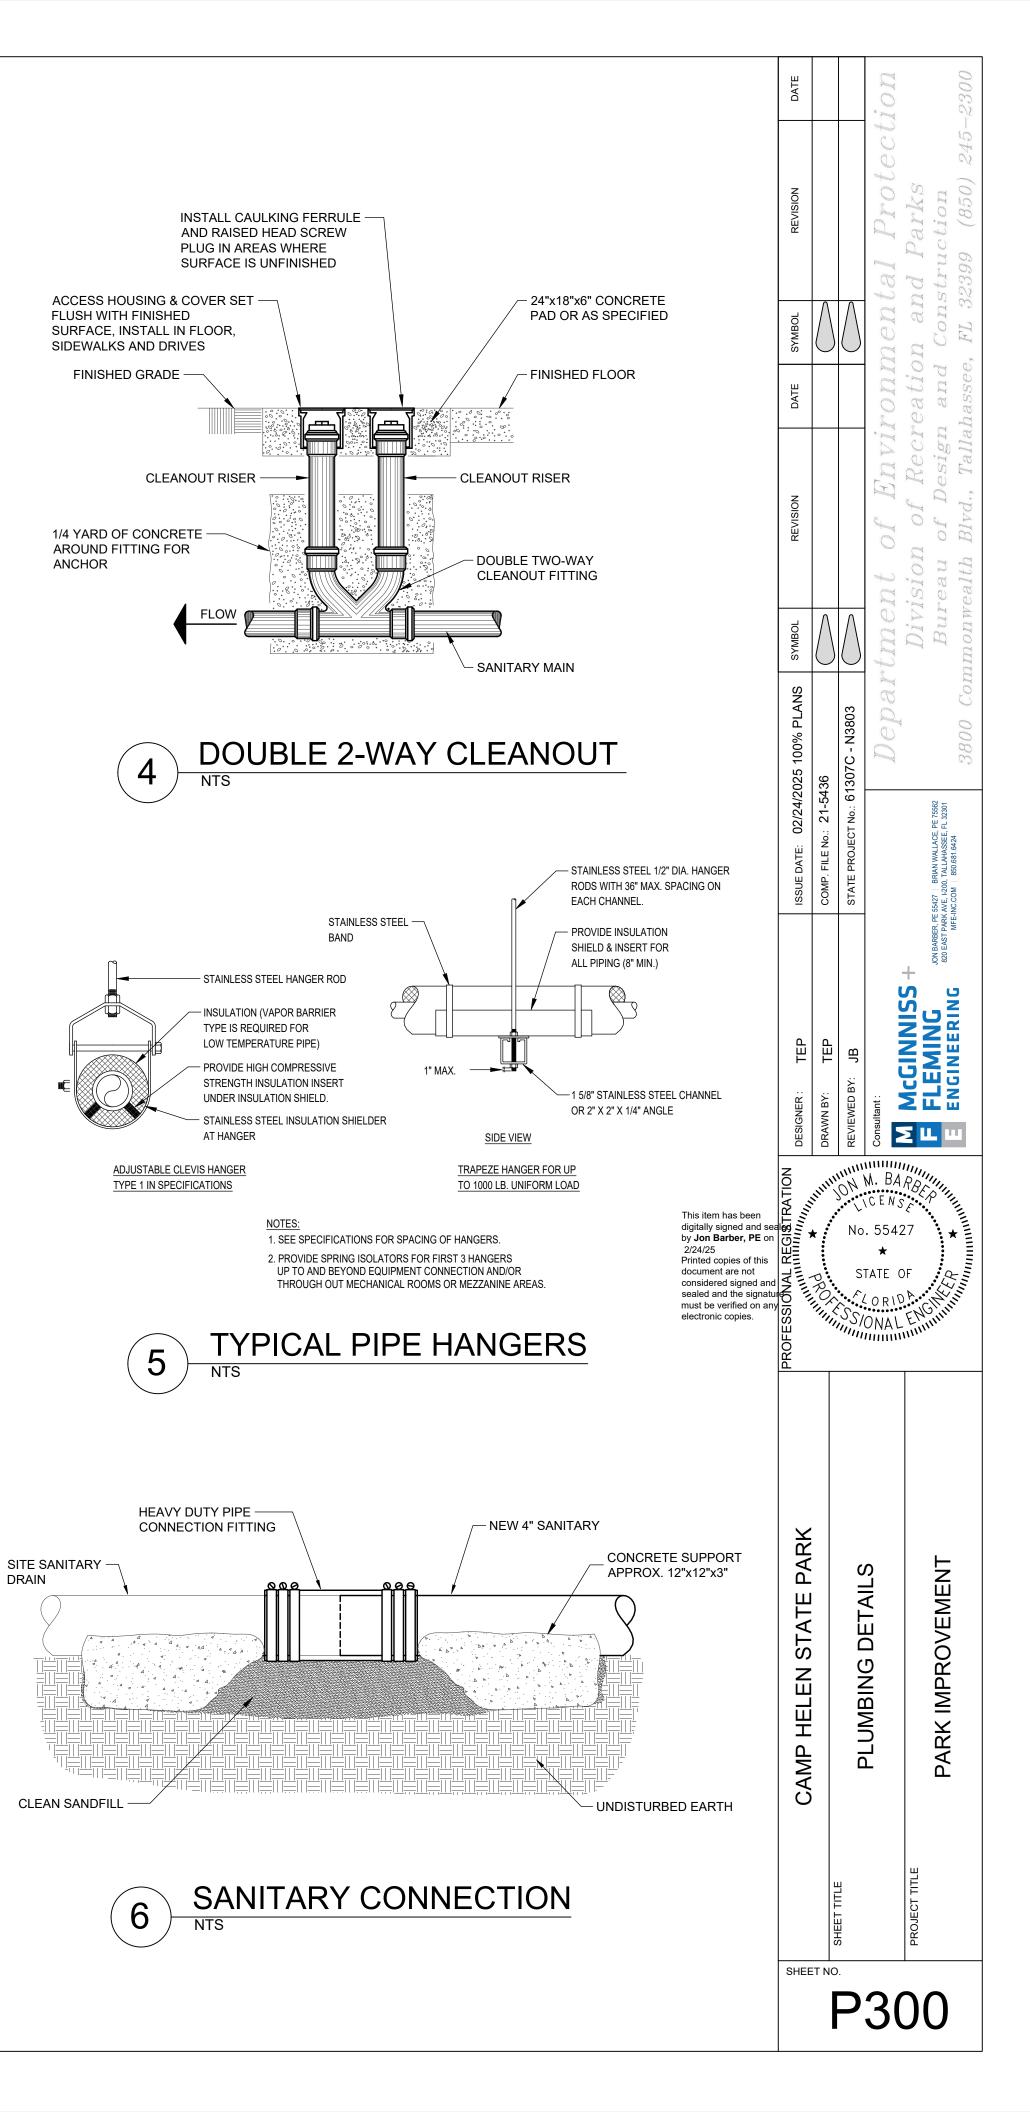

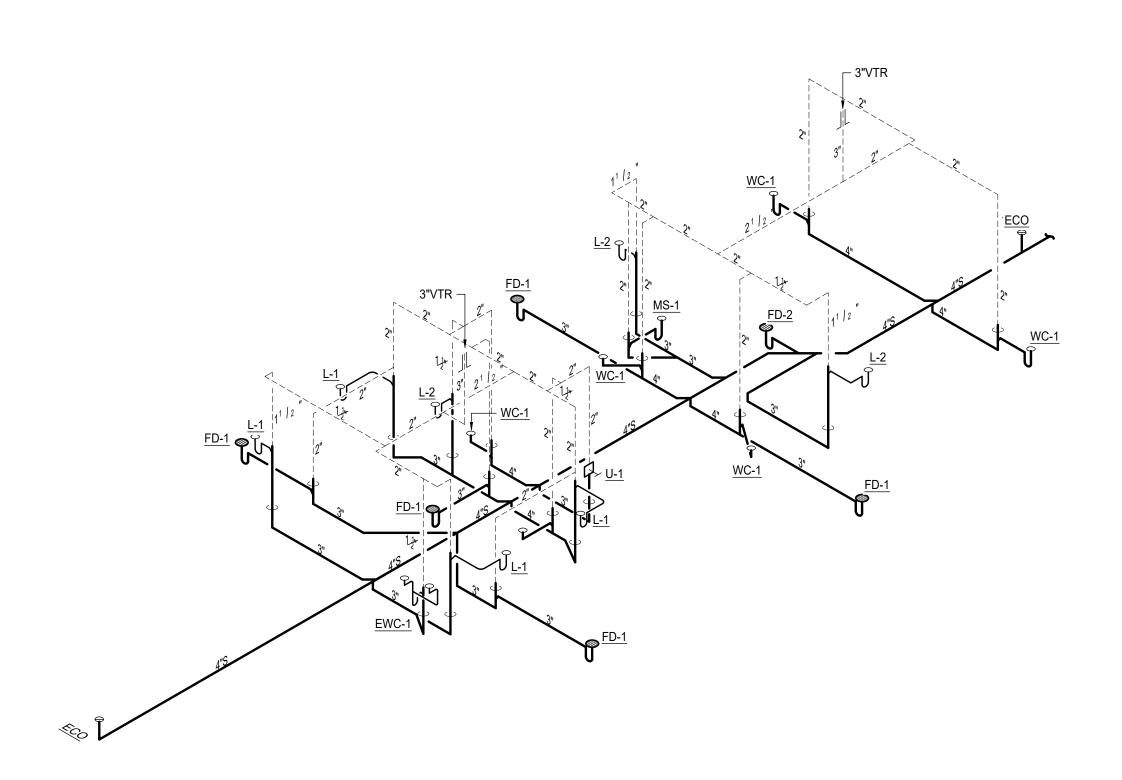

PLUMBING RISER - SANITARY

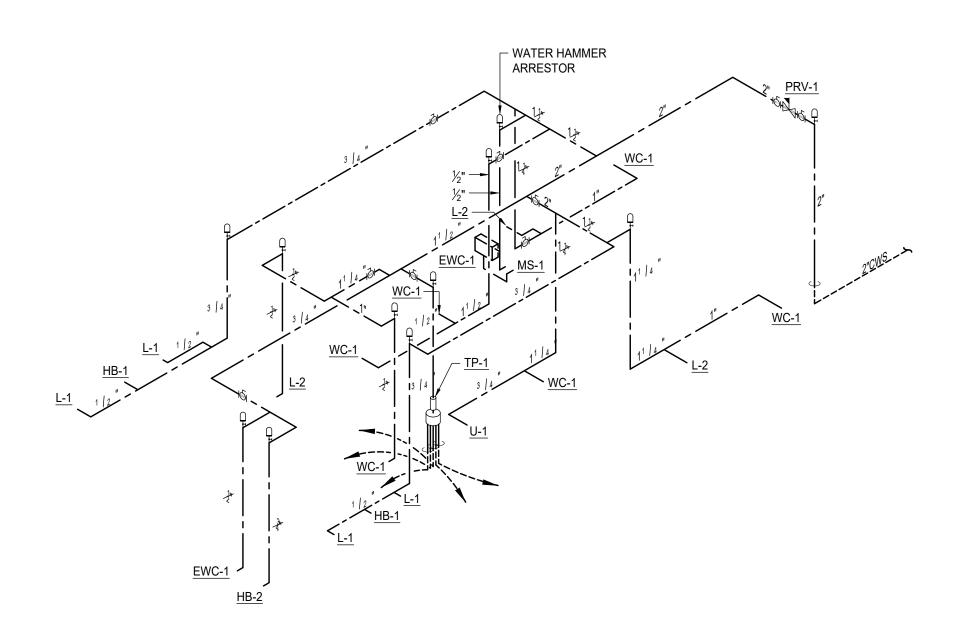

PLUMBING RISER - DOMESTIC WATER