

Abbreviations: NUMBER EACH STEEL ANGLE, LENGTH **RETURN AIR EXHAUST FAN** LAMINATED RAD RADIUS AND **EXPANSION JOINT** LAV LAVATORY RUBBER RCP AND ELECTRIC / ELECTRICAL POUNDS REFLECTED CEILING PLAN **ELEVATOR / ELEVATION** RD **ELEV** LINEAR FEET **ROOF DRAIN ANCHOR BOLT ENCL ENCLOSURE** REF REFERENCE LEFT HAND ETHYLENE PROPYLENE DIENE M-A/C AIR CONDITIONING / AIR **EPDM** LINO LINOLEUM REINF REINFORCED / REINFORCEMENT CONDITIONER CLASS LIVE LOAD RET RETURN ABOVE LONG LEG HORIZONTAL REQD REQUIRED AMERICAN CONCRETE INSTITUTE EQUIP **EQUIPMENT** LONG LEG VERTICAL REV REVISION EW RIGHT HAND ACOUSTICAL CEILING TILE **EACH WAY** LIGHT AMERICANS WITH DISABILITIES ACT ELECTRICAL WATER COOLER RMADA LIGHTING ROOM ADDL ADDITIONAL EX EXISTING / EXHAUST LTL RMV **REMOVE** ADJACENT / ADJUST EXH EXHAUST LIGHTWEIGHT **ROUGH OPENING EXIST** AFF ABOVE FINISH FLOOR EXISTING LVR LOUVER RIGHT OF WAY ABOVE FINISH GRADE EXT EXTERIOR AG **ABOVE GRADE** FIRE ALARM MARBLE SANITARY ALTERNATE FIRE ALARM PANEL **MASONRY** SOLID CORE ALUMINUM FIRE ALARM STROBE / HORN ANOD ANODIZED MATERIAL SCHEDULE / SCHEDULED FLOOR DRAIN / FIRE DEPARTMENT FD ARCHITECT OF RECORD MAXIMUM SMOKE DETECTOR ARCH ARCHITECT / ARCHITECTURAL FE FIRE EXTINGUISHER MEDICINE CABINET SECT SECTION FEB FIRE EXTINGUISHER WITH BRACKET MECH SEW SEWER ASPH ASPHALT MECHANICAL AMERICAN SOCIETY OF TESTING AND SQUARE FEET FIRE EXTINGUISHER IN CABINET MED MEDIUM **MATERIALS** FINISH FLOOR MEMBR MEMBRANE SGL SIGNAL / SINGLE FHC FIRE HOSE CABINET SHT MEZZ MEZZANINE SHEET FIN FIXT BD MFR SIM SIMILAR BOARD FINISH **MANUFACTURER** FIXTURE SJ BUILDING LINE MINIMUM SAWED JOINT FLG MISC MISCELLANEOUS SPECS SPECIFICATIONS BUILDING FLASHING BLDG FLOOR SPKLR SPRINKLER **BOTTOM OF** FLR FLOOR MASONRY OPENING **SQUARE** BOF **BOTTOM OF FOOTING FLUOR** FLUORESCENT MOD MODULAR SS SANITARY SEWER BOW **BOTTOM OF WALL** FND FOUNDATION MRGWB MOISTURE RESISTANT GYPSUM SST STAINLESS STEEL FO STC SOUND TRANSMISSION COEFFICIENT **BSMT** BASEMENT FACE OF WALLBOARD BTM FOS FACE OF STUD MOUNTED STD BOTTOM STANDARD FRP FIBERGLASS REINFORCED PANEL STL **BEARING** STEEL FT MULL BYND FOOT / FEET STOR STORAGE BEYOND MULLION STRUCT STRUCTURE / STRUCTURAL FTG FOOTING FIELD VERIFY SUSP SUSPENDED SW NOT APPLICABLE STORMWATER **CENTERLINE** GAUGE NOT IN CONTRACT SQUARE YARD CENTERLINE SYS SYSTEM GALVANIZED NUMBER CABINET / CABINETRY GC GENERAL CONTRACTOR NOMINAL **CATCH BASIN** GEN GENERAL NON SHRINK **TONGUE AND GROOVE** CEMENT GROUND FAULT CIRCUIT INTERRUPT **GFCI** NOT TO SCALE TELEPHONE / DATA CF **CUBIC FEET** GFI GND GROUND FAULT INTERRUPT TBD TO BE DETERMINED CUBIC FEET PER MINUTE GROUND **TELEPHONE** CH CHANNEL GWB GYPSUM WALLBOARD OVERALL TEMPORARY / TEMPERATURE **CAST-IN-PLACE** GYP GYPSUM ON CENTER THICK CIR CIRCLE, CIRCULAR occs OCCUPANTS THRESHOLD / THREADED CJ CONTROL JOINT OUTSIDE DIAMETER / OVERFLOW DRAIN H/C HANDICAPPED ACCESSIBLE **TOOLED JOINT** OD CLG CEILING HOSE BIBB OVERHEAD / OPPOSITE HAND TO MATCH EXISTING CL CLOSET TOP OF HOLLOW CORE OVERHEAD DOOR CLEARANCE / CLEAR HDR HEADER OPP OPPOSITE TOP OF BEAM CONCRETE MASONRY UNIT HDRL HANDRAIL OPPH OPPOSITE HAND TOP OF CONCRETE CNTR COUNTER HM OPNG TOF TOP OF FOOTING **HOLLOW METAL** OPENING CO CLEAN OUT / CASED OPENING HORZ OUNCE TOP OF STEEL HORIZONTAL COL COLUMN HR TOW COMP COMPRESSOR / COMPOSITE HOUR TOP OF WALL TS HGT HEIGHT PART STRUCTURAL TUBE STEEL PARTITION COMPR COMPRESSIBLE HT HEIGHT PCC PRE-CAST CONCRETE TV **TELEVISION** CONC CONCRETE HTR HEATER PCF POUNDS PER CUBIC FOOT TYP TYPICAL CONSTR CONSTRUCTION HEATING, VENTILATION, AND AIR PERF PERFORATED CONT CONTINUOUS CONDITIONING PARKING UNDERSIDE CONTR CONTRACTOR HOT WATER / HARDWARE PLATE / PLASTER / PROPERTY LINE UNFINISHED CORR CORRUGATED PLASTIC LAMINATE **UNLESS NOTED OTHERWISE** CPT CARPET INSULATED CONCRETE FORM PLUMB PLUMBING UON UNLESS OTHERWISE NOTED CS COUNTERSINK / COUNTERSUNK INSIDE DIAMETER PLYWD PLYWOOD UR URINAL CT CERAMIC TILE **INCHES** CTR CENTER INCL VAPOR BARRIER INCLUDES / INCLUDING COURTYARD INSUL PREFAB PREFABRICATED VCT VINYL COMPOSITE TILE INSULATION CUBIC YARDS INT PREPARE / PREPARATION INTERIOR VERTICAL COLD WATER POUNDS PER SQUARE FOOT VESTIBULE INV INVERT VEST IMPACT RESISTANT POUNDS PER SQUARE INCH VERIFY IN FIELD VIF IRGWB IMPACT RESISTANT GYPSUM PRESSURED TREATED / PAINT / POINT VERIFY DECIBEL WALLBOARD POLYVINYL CHLORIDE VOLUME DBL DOUBLE DEG PAVEMENT **VISION PANEL** DEGREES VT **JANITOR** JAN PWR POWER VINYL TILE DEMO DEMOLISH / DEMOLITION VENT THROUGH ROOF JAMB VTR DF DRINKING FOUNTAIN JUNCTION BOX QUALITY CONTROL DIA DIAMETER QUARRY TILE JCT JUNCTION WITH DIMENSION JST JOIST QUANTITY W/O WITHOUT QTY DEAD LOAD WATER CLOSET JOINT WC DN DOWN WCT WAINSCOT DS DOWNSPOUT WD WOOD DTL DETAIL KILN DRIED WATERPROOF, WATERPROOFING DRAWING DWG KDAT KILN DRIED AFTER TREATMENT WT WATER TABLE DWGS DRAWINGS WELDED WIRE FABRIC


DETAIL REFERENCE

Legend of Architectural Symbols:

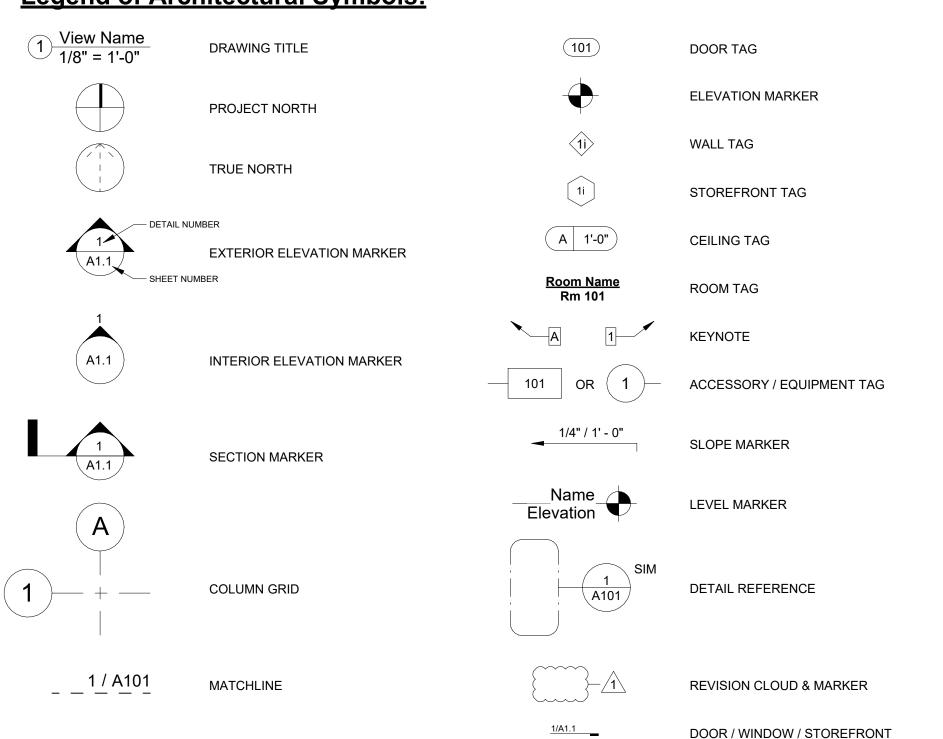

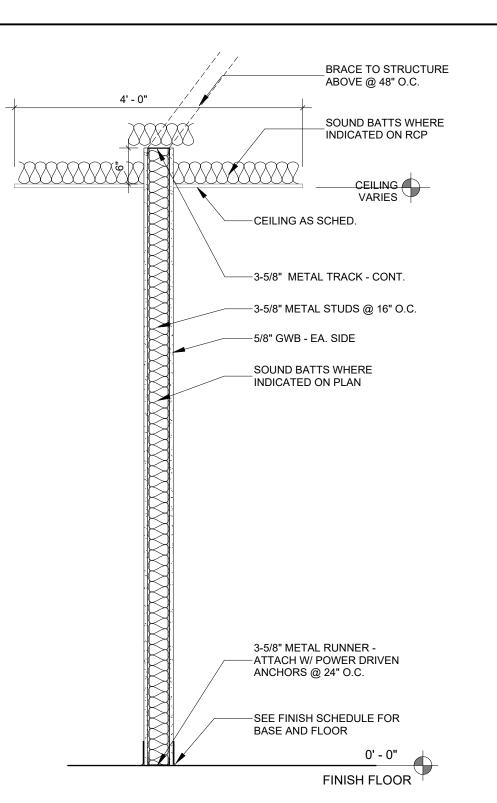


Typical Wall Section 6" Above Ceiling

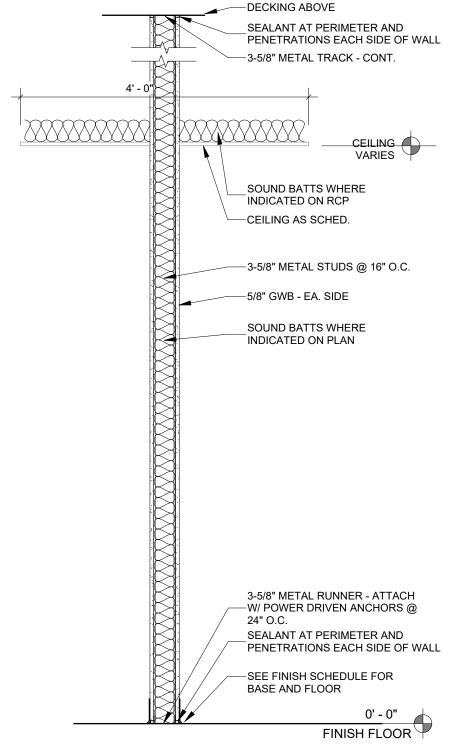


Typical Wall Section to Structure Above

Partition Types:

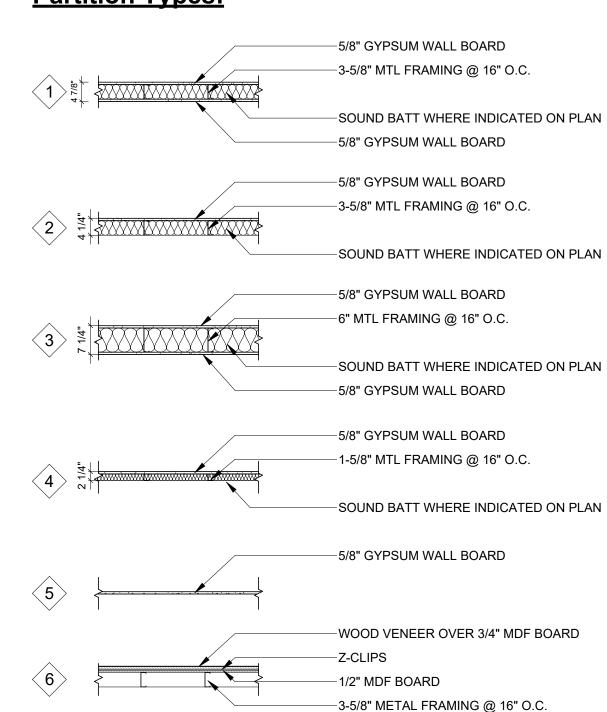

Partition Notes:

1. DEFAULT INTERIOR PARTITION HEIGHT: EXTEND 6" ABOVE CEILING GRID/STRUCTURE. 2. PROVIDE METAL BRACING @ 4'-0" O.C. MAX ATTACHED TO STRUCTURE ABOVE. —ADDITIONAL WALL REQUIREMENTS

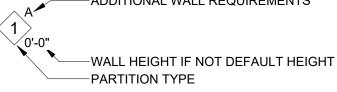

Additional Requirements:

MOISTURE RESISTANT GYPSUM BOARD ON ONE SIDE MOISTURE RESISTANT GYPSUM BOARD ON TWO SIDES INFILL DEMOLISHED DOOR OR WALL OPENING EXTEND TO BOTTOM OF ROOF DECK

Partition Types General Notes:

1. INTERIOR METAL FRAMED PARTITIONS SHALL HAVE 2 CONTINUOUS BEADS OF ACOUSTIC SOUND SEALANT PLACED BELOW THE BASE PLATE - TYPICAL AT ALL LOCATIONS UNLESS OTHERWISE NOTED.

2. TILE BACKER BOARD SHALL BE USED AT WALL LOCATIONS TO RECEIVE TILE FINISH. 3. WALLS WITH TILE FINISH TRANSITION TO PAINTED GWB – SEE INTERIOR ELEVATIONS FOR TRANSITION HEIGHT.



1621 Physicians Dr Tallahassee, Florida 32308 (P) 850.778.8007 | (F) 850.546.6150 www.bkjarchitecture.com
FL Architecture Corporation AA26002280

SEAL:

PROJECT TITLE:

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Abbreviations, Symbols, & Partition Types


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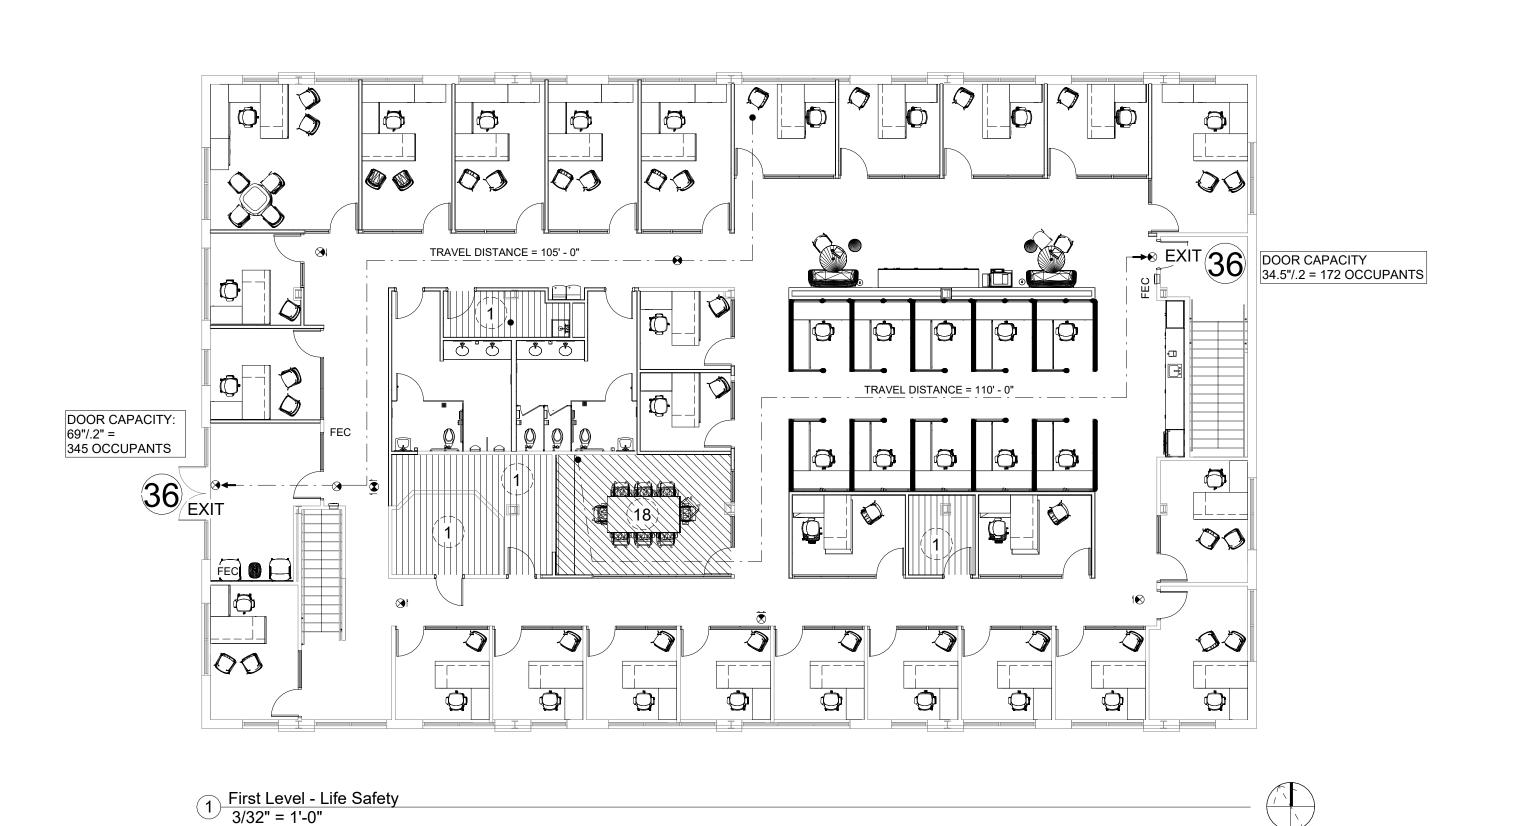
DATE:

Code Summary

		Allowed/ Required	Provided	Comments
eneral Project Information Project Name:	Office Renovation for FAIA	4		
Project Location: City:	1117 Thomasville Road Tallahassee			
County: State:	Leon Florida			
Iteration Level				Work area exceeds 50% of the building area
Level 3 Alteration (FBC-E 604.1) se and Occupancy Classification				work area exceeds 50% of the building area
Mixed (Non-Separated) Per FBC-B 508.3 and Mixed (Non-Separated) Per FFPC 6.1.14.3				
Occupancy Group Classification				
Business Group B FBC-B (304.1)	Business Group B			
FFPC (6.1.11) Hazard Classification (FFPC: 38.1.5 & 6.2.2.3)	Business Ordinary Hazard			
Assembly Group A-3 FBC-B (303.4)	Assembly Group A-3			
FFPC (6.1.2.1) Hazard Classification (FFPC: 12.1.5 & 6.2.2.3)	Assembly Ordinary Hazard			
uilding Area				No change to building square footage.
1st Level Basement	8,121 7,359			
Total Project Work Area	15,480 8,258			Reconfigured work area
Project Area	15,612			Renovated area including finish replacements
1st Level Business Areas	7,493/150 gsf = 50			
Assembly Area Conference (131)	257/15 nsf = 18			
Storage and Equipment Areas Mechanical (124)	101/300 gsf = 1			
Electrical (125) Janitor (128)	126/300 gsf = 1 66/300 gsf = 1			
Storage (133) Total 1st Level	64/300 gsf = 1 72			
Basement Level Business Areas	4,899/150 gsf = 33			
Assembly Area Multi-Purpose (004)	1,499/15 nsf = 100			
Storage and Equipment Areas Furniture Storage (003)	170/300 gsf = 1			
Riser Room (004A) Storage (005) Storage (017)	20/300 gsf = 1 76/300 gsf = 1 36/300 gsf = 1			
Storage (017) Storage (018) Janitor (019)	48/300 gsf = 1 48/300 gsf = 1 52/300 gsf = 1			
Mech (113) Exercise	171/300 gsf = 1			
Gym (011) Total Basement Level	371/50 gsf = 8 148			
Building Total	220			
uilding will be provided with a Fire Alarm System		no	yes	FFPC: 12.3.4.1, 38.3.4.1
onstruction Type (FBC-B 601) Type V B, Sprinklered				
llowable Building Heights and Area				
Business (B) (Type V B, Sprinklered) Allowable Building Height (Table 504.3) Allowable Number of Stories (Table 504.4)		60'	<60'	
Allowable Area Factor (Table 506.2)		36,000 sf	_	1st level area
Assembly (A-3) (Type V B, Sprinklered) Allowable Building Height (Table 504.3)		60'	<60'	
Allowable Number of Stories (Table 504.4) Allowable Area Factor (Table 506.2)		2 24,000 sf	2 8,178	1st level area
ire Resistance Rating for Building Elements (Type II B, ur	protected)			
Table 601 (FBC-B) Structural Frame		Ohr		
Bearing Walls Exterior Nonbearing Walls Exterior (see table 705.5) ("x" dista		0hr	0hr	
	nce >= 10')	0hr 0hr	Ohr Ohr	
Nonbearing Interior Walls and Partitions Floor Construction	nce >= 10')	Ohr Ohr Ohr Ohr	Ohr Ohr Ohr	
Nonbearing Interior Walls and Partitions Floor Construction Roof Construction	nce >= 10')	Ohr Ohr Ohr	Ohr Ohr Ohr	
Nonbearing Interior Walls and Partitions Floor Construction	nce >= 10') FBC-B: 7012.1.9	Ohr Ohr Ohr Ohr	Ohr Ohr Ohr	
Nonbearing Interior Walls and Partitions Floor Construction Roof Construction linimum Fire Resistance Stair		Ohr Ohr Ohr Ohr Ohr	Ohr Ohr Ohr Ohr Ohr	
Nonbearing Interior Walls and Partitions Floor Construction Roof Construction finimum Fire Resistance Stair Shaft Fire Walls Tenant Separations Occupancy Separations Horizontal Exit		Ohr Ohr Ohr N/A N/A N/A N/A N/A	Ohr Ohr Ohr Ohr A N/A N/A N/A N/A N/A N/A	
Nonbearing Interior Walls and Partitions Floor Construction Roof Construction finimum Fire Resistance Stair Shaft Fire Walls Tenant Separations Occupancy Separations Horizontal Exit Corridors	FBC-B: 708.1 & 1020.2	Ohr Ohr Ohr N/A N/A N/A N/A	Ohr Ohr Ohr Ohr A N/A N/A N/A N/A N/A N/A	Building is sprinklered
Nonbearing Interior Walls and Partitions Floor Construction Roof Construction Ininimum Fire Resistance Stair Shaft Fire Walls Tenant Separations Occupancy Separations Horizontal Exit Corridors Bassification of Finishes (FBC-B: Table 803.11, FFPC: 38.3 Business Areas:	FBC-B: 7012.1.9 FBC-B: 708.1 & 1020.2 3, FFPC: 12.3.3)	Ohr Ohr Ohr Ohr N/A N/A N/A N/A N/A Ohr	Ohr Ohr Ohr Ohr Ohr Ohr Ohr N/A N/A N/A N/A N/A Ohr	Building is sprinklered
Nonbearing Interior Walls and Partitions Floor Construction Roof Construction Ninimum Fire Resistance Stair Shaft Fire Walls Tenant Separations Occupancy Separations Horizontal Exit Corridors lassification of Finishes (FBC-B: Table 803.11, FFPC: 38.3 Business Areas: Interior exit stairways, int. exit ramps and exit passag Corridors and enclosure for exit access stairways and	FBC-B: 7012.1.9 FBC-B: 708.1 & 1020.2 3, FFPC: 12.3.3) eways	Ohr Ohr Ohr Ohr Ohr N/A N/A N/A N/A N/A N/A B N/A	Ohr Ohr Ohr Ohr A, B A, B A, B	Building is sprinklered
Nonbearing Interior Walls and Partitions Floor Construction Roof Construction Ninimum Fire Resistance Stair Shaft Fire Walls Tenant Separations Occupancy Separations Horizontal Exit Corridors lassification of Finishes (FBC-B: Table 803.11, FFPC: 38.3 Business Areas: Interior exit stairways, int. exit ramps and exit passage	FBC-B: 7012.1.9 FBC-B: 708.1 & 1020.2 3, FFPC: 12.3.3) eways exit access ramps	Ohr Ohr Ohr Ohr N/A	Ohr Ohr Ohr Ohr A N/A N/A N/A N/A N/A N/A A N/A A N/A A N/A A A A	Building is sprinklered
Nonbearing Interior Walls and Partitions Floor Construction Roof Construction Inimum Fire Resistance Stair Shaft Fire Walls Tenant Separations Occupancy Separations Horizontal Exit Corridors Bassification of Finishes (FBC-B: Table 803.11, FFPC: 38.3 Business Areas: Interior exit stairways, int. exit ramps and exit passag. Corridors and enclosure for exit access stairways and Rooms and enclosed spaces	FBC-B: 7012.1.9 FBC-B: 708.1 & 1020.2 3, FFPC: 12.3.3) eways exit access ramps	Ohr Ohr Ohr Ohr Ohr N/A N/A N/A N/A Ohr B B C	Ohr Ohr Ohr Ohr Ohr A, B A, B A, B, C	Building is sprinklered
Nonbearing Interior Walls and Partitions Floor Construction Roof Construction finimum Fire Resistance Stair Shaft Fire Walls Tenant Separations Occupancy Separations Horizontal Exit Corridors lassification of Finishes (FBC-B: Table 803.11, FFPC: 38.3 Business Areas: Interior exit stairways, int. exit ramps and exit passag Corridors and enclosure for exit access stairways and Rooms and enclosed spaces Exit enclosure and exit access corridors - floor finish (in the content of the c	FBC-B: 7012.1.9 FBC-B: 708.1 & 1020.2 3, FFPC: 12.3.3) eways exit access ramps	Ohr Ohr Ohr Ohr Ohr AN/A N/A N/A N/A N/A SOH Ohr B B C C Class I or II	Ohr Ohr Ohr Ohr Ohr Ohr N/A N/A N/A N/A N/A N/A A N/A A A, B A	Building is sprinklered
Nonbearing Interior Walls and Partitions Floor Construction Roof Construction Inimum Fire Resistance Stair Shaft Fire Walls Tenant Separations Occupancy Separations Horizontal Exit Corridors Iassification of Finishes (FBC-B: Table 803.11, FFPC: 38.3 Business Areas: Interior exit stairways, int. exit ramps and exit passage Corridors and enclosure for exit access stairways and Rooms and enclosed spaces Exit enclosure and exit access corridors - floor finish (in the content of the c	FBC-B: 7012.1.9 FBC-B: 708.1 & 1020.2 .3, FFPC: 12.3.3) eways exit access ramps FBC-B: 804)	Ohr Ohr Ohr Ohr Ohr AN/A N/A N/A N/A N/A SOH Ohr B B C C Class I or II	Ohr Ohr Ohr Ohr Ohr Ohr A, B A, B A, B, C Class I or II	Building is sprinklered
Nonbearing Interior Walls and Partitions Floor Construction Roof Construction Rinimum Fire Resistance Stair Shaft Fire Walls Tenant Separations Occupancy Separations Horizontal Exit Corridors Ilassification of Finishes (FBC-B: Table 803.11, FFPC: 38.3 Business Areas: Interior exit stairways, int. exit ramps and exit passage Corridors and enclosure for exit access stairways and Rooms and enclosed spaces Exit enclosure and exit access corridors - floor finish (in the company of th	FBC-B: 7012.1.9 FBC-B: 708.1 & 1020.2 .3, FFPC: 12.3.3) eways exit access ramps FBC-B: 804)	Ohr Ohr Ohr Ohr Ohr Ohr N/A N/A N/A N/A N/A Ohr B B C Class I or II A B B C Class II	Ohr Ohr Ohr Ohr Ohr Ohr N/A N/A N/A N/A N/A N/A A N/A A N/A A N/A A A B A B A B A B A B A B A B A B A B	Building is sprinklered
Nonbearing Interior Walls and Partitions Floor Construction Roof Construction Rinimum Fire Resistance Stair Shaft Fire Walls Tenant Separations Occupancy Separations Horizontal Exit Corridors Iassification of Finishes (FBC-B: Table 803.11, FFPC: 38.3 Business Areas: Interior exit stairways, int. exit ramps and exit passage Corridors and enclosure for exit access stairways and Rooms and enclosed spaces Exit enclosure and exit access corridors - floor finish (in the control of the	FBC-B: 7012.1.9 FBC-B: 708.1 & 1020.2 .3, FFPC: 12.3.3) eways exit access ramps FBC-B: 804)	Ohr Ohr Ohr Ohr Ohr Ohr N/A N/A N/A N/A N/A Ohr B B C Class I or II	Ohr Ohr Ohr Ohr Ohr Ohr N/A N/A N/A N/A N/A N/A A N/A A A, B A	Building is sprinklered
Nonbearing Interior Walls and Partitions Floor Construction Roof Construction Rinimum Fire Resistance Stair Shaft Fire Walls Tenant Separations Occupancy Separations Horizontal Exit Corridors Jassification of Finishes (FBC-B: Table 803.11, FFPC: 38.3 Business Areas: Interior exit stairways, int. exit ramps and exit passage Corridors and enclosure for exit access stairways and Rooms and enclosed spaces Exit enclosure and exit access corridors - floor finish (in the company of the	FBC-B: 7012.1.9 FBC-B: 708.1 & 1020.2 .3, FFPC: 12.3.3) eways exit access ramps FBC-B: 804) FBC-B: 804)	Ohr Ohr Ohr Ohr Ohr Ohr Ohr N/A N/A N/A N/A N/A Ohr B B C Class I or II A B B C Class II	Ohr Ohr Ohr Ohr Ohr Ohr Ohr N/A N/A N/A N/A N/A N/A N/A A N/A A N/A Ohr A, B A, B A, B A, B A, B C Class I or II A A, B A	Building is sprinklered
Nonbearing Interior Walls and Partitions Floor Construction Roof Construction Rinimum Fire Resistance Stair Shaft Fire Walls Tenant Separations Occupancy Separations Horizontal Exit Corridors Iassification of Finishes (FBC-B: Table 803.11, FFPC: 38.3 Business Areas: Interior exit stairways, int. exit ramps and exit passage Corridors and enclosure for exit access stairways and Rooms and enclosed spaces Exit enclosure and exit access corridors - floor finish (in the company of the	FBC-B: 7012.1.9 FBC-B: 708.1 & 1020.2 .3, FFPC: 12.3.3) eways exit access ramps FBC-B: 804) FBC-B: 804)	Ohr Ohr Ohr Ohr Ohr Ohr Ohr N/A N/A N/A N/A N/A Ohr B B C Class I or II A B B C Class II	Ohr Ohr Ohr Ohr Ohr Ohr Ohr N/A N/A N/A N/A N/A N/A A N/A A N/A A N/A Ohr A, B A, B A, B, C Class I or II A A, B A, B A, B A, B A, C Class II	Building is sprinklered
Nonbearing Interior Walls and Partitions Floor Construction Roof Construction Rinimum Fire Resistance Stair Shaft Fire Walls Tenant Separations Occupancy Separations Horizontal Exit Corridors Rassification of Finishes (FBC-B: Table 803.11, FFPC: 38.3 Business Areas: Interior exit stairways, int. exit ramps and exit passag Corridors and enclosure for exit access stairways and Rooms and enclosed spaces Exit enclosure and exit access corridors - floor finish (in Assempbly Areas: Enclosed stairways Lobbies Corridors General Assembly Areas less than 300 occupants Exit enclosure and exit access corridors - floor finish (in Assemption of the Exit enclosure and exit access corridors - floor finish (in Assembly Areas) Exit enclosure and exit access corridors - floor finish (in Assembly Areas) Exit enclosure and exit access corridors - floor finish (in Assembly Areas) Exit enclosure and exit access corridors - floor finish (in Assembly Areas) Exit enclosure and exit access corridors - floor finish (in Assembly Areas) Exit Travel Distance (FBC-B: Table 1017.2, FFBP: 12.2.6.2, Business Maximum Travel Distance Assembly Maximum Travel Distance	FBC-B: 7012.1.9 FBC-B: 708.1 & 1020.2 .3, FFPC: 12.3.3) eways exit access ramps FBC-B: 804) FBC-B: 804) FBC-B: 804) FFPC: 38.2.5.3)	Ohr Ohr Ohr Ohr Ohr Ohr Ohr Ohr N/A N/A N/A N/A N/A Ohr B B C Class I or II A B B C Class II 100' 75'	Ohr Ohr Ohr Ohr Ohr Ohr Ohr Ohr N/A N/A N/A N/A N/A N/A N/A A, B A,	Building is sprinklered
Nonbearing Interior Walls and Partitions Floor Construction Roof Construction Rinimum Fire Resistance Stair Shaft Fire Walls Tenant Separations Occupancy Separations Horizontal Exit Corridors Jassification of Finishes (FBC-B: Table 803.11, FFPC: 38.3 Business Areas: Interior exit stairways, int. exit ramps and exit passag Corridors and enclosure for exit access stairways and Rooms and enclosed spaces Exit enclosure and exit access corridors - floor finish (Include a stairways) Assempbly Areas: Enclosed stairways Lobbies Corridors General Assembly Areas less than 300 occupants Exit enclosure and exit access corridors - floor finish (Include a stairways) Lobbies Corridors General Assembly Areas less than 300 occupants Exit enclosure and exit access corridors - floor finish (Include a stairways) Exit Travel Distance (FBC-B: Table 1017.2, FFBP: 12.2.6.2, Business Maximum Travel Distance Assembly Maximum Travel Distance Assembly Maximum Travel Distance Assembly Maximum Travel Distance Minimum Corridor Width (FBC-B: Table 1020.3, FFPC: 12.1) Minimum Corridor Width (FBC-B: Table 1020.3, FFPC: 12.1) Minimum Corridor Width (FBC-B: Table 1020.3, FFPC: 12.1)	FBC-B: 7012.1.9 FBC-B: 708.1 & 1020.2 3, FFPC: 12.3.3) eways exit access ramps FBC-B: 804) FBC-B: 804) CC: 38.2.5.3) FFPC: 38.2.6.3)	Ohr Ohr Ohr Ohr Ohr Ohr Ohr Ohr N/A N/A N/A N/A N/A N/A Ohr B B C Class I or II A B B C Class II 100' 75'	Ohr Ohr Ohr Ohr Ohr Ohr Ohr N/A N/A N/A N/A N/A N/A N/A A N/A Ohr A, B A, B A, B, C Class I or II A A, B A	Building is sprinklered
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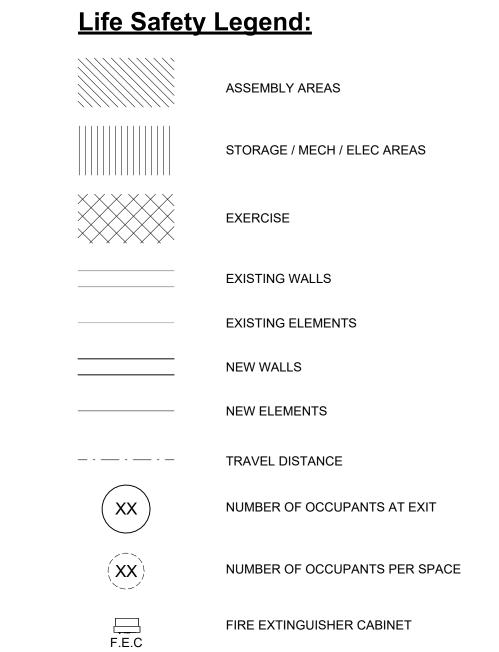


2 Basement - Life Safety 3/32" = 1'-0"

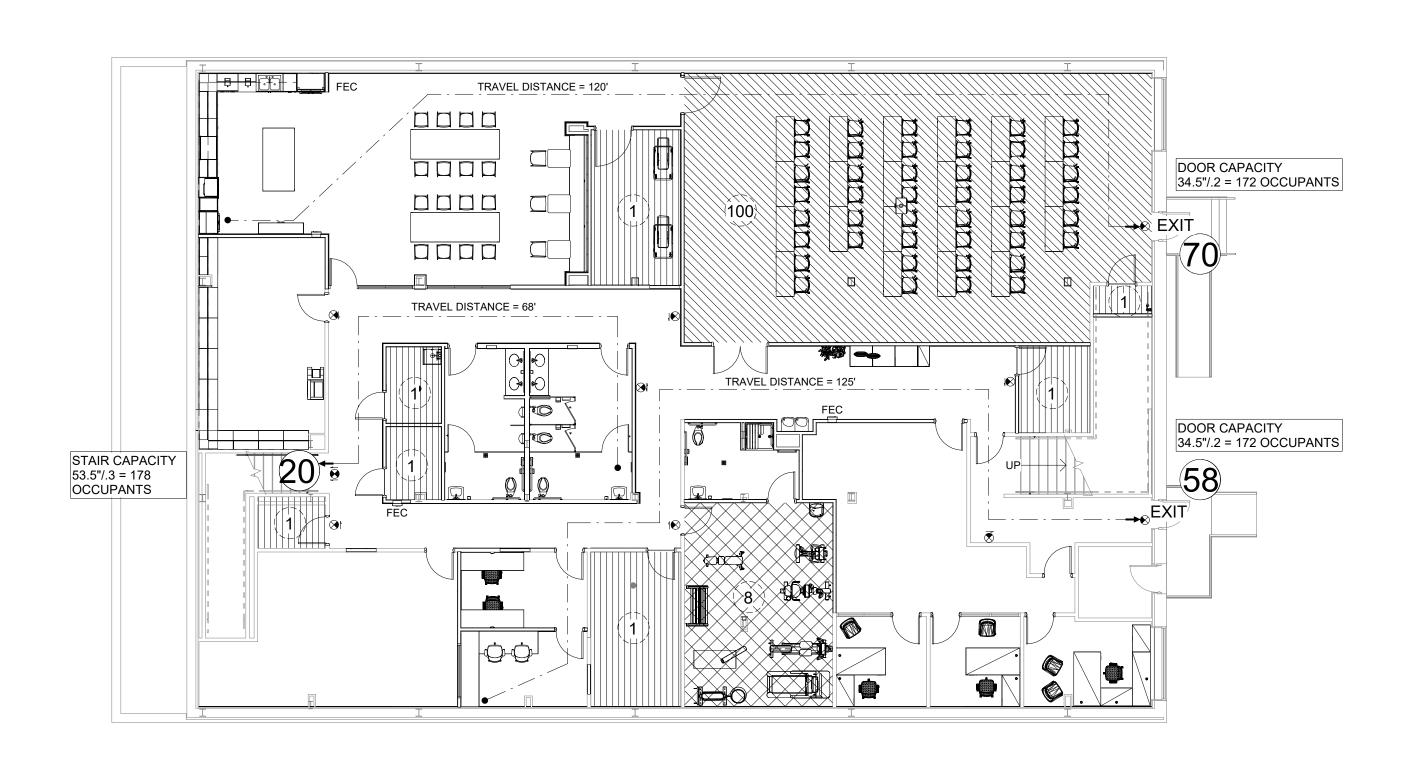

Life Safety Plan General Notes:

1. SEE ELECTRICAL DRAWINGS FOR INFORMATION ON EMERGENCY EGRESS LIGHTING LOCATIONS AND/OR FIRE ALARM INFOMRATION.



EXIT SIGN

ARCHITECTURE

BKJ, Inc., Architecture 1621 Physicians Dr. Tallahassee, Florida 32308 (P) 850.778.8007 | (F) 850.546.6150 www.bkjarchitecture.com FL Architecture Corporation AA26002280

SEAL:

PROJECT TITLE:

Z

FICE RENOVATION 117 Thomasville Road Tallahassee, Florida

JOB NO.: 24.121

DESIGNED: BD/ML

DRAWN: JH/MP

CHECKED: BD/ML

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100% Construction
Documents


DRAWING TITLE:

Life Safety Plans & Code Summary

SHEET NO.:

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DATE:

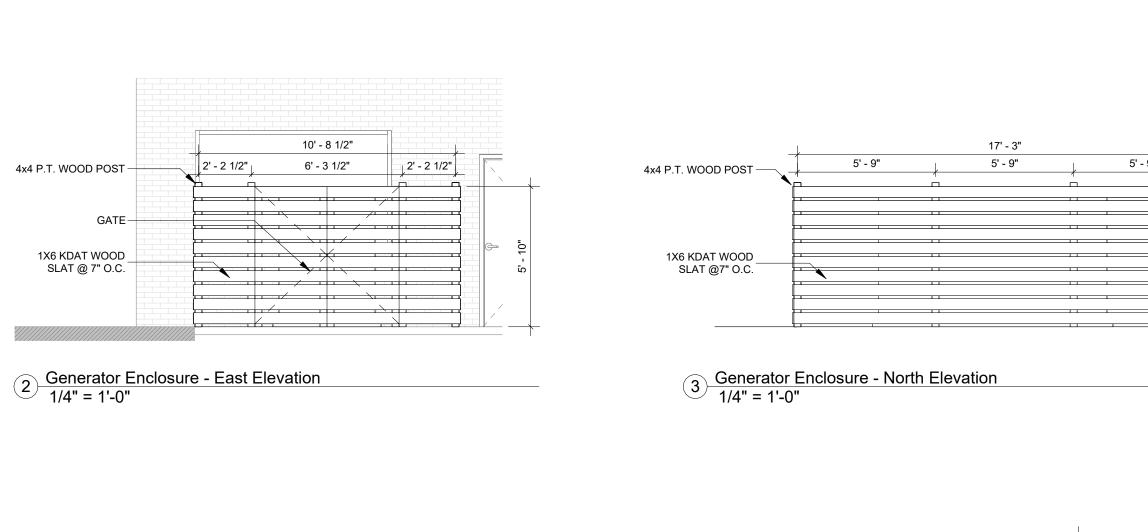


Site Plan Keynotes:

- 1 APPROX. LOCATION OF WALL MOUNTED DOCKING STATION
- 2 APPROX. LOCATION OF GAS METER
- FENCED ENCLOSURE TO BE A MINIMUM OF 3' CLEARANCE ON ALL SIDES OF GENERATOR. COORDINATE WITH ELECTRICAL DWGS.
- EQUIPMENT CONCRETE PAD PER ELECTRICAL SPECIFICATIONS
- 5 APPROX. LOCATION OF NEW HOSE BIB. COORDINATE W/ PLUMBING DWGS.

Site Plan General Notes:

1. STAIN WOOD ENCLOSURE. COLOR TBD

2. REPAIR/PATCH ASPHALT PARKING LOT AS NEEDED FOR NEW FIRE MAIN, GAS LINE, AND FIRE ALARM CONDUIT, THAT WILL BE ROUTED FROM THE EAST SIDE OF THE PARKING LOT AT GADSDEN STREET TO THE BUILDING.

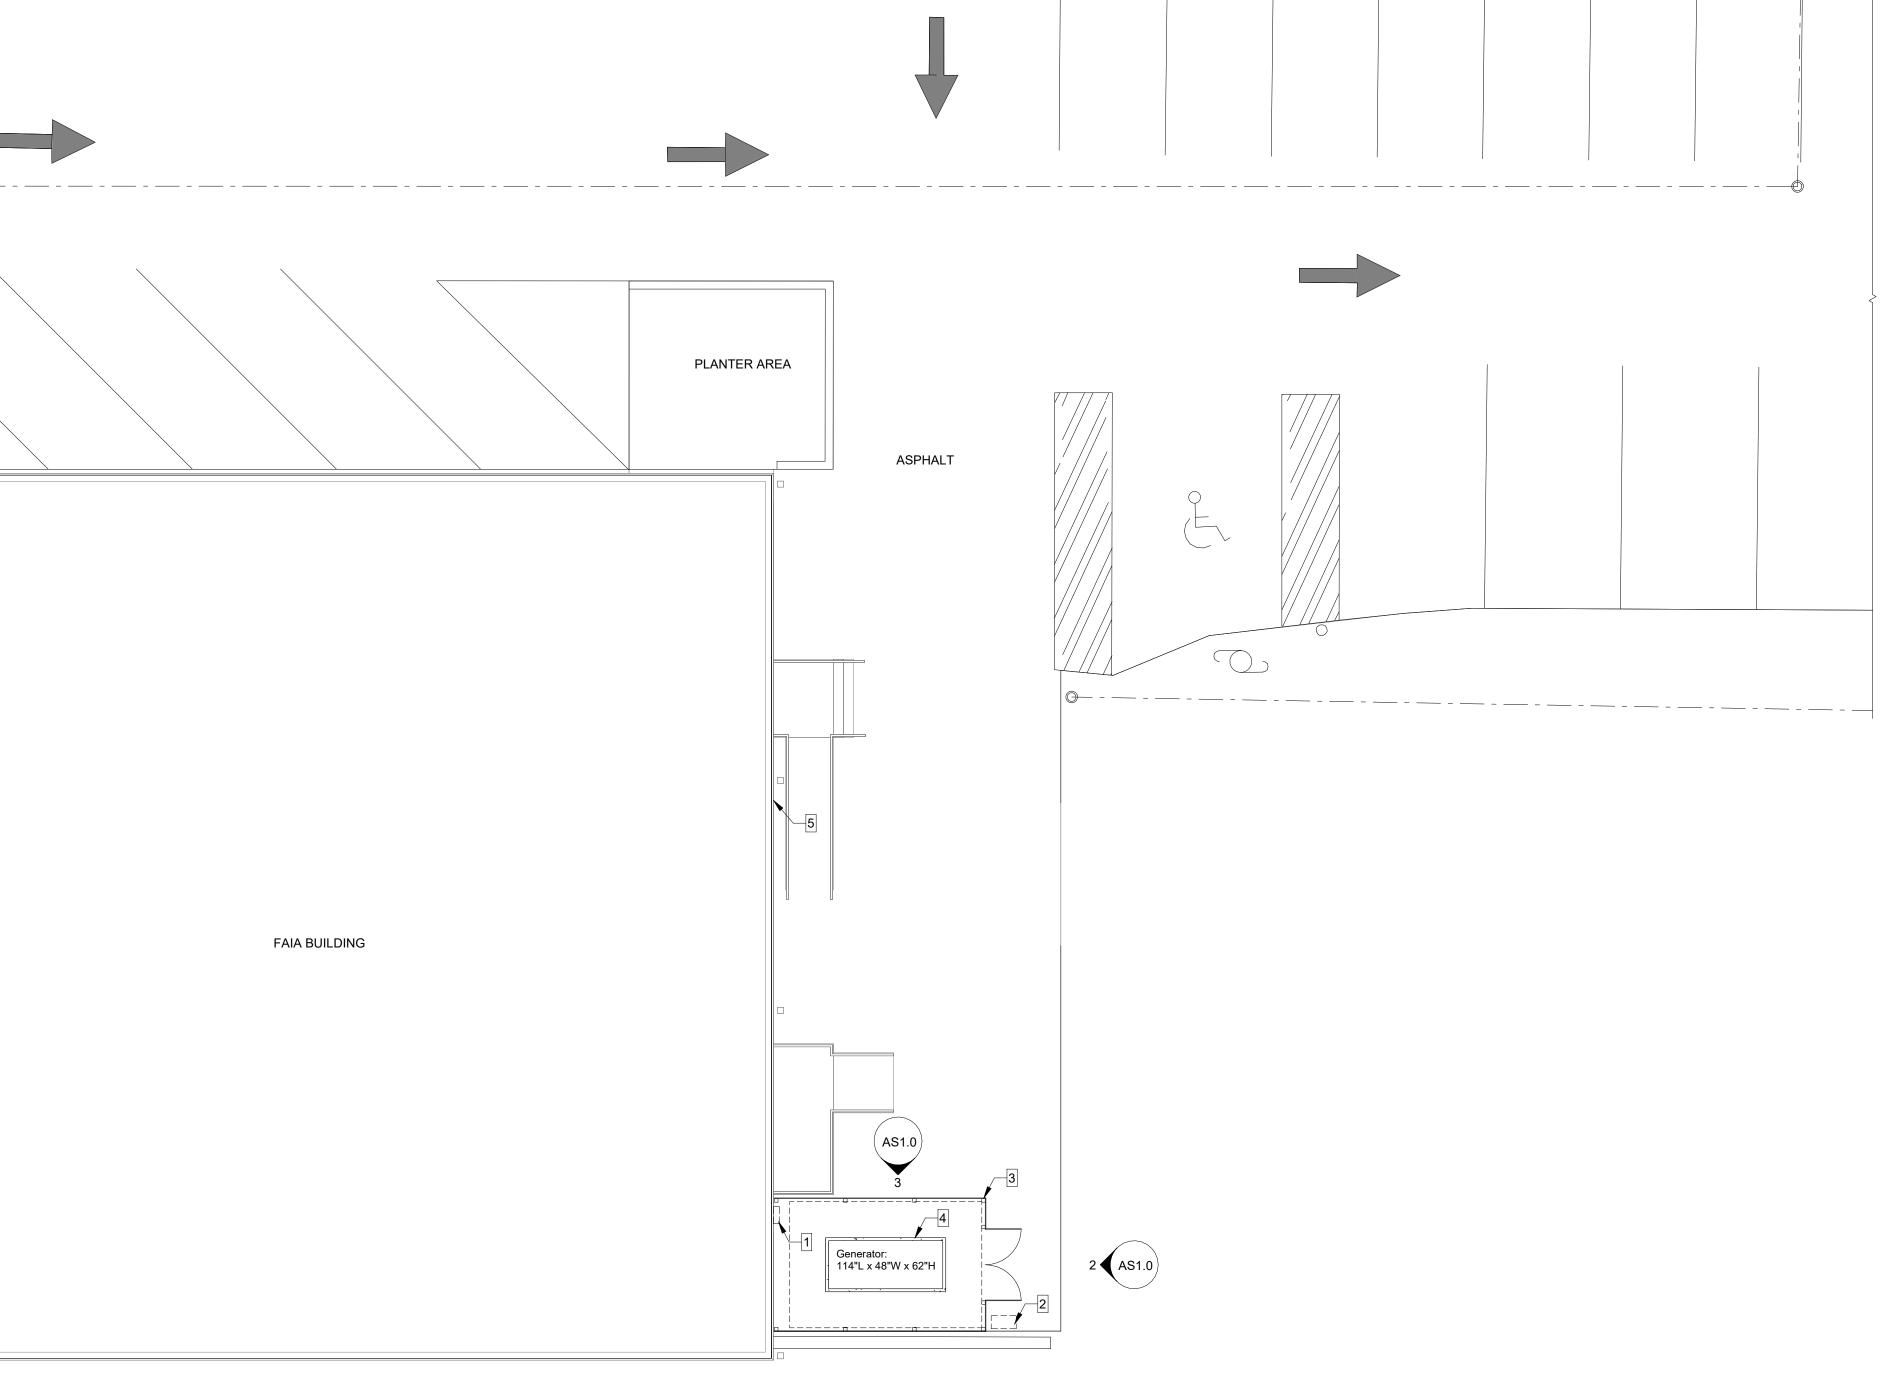

ARCHITECTURE


BKJ, Inc., Architecture 1621 Physicians Dr. Tallahassee, Florida 32308 (P) 850.778.8007 | (F) 850.546.6150 www.bkjarchitecture.com FL Architecture Corporation AA26002280

SEAL:

PROJECT TITLE:

FICE RENOVATION
117 Thomasville Road

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DRAWING PHASE:

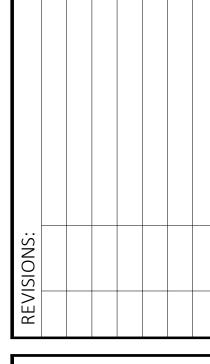100% Construction

Documents

DRAWING TITLE:

Architectural Site Plan

SHEET NO.:

AS1.0

DATE:

August 18, 2025

1 Enlarged Architectual Site Plan 1/8" = 1'-0"



1 Basement Level Demolition Plan 3/16" = 1'-0"

General Demolition Notes:

1. ALL DASHED WALLS ARE TO BE REMOVED AS INDICATED PER LEGEND. DOORS WITHIN WALLS TO BE REMOVED SHALL BE REMOVED INCLUDING ALL ASSOCIATED TRIMS AND HARDWARE UNLESS SPECIFICALLY INDICATED TO BE SALVAGED.

2. "SAFE-OFF" M.P.E. SYSTEMS BY QUALIFIED MECHANICAL, PLUMBING, AND ELECTRICAL CONTRACTOR, AS REQUIRED.

3. ALL DAMAGE TO FINISH SURFACES AND ALL THROUGH-SLAB OR WALL PENETRATIONS THAT REMAIN FOLLOWING THE DEMOLITION OF EXISTING WALLS SHALL BE NOTED BY CONTRACTOR FOR REPAIR AND SEALING DURING RENOVATION.

4. REMOVE MISCELLANEOUS WALL-MOUNTED ITEMS WITHIN THE WORK AREA, INCLUDING TACK BOARDS, WHITE BOARDS, CLOCKS. COORDINATE STORAGE AND REINSTALLATION W/ OWNER, UNLESS OTHERWISE NOTED.

5. REMOVE AND DISPOSE OF EXISTING WALL BASE ON WALLS TO REMAIN. PREPARE SUBSTRATE FOR NEW WALL BASE INCLUDING WALL REPAIRS NEEDED AFTER BASE REMOVAL

6. REMOVE AND DISPOSE OF ALL EXISTING WINDOW BLINDS.

7. REMOVE AND DISPOSE OF ALL WALL-MOUNTED EMERGENCY LIGHTS. COORDINATE WITH ELECTRICAL DWGS.

8. DURING DEMOLITION, VISUALLY INSPECT EXISTING FRAMING/GYPSUM BOARD WRAP AROUND STRUCTURAL COLUMNS. IF OVERALL DIMENSIONS OF WRAPPED COLUMNS CAN BE REDUCED, DEMO AND REPLACE FRAMING AND GYPSUM BOARD.

Demolition Plan Legend:

EXISTING WALLS

EXISTING ELEMENTS

WALLS TO BE DEMOLISHED

ELEMENTS TO BE DEMOLISHED

Demolition Keynotes:

- REMOVE AND DISPOSE OF EXISTING FLOOR FINISH AND WALL BASE TO SOLID SUBSTRATE TO EXTENTS SHOWN. PREPARE SUBSTRATE FOR NEW FINISH INCLUDING FLOOR TOPPING AND PATCHING. SEE FINISH FLOOR PLAN.
- B REMOVE AND DISPOSE OF EXISTING STOREFRONT SYSTEM AND HARDWARE.
- C1 REMOVE AND DISPOSE OF EXISTING DOOR, HARDWARE, AND FRAME. COORDINATE OPENING SIZE W/ NEW WORK.
- C2 REMOVE AND DISPOSE OF EXISTING DOOR. FRAME TO REMAIN.
- REMOVE AND DISPOSE OF EXISTING HOLLOW METAL FRAMES AND INTERIOR WINDOWS. COORDINATE SIZE OF OPENING W/ NEW WORK.
- E REMOVE PORTION OF WALL FOR NEW OPENING. COORDINATE W/ NEW WORK.
- F PROTECT EXISTING STRUCTURAL COLUMNS AND FRAME FROM DAMAGE THROUGHOUT ALL PHASES OF CONSTRUCTION. COORDINATE W/ NEW WORK.
- G REMOVE AND DISPOSE OF ALL PLUMBING FIXTURES. COORDINATE WITH PLUMBING
- H REMOVE AND DISPOSE OF EXISTING RESTROOM PARTITIONS.
- REMOVE AND DISPOSE OF EXISTING MILLWORK.
- J1 EXISTING WALL MOUNTING T.V. AND SHELF TO BE REMOVED AND RETURNED TO
- J2 REMOVE AND DISPOSE EXISTING WALL MOUNTING T.V. AND ASSOCIATED SHELF.
- K EXISTING FLOOR DRAIN TO BE REMOVED AND RELOCATED. COORDINATE WITH
- L REMOVE AND DISPOSE OF EXISTING DESK TO EXTENTS SHOWN. COORDINATE W/
- M1 REMOVED AND DISPOSED OF EXISTING F.E.C. COORDINATE W/ NEW WORK.
- M2 REMOVED AND DISPOSED OF EXISTING F.E. COORDINATE W/ NEW WORK.
- N COORDINATE REMOVAL OF EXISTING WALL MOUNTED PANELS WITH OWNER.

 O REMOVE AND DISPOSE OF EXISTING REFRIGERATORS AND MISC. EQUIPMENT.
- P REMOVE AND DISPOSE EXISTING ELECTRICAL PANELS AND I.T. RACKS. COORDINATE W/ ELECTRICAL DWG.
- Q REMOVE AND DISPOSE OF EXISTING LARGE ELECTRICAL SCREEN STAND AND ENTERTAINMENT CABINET.
- R REMOVE AND DISPOSE OF LOW WALL VENT. COORDINATE WALL INFILL W/ NEW
- S REMOVE AND DISPOSE OF EXISTING MIRRORS ON WALLS.
- T REMOVE AND DISPOSE OF EXISTING SHELVING.
- U REMOVE AND DISPOSE OF EXISTING MECH. UNIT. COORDINATE WITH MECHANICAL
- REMOVE CEILING GRID/TILES, LIGHTS, REGISTERS, SMOKE DETECTORS, EXIT LIGHTS, AND ANY ADDITIONAL CEILING MOUNTED DEVICE. REFER TO MEP DRAWINGS FOR ITEMS TO BE REUSED IN RENOVATION.
- W REMOVE GYPSUM BOARD CEILING, LIGHTS, REGISTERS, SMOKE DETECTORS, EXIT LIGHTS, EXHAUST FANS, AND ANY ADDITIONAL CEILING MOUNTED DEVICE.
- X PROTECT EXISTING GYPSUM BOARD CEILING SYSTEM DURING DEMO PHASE.
- COORDINATE W/ NEW WORK.
- Y REMOVE AND DISPOSE OF EXISTING WALL MOUNTED LIGHT.
- Z REMOVE WALL FOR NEW OPENING. COORDINATE W/ NEW WORK.
- DEMO LAYER OF GYPSUM BOARD TO ADD SOUND BATT INSULATION IN WALL BETWEEN NEW RESTROOM AND NEW CONFERENCE ROOM. COORDINATE W/ NEW WORK.

ARCHITECTURE

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SEAL:

PROJECT TITLE:

E RENOVATION Thomasville Road ahassee, Florida

JOB NO.: 24.121

DESIGNED: BD

DRAWN: JH/MP

CHECKED: BD/ML

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DRAWING TITLE:

Basement Level Demolition Plan

SHEET NO.:

AD1.0

DATE:



1 First Level Demolition Plan
3/16" = 1'-0"



General Demolition Notes:

1. ALL DASHED WALLS ARE TO BE REMOVED AS INDICATED PER LEGEND. DOORS WITHIN WALLS TO BE REMOVED SHALL BE REMOVED INCLUDING ALL ASSOCIATED TRIMS AND HARDWARE UNLESS SPECIFICALLY INDICATED TO BE SALVAGED.

2. "SAFE-OFF" M.P.E. SYSTEMS BY QUALIFIED MECHANICAL, PLUMBING, AND ELECTRICAL CONTRACTOR, AS REQUIRED.

3. ALL DAMAGE TO FINISH SURFACES AND ALL THROUGH-SLAB OR WALL PENETRATIONS THAT REMAIN FOLLOWING THE DEMOLITION OF EXISTING WALLS SHALL BE NOTED BY CONTRACTOR FOR REPAIR AND SEALING DURING RENOVATION.

4. REMOVE MISCELLANEOUS WALL-MOUNTED ITEMS WITHIN THE WORK AREA, INCLUDING TACK BOARDS, WHITE BOARDS, CLOCKS. COORDINATE STORAGE AND REINSTALLATION W/ OWNER, UNLESS OTHERWISE NOTED.

5. REMOVE AND DISPOSE OF EXISTING WALL BASE ON WALLS TO REMAIN. PREPARE SUBSTRATE FOR NEW WALL BASE INCLUDING WALL REPAIRS NEEDED AFTER BASE

6. REMOVE AND DISPOSE OF ALL EXISTING WINDOW BLINDS.

7. REMOVE AND DISPOSE OF ALL WALL-MOUNTED EMERGENCY LIGHTS. COORDINATE WITH ELECTRICAL DWGS.


8. DURING DEMOLITION, VISUALLY INSPECT EXISTING FRAMING/GYPSUM BOARD WRAP AROUND STRUCTURAL COLUMNS. IF OVERALL DIMENSIONS OF WRAPPED COLUMNS CAN BE REDUCED, DEMO AND REPLACE FRAMING AND GYPSUM BOARD.

Demolition Plan Legend:

EXISTING WALLS EXISTING ELEMENTS _ _ _ _ _ _ _ WALLS TO BE DEMOLISHED ELEMENTS TO BE DEMOLISHED

Demolition Keynotes:

- A REMOVE AND DISPOSE OF EXISTING FLOOR FINISH AND WALL BASE TO SOLID SUBSTRATE TO EXTENTS SHOWN. PREPARE SUBSTRATE FOR NEW FINISH INCLUDING FLOOR TOPPING AND PATCHING. - SEE FINISH FLOOR PLAN.
- B REMOVE AND DISPOSE OF EXISTING STOREFRONT SYSTEM AND HARDWARE.
- C1 REMOVE AND DISPOSE OF EXISTING DOOR, HARDWARE, AND FRAME. COORDINATE OPENING SIZE W/ NEW WORK.
- C2 REMOVE AND DISPOSE OF EXISTING DOOR. FRAME TO REMAIN.
- D REMOVE AND DISPOSE OF EXISTING HOLLOW METAL FRAMES AND INTERIOR WINDOWS. - COORDINATE SIZE OF OPENING W/ NEW WORK.
- E REMOVE PORTION OF WALL FOR NEW OPENING. COORDINATE W/ NEW WORK.
- F PROTECT EXISTING STRUCTURAL COLUMNS AND FRAME FROM DAMAGE
- THROUGHOUT ALL PHASES OF CONSTRUCTION. COORDINATE W/ NEW WORK. G REMOVE AND DISPOSE OF ALL PLUMBING FIXTURES. COORDINATE WITH PLUMBING
- H REMOVE AND DISPOSE OF EXISTING RESTROOM PARTITIONS.
- I REMOVE AND DISPOSE OF EXISTING MILLWORK.
- J1 EXISTING WALL MOUNTING T.V. AND SHELF TO BE REMOVED AND RETURNED TO
- J2 REMOVE AND DISPOSE EXISTING WALL MOUNTING T.V. AND ASSOCIATED SHELF.
- K EXISTING FLOOR DRAIN TO BE REMOVED AND RELOCATED. COORDINATE WITH
- L REMOVE AND DISPOSE OF EXISTING DESK TO EXTENTS SHOWN. COORDINATE W/
- M1 REMOVED AND DISPOSED OF EXISTING F.E.C. COORDINATE W/ NEW WORK.
- M2 REMOVED AND DISPOSED OF EXISTING F.E. COORDINATE W/ NEW WORK. N COORDINATE REMOVAL OF EXISTING WALL MOUNTED PANELS WITH OWNER.
- O REMOVE AND DISPOSE OF EXISTING REFRIGERATORS AND MISC. EQUIPMENT.
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- T REMOVE AND DISPOSE OF EXISTING SHELVING.
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- AA DEMO LAYER OF GYPSUM BOARD TO ADD SOUND BATT INSULATION IN WALL BETWEEN NEW RESTROOM AND NEW CONFERENCE ROOM. COORDINATE W/ NEW WORK.

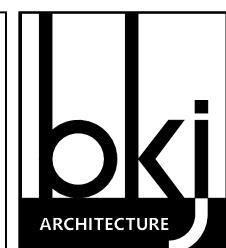

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FL Architecture Corporation AA26002280

SEAL:

PROJECT TITLE:

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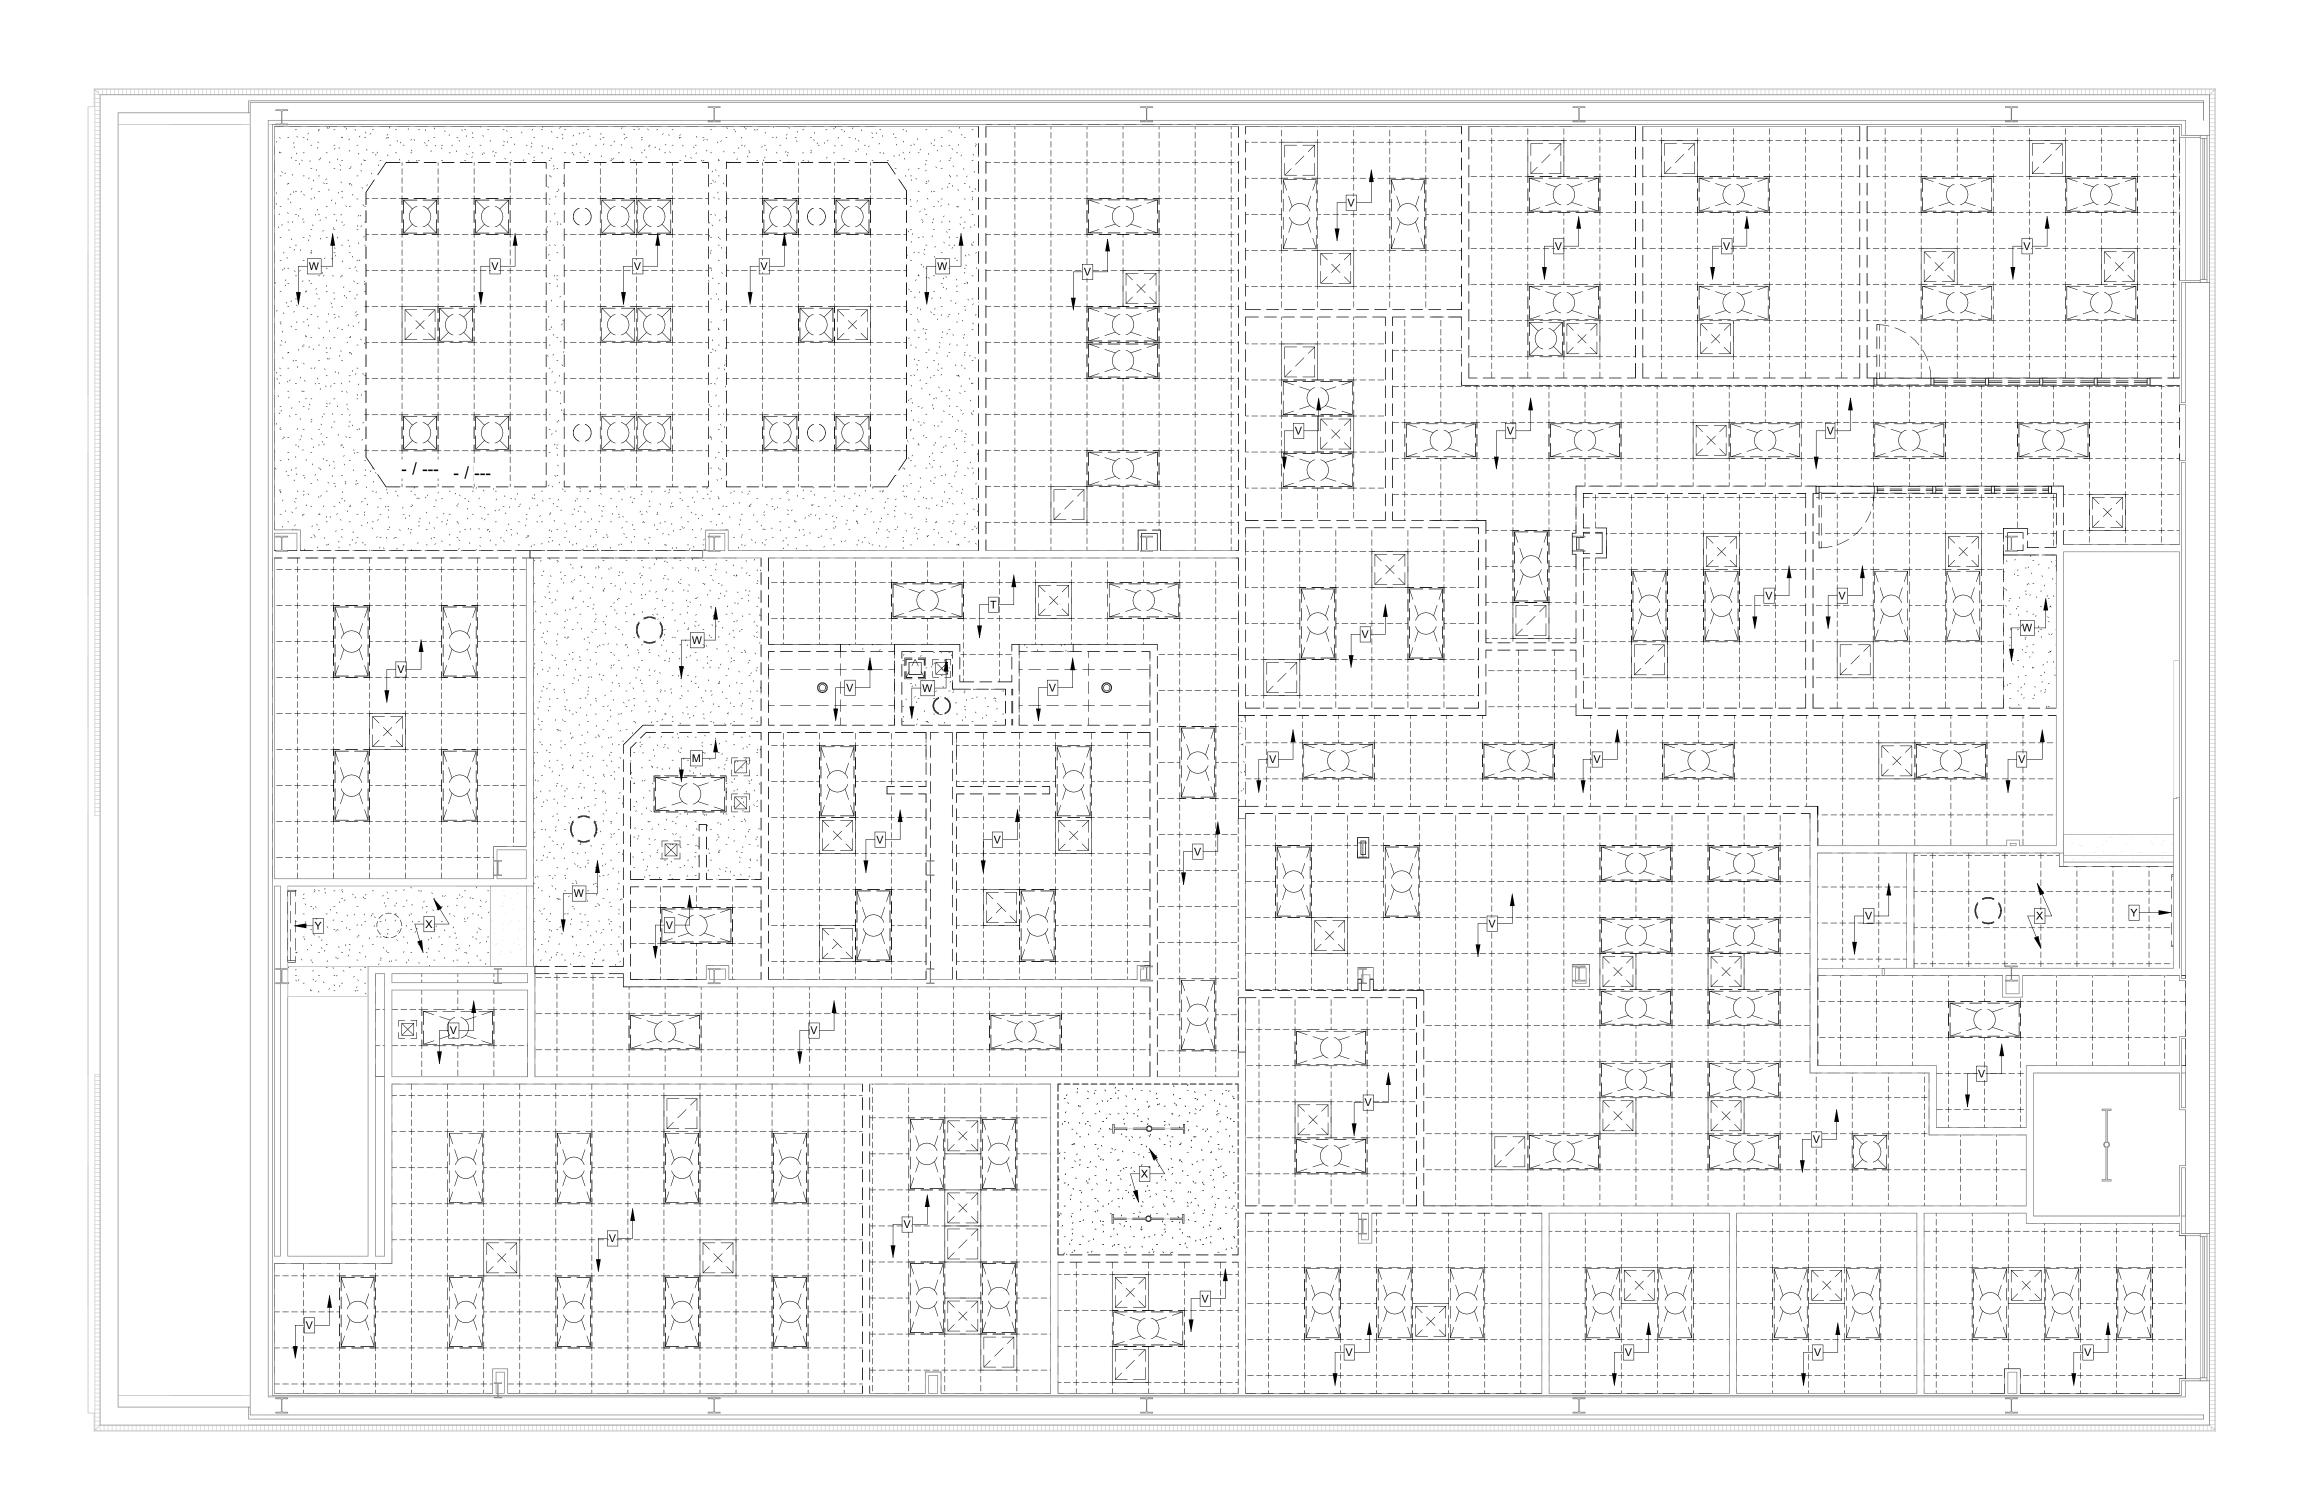
DRAWING TITLE:

First Level **Demolition Plan**

SHEET NO.:

AD1.1

DATE:



1 Basement Level -Demolition RCP 3/16" = 1'-0"



General Demolition Notes:

1. ALL DASHED WALLS ARE TO BE REMOVED AS INDICATED PER LEGEND. DOORS WITHIN WALLS TO BE REMOVED SHALL BE REMOVED INCLUDING ALL ASSOCIATED TRIMS AND HARDWARE UNLESS SPECIFICALLY INDICATED TO BE SALVAGED.

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6. REMOVE AND DISPOSE OF ALL EXISTING WINDOW BLINDS.

7. REMOVE AND DISPOSE OF ALL WALL-MOUNTED EMERGENCY LIGHTS. COORDINATE WITH ELECTRICAL DWGS.

8. DURING DEMOLITION, VISUALLY INSPECT EXISTING FRAMING/GYPSUM BOARD WRAP AROUND STRUCTURAL COLUMNS. IF OVERALL DIMENSIONS OF WRAPPED COLUMNS CAN BE REDUCED, DEMO AND REPLACE FRAMING AND GYPSUM BOARD.

Demolition RCP Legend:

EXISTING WALLS

EXISTING ELEMENTS

WALLS TO BE DEMOLISHED

ELEMENTS TO BE DEMOLISHED

EXISTING GYPSUM BOARD TO REMAIN

DEMO. GYPSUM BOARD

Demolition Keynotes:

- REMOVE AND DISPOSE OF EXISTING FLOOR FINISH AND WALL BASE TO SOLID SUBSTRATE TO EXTENTS SHOWN. PREPARE SUBSTRATE FOR NEW FINISH INCLUDING FLOOR TOPPING AND PATCHING. SEE FINISH FLOOR PLAN.
- B REMOVE AND DISPOSE OF EXISTING STOREFRONT SYSTEM AND HARDWARE.
- C1 REMOVE AND DISPOSE OF EXISTING DOOR, HARDWARE, AND FRAME. COORDINATE OPENING SIZE W/ NEW WORK.
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- F PROTECT EXISTING STRUCTURAL COLUMNS AND FRAME FROM DAMAGE
- THROUGHOUT ALL PHASES OF CONSTRUCTION. COORDINATE W/ NEW WORK.

 G REMOVE AND DISPOSE OF ALL PLUMBING FIXTURES. COORDINATE WITH PLUMBING
- H REMOVE AND DISPOSE OF EXISTING RESTROOM PARTITIONS.
- I REMOVE AND DISPOSE OF EXISTING MILLWORK.
- J1 EXISTING WALL MOUNTING T.V. AND SHELF TO BE REMOVED AND RETURNED TO
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SEAL:

PROJECT TITLE:

Z 7

E RENOVATIO Thomasville Road lahassee, Florida

JOB NO.: 24.121

DESIGNED: BD

DRAWN: JH/MP

CHECKED: BD/ML

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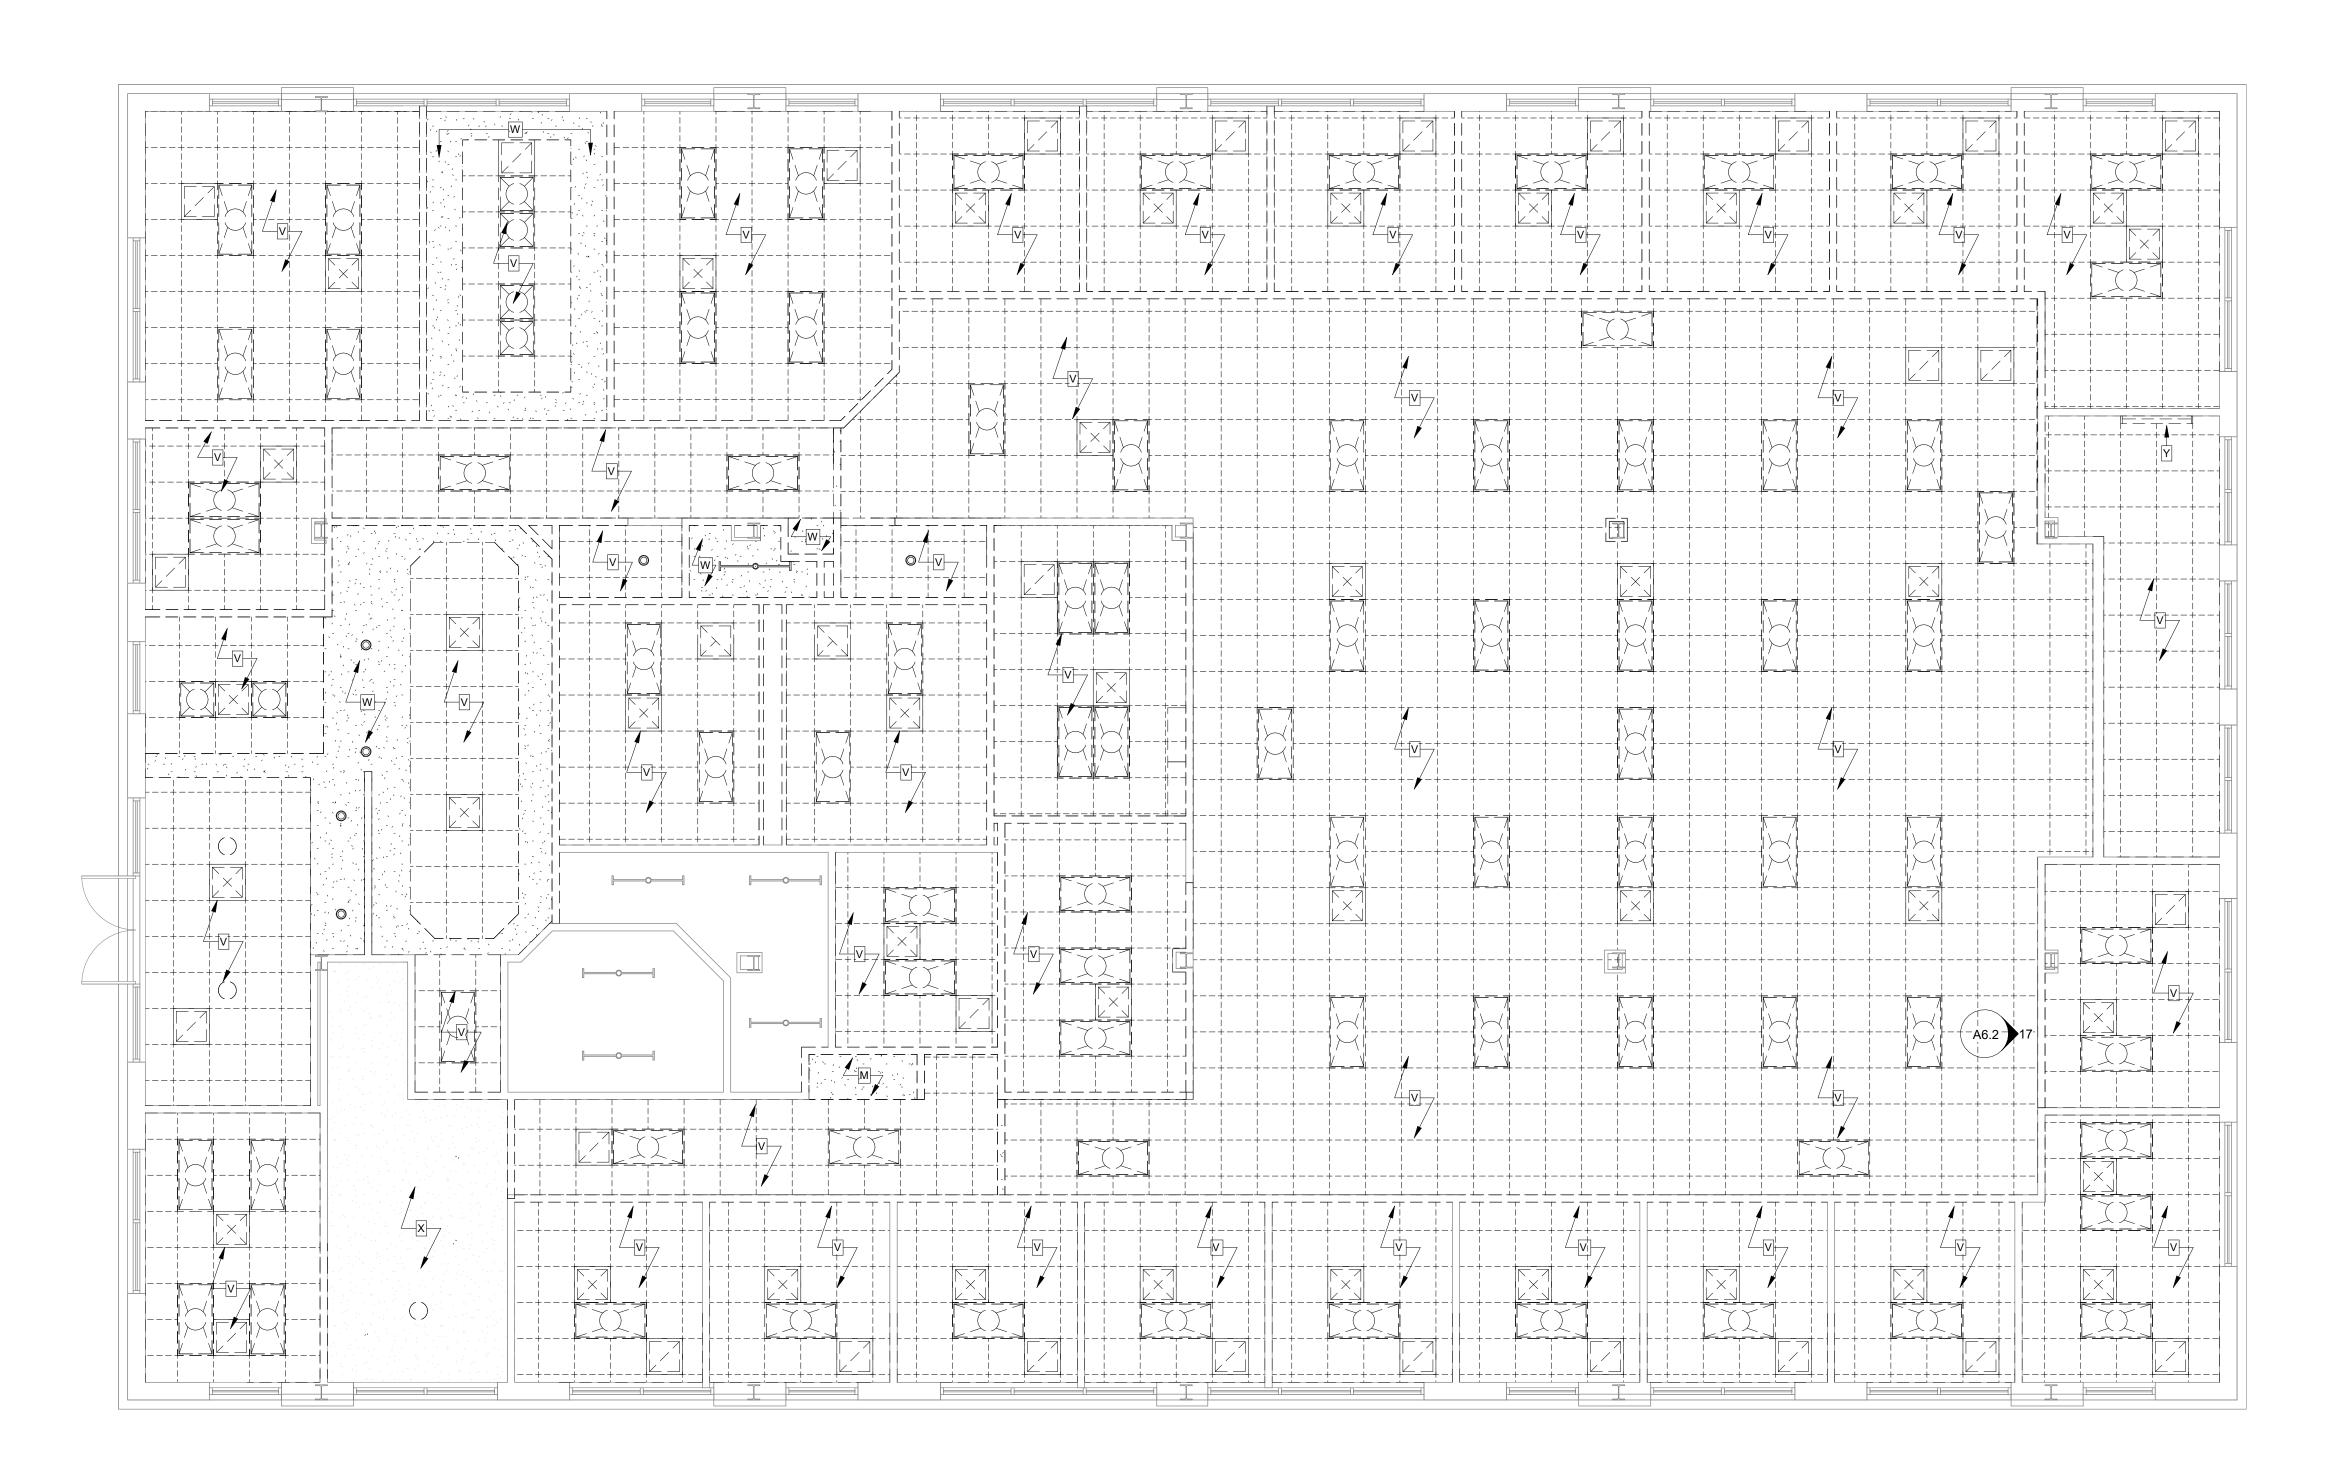
DRAWING TITLE:

Basement Level Demolition RCP

SHEET NO.:

AD1.2

DATE:



1 First Level Demolition RCP 3/16" = 1'-0"



General Demolition Notes:

1. ALL DASHED WALLS ARE TO BE REMOVED AS INDICATED PER LEGEND. DOORS WITHIN WALLS TO BE REMOVED SHALL BE REMOVED INCLUDING ALL ASSOCIATED TRIMS AND HARDWARE UNLESS SPECIFICALLY INDICATED TO BE SALVAGED.

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Demolition RCP Legend:

EXISTING WALLS

EXISTING ELEMENTS

WALLS TO BE DEMOLISHED

ELEMENTS TO BE DEMOLISHED

EXISTING GYPSUM BOARD TO REMAIN

DEMO. GYPSUM BOARD

Demolition Keynotes:

- REMOVE AND DISPOSE OF EXISTING FLOOR FINISH AND WALL BASE TO SOLID SUBSTRATE TO EXTENTS SHOWN. PREPARE SUBSTRATE FOR NEW FINISH INCLUDING FLOOR TOPPING AND PATCHING. SEE FINISH FLOOR PLAN.
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 M2 REMOVED AND DISPOSED OF EXISTING F.E. COORDINATE W/ NEW WORK.
- N COORDINATE REMOVAL OF EXISTING WALL MOUNTED PANELS WITH OWNER.
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SEAL:

PROJECT TITLE:


RENOVATION omasville Road assee. Florida

JOB NO.: 24.121 DESIGNED: BD

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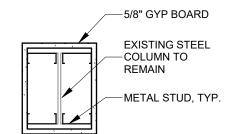
DRAWING TITLE:

First Level Demolition

SHEET NO.:

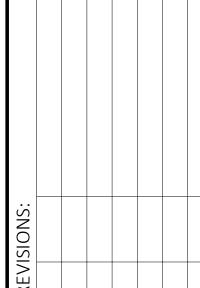
AD1.3

DATE:



NOTE: SIZE OF THE EXISTING COLUMN IS UNKNOWN. INTENT IS TO PROVIDE SMALLEST COLUMN WRAP ACHIEVABLE.

2 Column Wrap Detail - Typical 1" = 1'-0"

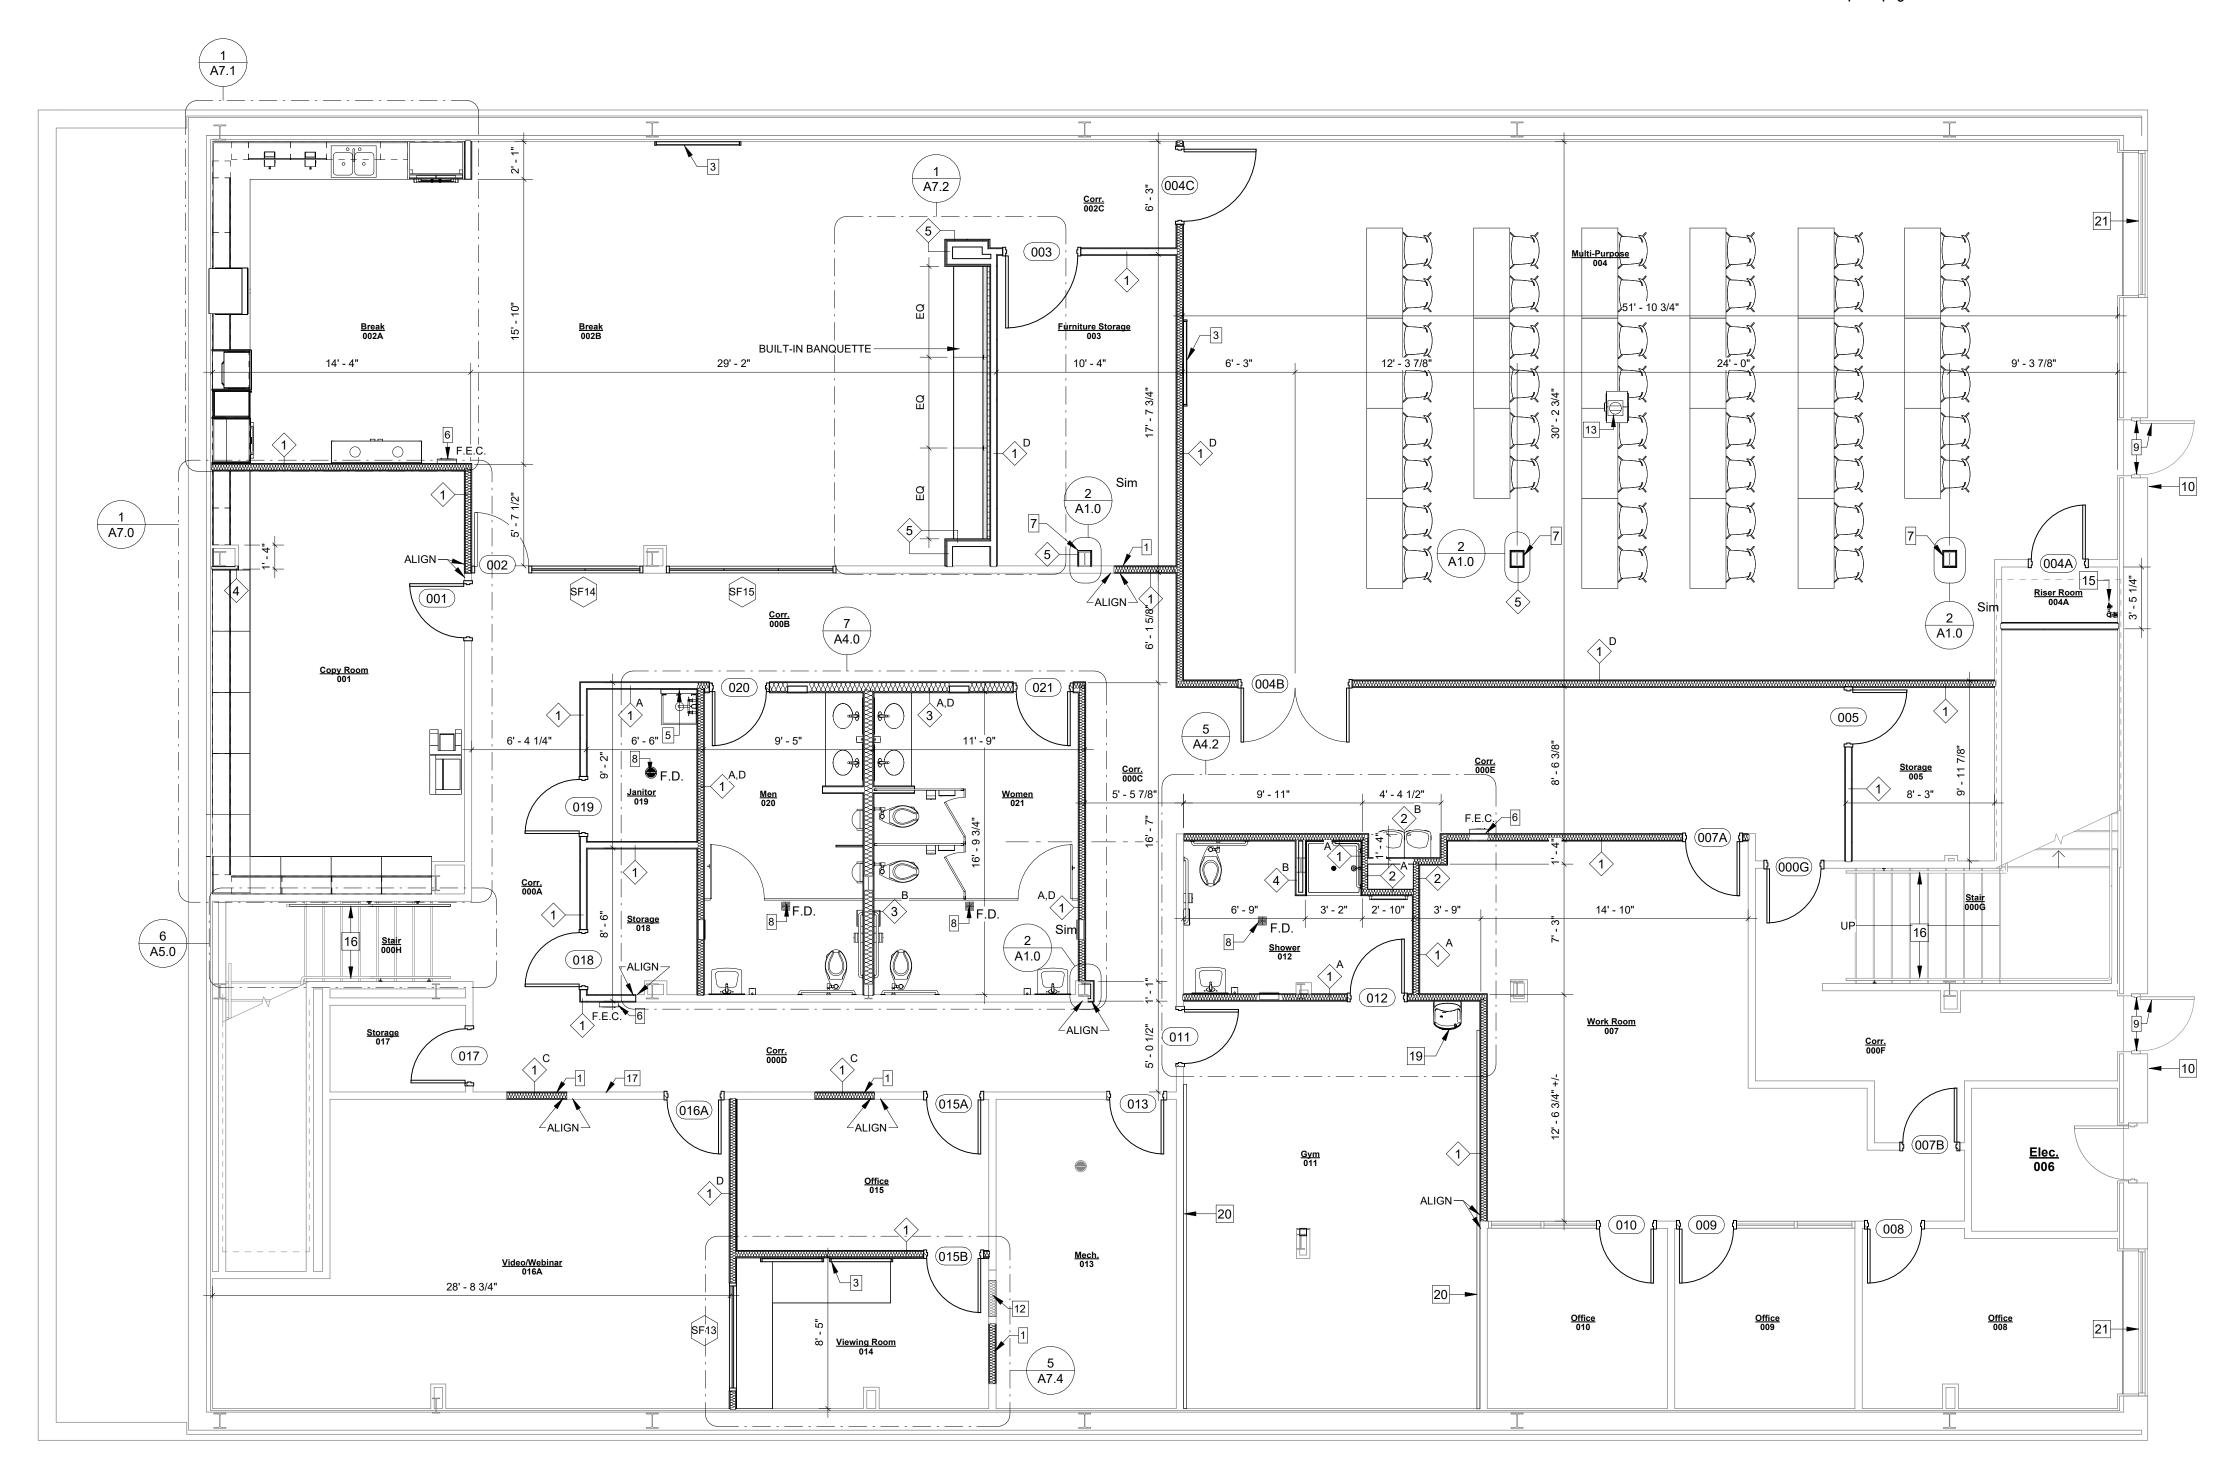

Basement Level Floor Plan
3/16" = 1'-0"



Floor Plan General Notes:

1. ALL DIMENSIONS FOR NEW PARTITIONS ARE TO FACE OF STUD. DIMENSIONS TO EXISTING WALLS ARE TO FACE OF FINISH SURFACE.

2. ALL DOOR OPENINGS TO BE LOCATED 6" FROM FACE OF STUD OF ADJACENT WALL ON HINGE SIDE UNLESS OTHERWISE NOTED. SEE DOOR SCHEDULE COMMENTS AND PLAN DIMENSIONS.

3. FIRE EXTINGUISHERS SHALL BE MOUNTED BETWEEN 41" MIN. AND 48" MAX. ABOVE FINISH FLOOR. PORTABLE FIRE EXTINGUISHERS SHALL BEAR THE LABEL OF AN APPROVED AGENCY, BE AN APPROVED TYPE, AND BE INSTALLED IN A LOCATION VISIBLE AND ACCESSIBLE TO THE OCCUPANTS. VERIFY LOCATION IN FIELD WITH FIRE MARSHALL.

4. PROVIDE PLYWOOD BLOCKING BEHIND GYP. BOARD TO SUPPORT EQUIPMENT AND/OR MISC. ITEMS INSTALLED (MILLWORK, TOILET PAPER HOLDERS, GRAB BARS, MIRRORS, KITCHEN SHELVING ETC.).

5. CONTRACTOR TO COORDINATE DELIVERY OF ALL OWNER SUPPLIED

6. CONTRACTOR TO SUBMIT SHOP DRAWINGS FOR ALL MILLWORK.

7. THE DESIGN AND CONSTRUCTION OF ALL NON-LOAD BEARING INTERIOR LIGHT GAUGE METAL FRAMING SHALL BE THE RESPONSIBILITY OF THE CONTRACTOR. AT A MINIMUM, THIS FRAMING SHALL BE CONSTRUCTED OF 20 GAUGE (30 MIL – 33 KSI) OR 20 GAUGE EQ (18 MIL – 70 KSI) METAL STUDS AND TRACK, STUDS SHALL HAVE MAXIMUM SPACING OF 16" O.C., WITH DOUBLE STUDS AT DOOR AND WINDOW JAMBS. PROVIDE A MINIMUM OF TWO #10 SELF TAPPING SCREWS AT ALL CONNECTIONS.

8. AT ALL UTILITY TRENCHES IN EXISTING SLAB, ADD 6 MIL. VAPOR BARRIER AFTER SOIL HAS BEEN TREATED. PROVIDE #3 DOWELS @ 24" O.C. ON BOTH SIDES. DRILL HOLES 6" DEEP IN ADJACENT SLAB. DOWELS TO FIT TIGHT AND SECURE IN HOLES.

9. PROVIDE WINDOW SHADES FOR ALL EXTERIOR WINDOWS ON 1ST LEVEL. WINDOW SHADES TO BE DRAPER FLEX SHADE, 3% PHIFFER SHEARWEAVE W/ FASCIA COVER SURFACE MOUNTED ON STOREFRONT.

10. SOUND BATTS TO BE PROVIDED IN NEW WALLS AS DELINEATED ON

11. PROVIDE BLOCKING FOR ALL WALL MOUNTED LARGE SCREEN MONITORS AND WHITE BOARDS. CONTRACTOR TO COORDINATE LOCATION AND HEIGHT WITH OWNER. MONITORS TO BE OWNER PROVIDED AND CONTRACTOR INSTALLED.

Floor Plan Legend:

EXISTING WALLS
 EXISTING ELEMENTS
 NEW WALLS
 NEW ELEMENTS
NEW FLOOR DRAIN

Floor Plan Keynotes:

- INFILL OPENING IN WALL. PROVIDE A SMOOTH CONTINUOUS FINISH SURFACE TO MATCH EXISTING ADJACENT WALL FINISH.
- (10) 6'-6" X 7'-6" WORKSTATIONS. SEE FINISH FLOOR PLAN
- PROVIDE BLOCKING FOR WALL MOUNTED SMART MONITOR/TV. OWNER SUPPLIED CONTRACTOR INSTALLED.
- WRAP END WALL W/ BLACK BREAK METAL AT STOREFRONT GLASS -REFER TO ENLARGED PLAN 2/A1.1
- INSTALL MOP AND BROOM HOLDER A13 (BOBRICK B-233 x 24)
- INSTALL RECESSED FIRE EXTINGUISHER CABINET
- WRAP ALL STRUCTURAL STEEL COLUMNS, TYP. SEE COLUMN WRAP DETAIL 2/A1.0
- FLOOR DRAIN. COORDINATE W/ PLUMBING DWGS.
- PAINT INTERIOR SIDE OF EXISTING DOOR AND FRAME. COLOR: TBD
- INSTALL NEW CARD SWIPE. COORDINATE WITH ELECTRICAL.
- REFINISH OR REPLACE EXISTING WOOD TRIM ON TOP OF LOW WALL TO MATCH STAIN OF NEW DOOR.
- INFILL WHERE LOW WALL VENT WAS REMOVED.
- 13 ELECTRICAL / DATA FLOOR BOX LOCATION TO BE COORDINATED W/ OWNER AND SELECTED FURNITURE. SEE ELECTRICAL DWG.
- INSTALL FAIA SIGNAGE ON WALL. PROVIDE BLOCKING AS NEEDED. COORDINATE WITH OWNER.
- AUTOMATIC SPRINKLER RISER LOCATION . COORDINATE WITH FIRE PROTECTION.
- PAINT EXISTING HANDRAILS PT-1 TO MATCH WALLS.
- INSTALL "ON AIR" WALL MOUNTED LIGHT. COORDINATE WITH
- ELECTRICAL. NOT USED
- WATER COOLER W/ BOTTLE FILLER INSTALLED WITH SPOUT HEIGHT AT 36" A.F.F. MAX
- INSTALL 6' TALL MIRRORS @ 1'-0" A.F.F. FOR A TOTAL OF 18' ON WEST WALL AND 21' ON EAST WALL PER PLAN.
- PROVIDE WINDOW SHADES FOR ALL EXTERIOR WINDOWS. WINDOW SHADES TO BE DRAPER FLEX SHADE, 3% PHIFFER SHEARWEAVE, W/ FASCIA COVER SURFACE MOUNTED ON STOREFRONT.
- INSTALL SOUND BATT INSULATION IN WALL. INSTALL NEW LAYER OF GYP. BOARD ON WALL AS NEEDED.
- CONFIRM EXISTING WALL GOES TO DECK ABOVE FOR PORTION OF WALL BETWEEN WOMEN'S RR AND CONFERENCE ROOM.
- 24 EXISTING WOOD WINDOW SILLS TO BE PAINTED PT4

1621 Physicians Dr. Tallahassee, Florida 32308 (P) 850.778.8007 | (F) 850.546.6150 www.bkjarchitecture.com
FL Architecture Corporation AA26002280

SEAL:

PROJECT TITLE:

JC	ΒN	١Ο.	: 24	1.12	21							
DE	ESIC	SNE	ED:	BD)							
DF	RAV	۷N	: Jŀ	H/M	Р							
CH	HEC	KE	D: I	3D/	ML							
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DRAWING PHASE: 100% Construction **Documents**


DRAWING TITLE:

Basement Level Floor Plan

SHEET NO.:

A1.0

DATE:

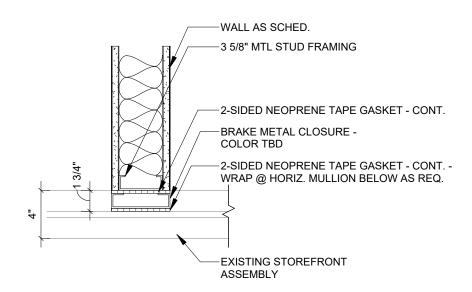

2 Enlarged Plan - Brake Metal @ Glazing Condition 1 1/2" = 1'-0"



First Level Floor Plan
3/16" = 1'-0"

Floor Plan General Notes:

1. ALL DIMENSIONS FOR NEW PARTITIONS ARE TO FACE OF STUD. DIMENSIONS TO EXISTING WALLS ARE TO FACE OF FINISH SURFACE.

2. ALL DOOR OPENINGS TO BE LOCATED 6" FROM FACE OF STUD OF ADJACENT WALL ON HINGE SIDE UNLESS OTHERWISE NOTED. SEE DOOR SCHEDULE COMMENTS AND PLAN DIMENSIONS.

3. FIRE EXTINGUISHERS SHALL BE MOUNTED BETWEEN 41" MIN. AND 48" MAX. ABOVE FINISH FLOOR. PORTABLE FIRE EXTINGUISHERS SHALL BEAR THE LABEL OF AN APPROVED AGENCY, BE AN APPROVED TYPE, AND BE INSTALLED IN A LOCATION VISIBLE AND ACCESSIBLE TO THE OCCUPANTS. VERIFY LOCATION IN FIELD WITH FIRE MARSHALL.

4. PROVIDE PLYWOOD BLOCKING BEHIND GYP. BOARD TO SUPPORT EQUIPMENT AND/OR MISC. ITEMS INSTALLED (MILLWORK, TOILET PAPER HOLDERS, GRAB BARS, MIRRORS, KITCHEN SHELVING ETC.).

5. CONTRACTOR TO COORDINATE DELIVERY OF ALL OWNER SUPPLIED

6. CONTRACTOR TO SUBMIT SHOP DRAWINGS FOR ALL MILLWORK.

7. THE DESIGN AND CONSTRUCTION OF ALL NON-LOAD BEARING INTERIOR LIGHT GAUGE METAL FRAMING SHALL BE THE RESPONSIBILITY OF THE CONTRACTOR. AT A MINIMUM, THIS FRAMING SHALL BE CONSTRUCTED OF 20 GAUGE (30 MIL – 33 KSI) OR 20 GAUGE EQ (18 MIL – 70 KSI) METAL STUDS AND TRACK, STUDS SHALL HAVE MAXIMUM SPACING OF 16" O.C., WITH DOUBLE STUDS AT DOOR AND WINDOW JAMBS. PROVIDE A MINIMUM OF TWO #10 SELF TAPPING SCREWS AT ALL CONNECTIONS.

8. AT ALL UTILITY TRENCHES IN EXISTING SLAB, ADD 6 MIL. VAPOR BARRIER AFTER SOIL HAS BEEN TREATED. PROVIDE #3 DOWELS @ 24" O.C. ON BOTH SIDES. DRILL HOLES 6" DEEP IN ADJACENT SLAB. DOWELS TO FIT TIGHT AND SECURE IN HOLES.

9. PROVIDE WINDOW SHADES FOR ALL EXTERIOR WINDOWS ON 1ST LEVEL. WINDOW SHADES TO BE DRAPER FLEX SHADE, 3% PHIFFER SHEARWEAVE W/ FASCIA COVER SURFACE MOUNTED ON STOREFRONT.

10. SOUND BATTS TO BE PROVIDED IN NEW WALLS AS DELINEATED ON PLANS.

11. PROVIDE BLOCKING FOR ALL WALL MOUNTED LARGE SCREEN MONITORS AND WHITE BOARDS. CONTRACTOR TO COORDINATE LOCATION AND HEIGHT WITH OWNER. MONITORS TO BE OWNER PROVIDED AND CONTRACTOR INSTALLED.

Floor Plan Legend:

	EXISTING WALLS
	EXISTING ELEMENTS
	NEW WALLS
	NEW ELEMENTS
∰ ⊕ F.D.	NEW FLOOR DRAIN

Floor Plan Keynotes:

- 1 INFILL OPENING IN WALL. PROVIDE A SMOOTH CONTINUOUS FINISH SURFACE TO MATCH EXISTING ADJACENT WALL FINISH.
- 2 (10) 6'-6" X 7'-6" WORKSTATIONS. SEE FINISH FLOOR PLAN
- PROVIDE BLOCKING FOR WALL MOUNTED SMART MONITOR/TV. OWNER SUPPLIED CONTRACTOR INSTALLED.
- WRAP END WALL W/ BLACK BREAK METAL AT STOREFRONT GLASS REFER TO ENLARGED PLAN 2/A1.1
- INSTALL MOP AND BROOM HOLDER A13 (BOBRICK B-233 x 24)
- INSTALL RECESSED FIRE EXTINGUISHER CABINET
- WRAP ALL STRUCTURAL STEEL COLUMNS, TYP. SEE COLUMN WRAP DETAIL 2/A1.0
- 8 FLOOR DRAIN. COORDINATE W/ PLUMBING DWGS.
- 9 PAINT INTERIOR SIDE OF EXISTING DOOR AND FRAME. COLOR: TBD
- 10 INSTALL NEW CARD SWIPE. COORDINATE WITH ELECTRICAL.
- REFINISH OR REPLACE EXISTING WOOD TRIM ON TOP OF LOW WALL TO MATCH STAIN OF NEW DOOR.
- INFILL WHERE LOW WALL VENT WAS REMOVED.
- ELECTRICAL / DATA FLOOR BOX LOCATION TO BE COORDINATED W/ OWNER AND SELECTED FURNITURE. SEE ELECTRICAL DWG.
- 14 INSTALL FAIA SIGNAGE ON WALL. PROVIDE BLOCKING AS NEEDED.
- COORDINATE WITH OWNER.

 15 AUTOMATIC SPRINKLER RISER LOCATION . COORDINATE WITH FIRE
- PROTECTION.

 16 PAINT EXISTING HANDRAILS PT-1 TO MATCH WALLS.
- INSTALL "ON AIR" WALL MOUNTED LIGHT. COORDINATE WITH
- ELECTRICAL.
- 18 NOT USED
- 19 WATER COOLER W/ BOTTLE FILLER INSTALLED WITH SPOUT HEIGHT AT 36" A.F.F. MAX
- 20 INSTALL 6' TALL MIRRORS @ 1'-0" A.F.F. FOR A TOTAL OF 18' ON WEST WALL AND 21' ON EAST WALL PER PLAN.
- PROVIDE WINDOW SHADES FOR ALL EXTERIOR WINDOWS. WINDOW SHADES TO BE DRAPER FLEX SHADE, 3% PHIFFER SHEARWEAVE, W/FASCIA COVER SURFACE MOUNTED ON STOREFRONT.
- 22 INSTALL SOUND BATT INSULATION IN WALL. INSTALL NEW LAYER OF GYP. BOARD ON WALL AS NEEDED.
- 23 CONFIRM EXISTING WALL GOES TO DECK ABOVE FOR PORTION OF WALL BETWEEN WOMEN'S RR AND CONFERENCE ROOM.
- EXISTING WOOD WINDOW SILLS TO BE PAINTED PT4

ARCHITECTURE

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SEAL:

PROJECT TITLE:

FICE RENOVATION 117 Thomasville Road Tallahassee, Florida


DESIGNED: BD

DRAWN: JH/MP

CHECKED: BD/ML

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JOB NO.: 24.121

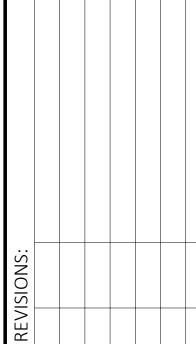

DRAWING PHASE:

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Documents

DRAWING TITLE:

First Level Floor Plan

SHEET NO.:

A1.1

DATE:

RCP Keynotes:

- SEAMLESSLY CONNECT NEW GYPSUM BOARD CEILING TO EXISTING CEILING - COORDINATE WITH MECH. & ELECTRICAL.
- 2 BULKHEADS TO BE 2" BELOW LOWEST ADJACENT CEILINGS AND PAINTED
- 3 EXISTING BULKHEADS TO REMAIN AND PAINTED PT-3.
- 4 REFER TO A1.4 FOR CUSTOM ACOUSTICAL CEILING TILE DESIGN AND
- 5 BOTTOM OF FIXTURE MOUNTED 7'-6" A.F.F.

Corr. 002C B 9' - 0" (A |9' - 0")— Multi-Purpose B 8' - 0" Furniture Storage B 9' - 0" A 9' - 0" B 9' - 0" € <u>Corr.</u> 000B [⊛] Copy Room Corr. Storage 005 (A 8' - 0") A 9' - 0" <u>Janitor</u> A 8' - 0" 019 <u>Corr.</u> 000C Women 021 B 8' - 0") Storage 018 Work Room A 8' - 0" <u>Corr.</u> 000D E 12' - 9" <u>Gym</u> 011 ⊛ Office _015__ Mech. 013 Video/Webinar 016A _<u>Viewing Room</u> **014** A 8' - 0" (A 8' - 0") (A 8' - 0")

1 Basement Level - Reflected Ceiling Plan 3/16" = 1'-0"



RCP General Notes:

1. ALL DIMENSIONS SHOWN ARE TO FACE OF FINISH SURFACE.

2. COORDINATE WITH ELECTRICAL PLAN FOR LOCATION OF FIXTURES AND SWITCHING. ANY DISCREPANCIES DISCOVERED IN THE DRAWINGS SHALL BE BROUGHT TO THE ATTENTION OF THE ARCHITECT.

3. COORDINATE WITH MECHANICAL PLAN FOR LOCATION OF DUCTWORK AND DIFFUSERS. ANY DISCREPANCIES DISCOVERED IN THE DRAWINGS SHALL BE BROUGHT TO THE ATTENTION OF THE ARCHITECT.

4. REFER TO ELECTRICAL DWGS FOR LOCATIONS OF ALL LIGHTS WITH EMERGENCY BATTERY.

5. CONTRACTOR TO CONSULT WITH ARCHITECT AFTER DEMOLITION TO CONFIRM THERE ARE NO CONFLICTS THAT WILL REQUIRE REDUCTION TO PROPOSED CEILING HEIGHTS AND TO IDENTIFY AREAS WHERE CEILING HEIGHTS CAN BE INCREASED.

Ceiling Finish Legend:

A 9' - 0"

A - ACOUSTICAL CEILING TILE

—CEILING HEIGHT B - GYPSUM BOARD CEILING CEILING FINISH


C - ARMSTRONG LYRA DROP CEILING D - ARMSTRONG DESIGNFLEX GEOMETRIC ACOUSTICAL CEILING TILE

E - EXISTING TO REMAIN

RCP Legend:




EXISTING GYPSUM BOARD TO REMAIN

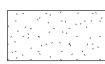


NEW GYPSUM BOARD

(CUSTOM PATTERN)

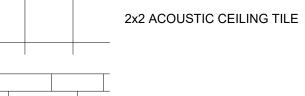

ARMSTRONG: LYRA PB TEGULAR ACOUSTICAL PANELS

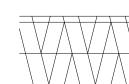


ARMSTRONG: DESIGNFLEX GEOMETRIC ACOUSTICAL CEILING TILE

Lighting & HVAC Legend:




2'x2' RECESSED LIGHT FIXTURE

6" LED RECESSED CAN LIGHT

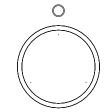

SUSPENDED LIGHT FIXTURE

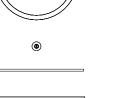

4" ROUND PENDANT LIGHT FIXTURE 1" X 4' WIDE RECESSED LIGHT

4"x4' RECESSED LINEAR LED LIGHT 4"x6' RECESSED LINEAR LED LIGHT

4"x8' RECESSED LINEAR LED LIGHT

4"x8' SLOT DIFFUSER


SUPPLY DIFFUSER




EXHAUST FAN



RETURN GRILLE

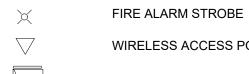


WIRELESS ACCESS POINT 10" SQUARE

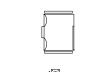


FIRE ALARM HORN / VISIBLE DEVICE

EXISTING UTILITY LIGHT TO REMAIN

CEILING MOUNTED PROJECTOR

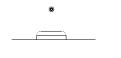

FIRE SPRINKLER EMERGENCY LIGHTS

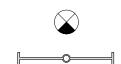

EXIT LIGHT UTILITY LIGHT



UNFACED BATTS INSULATION - 24" STRIP WHERE SHOWN ON ONE SIDE OF WALL - 48" STRIP WHERE SHOWN ON BOTH SIDES OF WALL



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FL Architecture Corporation AA26002280

SEAL:

PROJECT TITLE:

JOB NO.: 24.121 DESIGNED: BD DRAWN: JH/MP CHECKED: **BD/ML** ARE THE PROPERTY AND COPYRIGHT OF BKJ, INC. AND MAY NOT BE EPRODUCED, PUBLISHED, OR USED IN AN MANNER WITHOUT WRITTEN PERMISSION OF THE ARCHITECT

DRAWING PHASE: 100% Construction **Documents**

DRAWING TITLE:

Basement Level

SHEET NO.:

A1.2

DATE:

INSTALL OPEN CELL, LOW-DENSITY, SPRAY FOAM INSULATION (R-20) W/ INTUMESCENT COATING ON THE UNDERSIDE OF THE EXISTING ROOF DECK. BASIS OF DESIGN PRODUCT INFORMATION LISTED BELOW. REFER TO SPECIFICATIONS FOR ADDITIONAL INFORMATION.

QUIK-SHIELD 108YM

A. Manufacturer: SWD Urethane.

B. Description:

iption: 1. Compatibility:

a. Ensure components and materials are compatible with specified accessories and adjacent materials.

C. Performance Criteria:

1. Thermal Resistance (R), ASTM C518 at 180 days aged: 3.7 degrees F. ft.²; h/Btu at 1 inch thickness

and 3.6 degrees F. ft.²; h/Btu at 3.5 inch thickness, minimum.

2. Air Leakage, ASTM E283: <0.02 L/second/meter² at 3.5" thickness.

2. Alr Leakage, ASTM E283: <0.02 L/second/meter² at 3.5 thickr 3. Core Density, ASTM D1622: 0.36-0.04 lb./ft.², maximum.

4. Tensile Strength, ASTM D1623: 3.0 psi, minimum. 5. Flame Spread, ASTM E84: 25, maximum.

6. Smoke Developed, ASTM E84: 450, maximum. D. Materials:

1. Low-density, open cell, two-component, spray-applied, polyurethane system.

1. In accordance with manufacturer's recommendations.

F. Location and thickness:
1. Underside of roof sheathing: 5.5 " and R-20

DC315 INTUMESCENT COATIN


A. DC315 intumescent coating, manufactured by IFTI, Paint to Protect, is a water-based coating supplied in 5-gallon pails and 55-gallon drums. The coating material has a shelf life of 24 months when stored in factory-sealed containers at temperatures between 41 degrees

F and 95 degrees F. DC315 complies with ICC-ES AC456 as recognized in ICC-ES ESR-3702.

B. Alternate intumescent coatings.

1. FS-IB intumescent coating

2. NO-BURN Plus ThB intumescent coating.

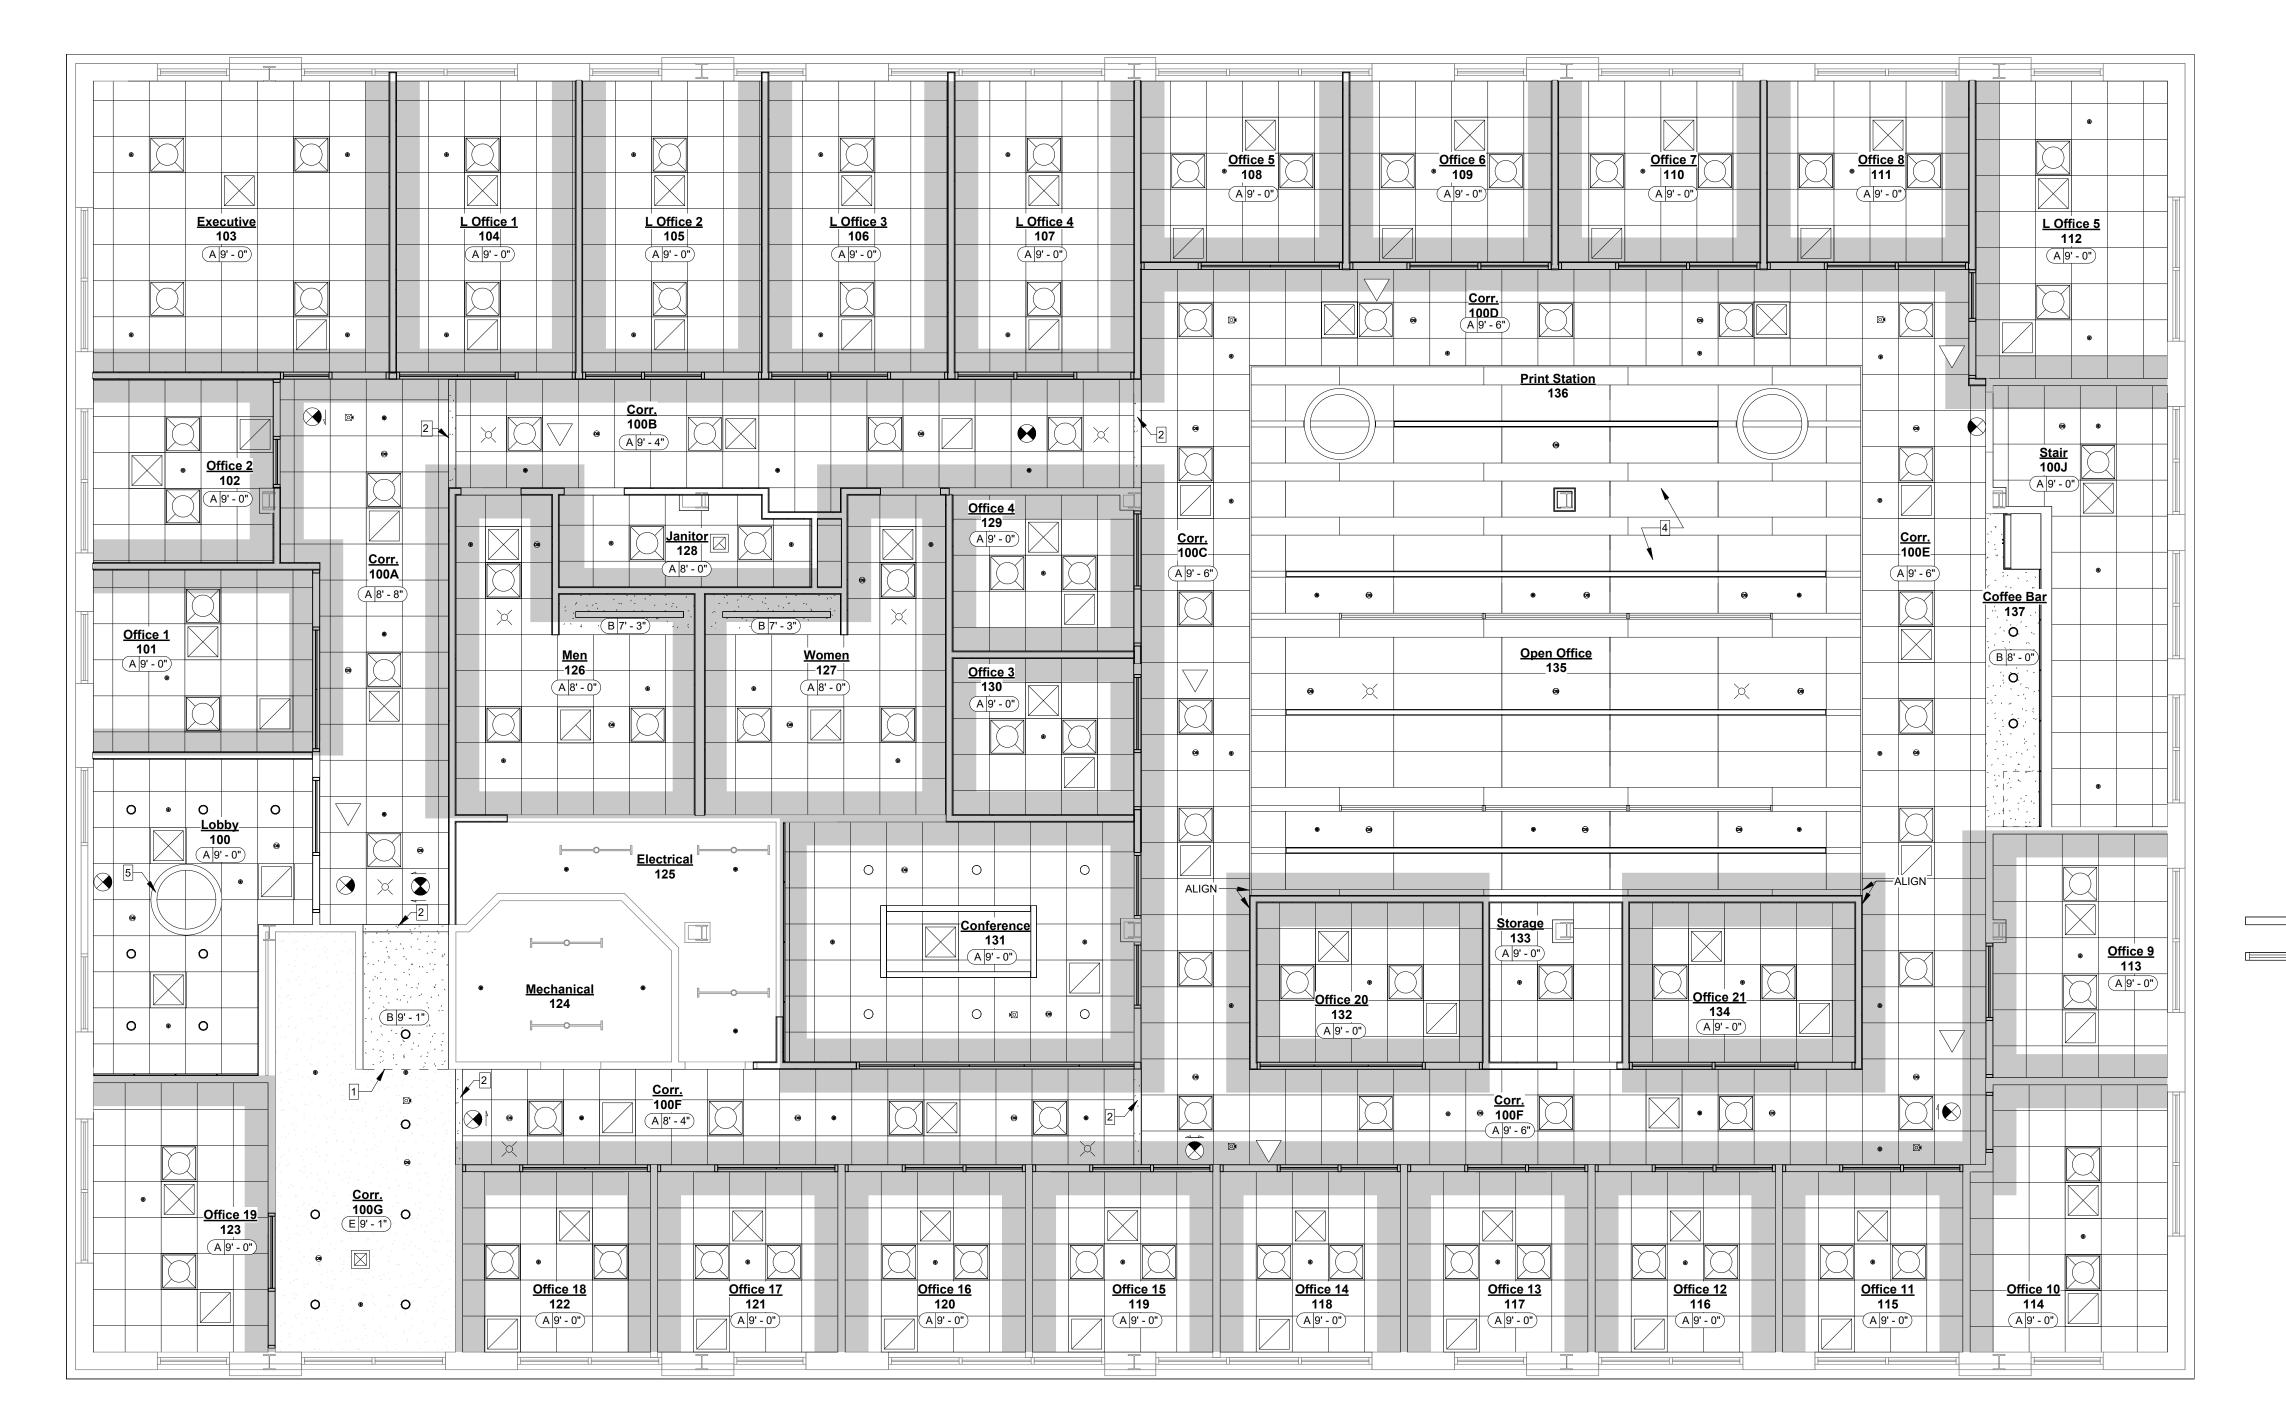

First Level - Reflected Ceiling Plan 3/16" = 1'-0"

RCP Keynotes:

1 SEAMLESSLY CONNECT NEW GYPSUM BOARD CEILING TO EXISTING CEILING - COORDINATE WITH MECH. & ELECTRICAL.

2 BULKHEADS TO BE 2" BELOW LOWEST ADJACENT CEILINGS AND PAINTED

3 EXISTING BULKHEADS TO REMAIN AND PAINTED PT-3.

REFER TO A1.4 FOR CUSTOM ACOUSTICAL CEILING TILE DESIGN AND

5 BOTTOM OF FIXTURE MOUNTED 7'-6" A.F.F.

RCP General Notes:

1. ALL DIMENSIONS SHOWN ARE TO FACE OF FINISH SURFACE.

2. COORDINATE WITH ELECTRICAL PLAN FOR LOCATION OF FIXTURES AND SWITCHING. ANY DISCREPANCIES DISCOVERED IN THE DRAWINGS SHALL BE BROUGHT TO THE ATTENTION OF THE ARCHITECT.

3. COORDINATE WITH MECHANICAL PLAN FOR LOCATION OF DUCTWORK AND DIFFUSERS. ANY DISCREPANCIES DISCOVERED IN THE DRAWINGS SHALL BE BROUGHT TO THE ATTENTION OF THE ARCHITECT.

4. REFER TO ELECTRICAL DWGS FOR LOCATIONS OF ALL LIGHTS WITH EMERGENCY BATTERY.

5. CONTRACTOR TO CONSULT WITH ARCHITECT AFTER DEMOLITION TO CONFIRM THERE ARE NO CONFLICTS THAT WILL REQUIRE REDUCTION TO PROPOSED CEILING HEIGHTS AND TO IDENTIFY AREAS WHERE CEILING HEIGHTS CAN BE INCREASED.

Ceiling Finish Legend:

A 9' - 0"

A - ACOUSTICAL CEILING TILE

-CEILING HEIGHT B - GYPSUM BOARD CEILING
-CEILING FINISH C ARMSTRONG LYBA DROP


C - ARMSTRONG LYRA DROP CEILING
D - ARMSTRONG DESIGNFLEX GEOMETRIC

ACOUSTICAL CEILING TILE
E - EXISTING TO REMAIN


RCP Legend:



EXISTING GYPSUM BOARD TO REMAIN

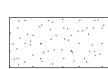


NEW GYPSUM BOARD

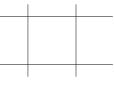

2x2 ACOUSTIC CEILING TILE



ARMSTRONG: LYRA PB TEGULAR ACOUSTICAL PANELS (CUSTOM PATTERN)

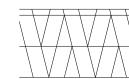

ARMSTRONG: DESIGNFLEX GEOMETRIC ACOUSTICAL CEILING TILE


Lighting & HVAC Legend:



2'x2' RECESSED LIGHT FIXTURE

SUSPENDED LIGHT FIXTURE


© 6" LED RECESSED CAN LIGHT

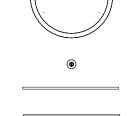

4" ROUND PENDANT LIGHT FIXTURE
1" X 4' WIDE RECESSED LIGHT


4"x4' RECESSED LINEAR LED LIGHT

4"x6' RECESSED LINEAR LED LIGHT
4"x8' RECESSED LINEAR LED LIGHT

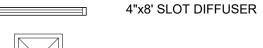


EXHAUST FAN

SUPPLY DIFFUSER

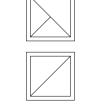



RETURN GRILLE

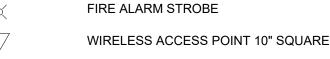




FIRE ALARM HORN / VISIBLE DEVICE

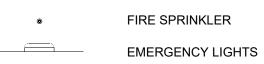

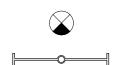

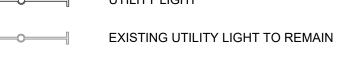

UNFACED BATTS INSULATION
- 24" STRIP WHERE SHOWN ON ONE SIDE OF WALL
- 48" STRIP WHERE SHOWN ON BOTH SIDES OF WALL



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350.778.8007 (F) 850.54 www.bkjarchitecture.co chitecture Corporation AA	m

SEAL:

PROJECT TITLE:

ICE RENOVATION
Thomasville Road
allahassee, Florida

JOB NO.: 24.121

DESIGNED: BD

DRAWN: JH/MP

CHECKED: BD/ML

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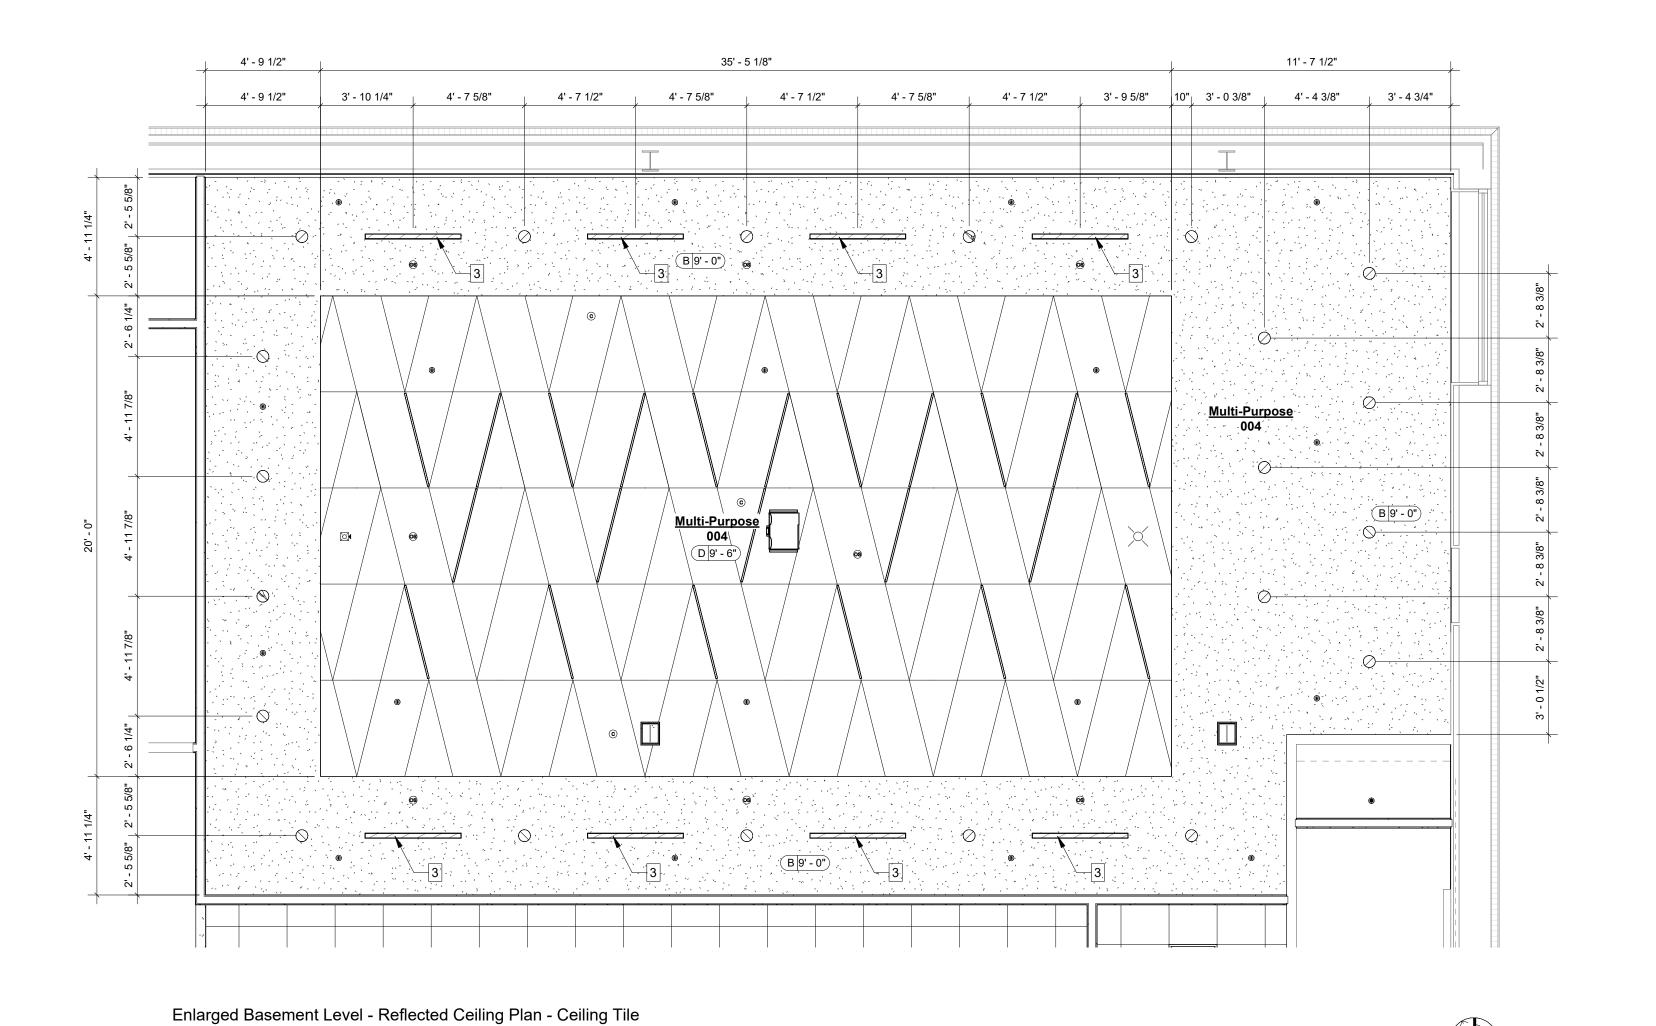
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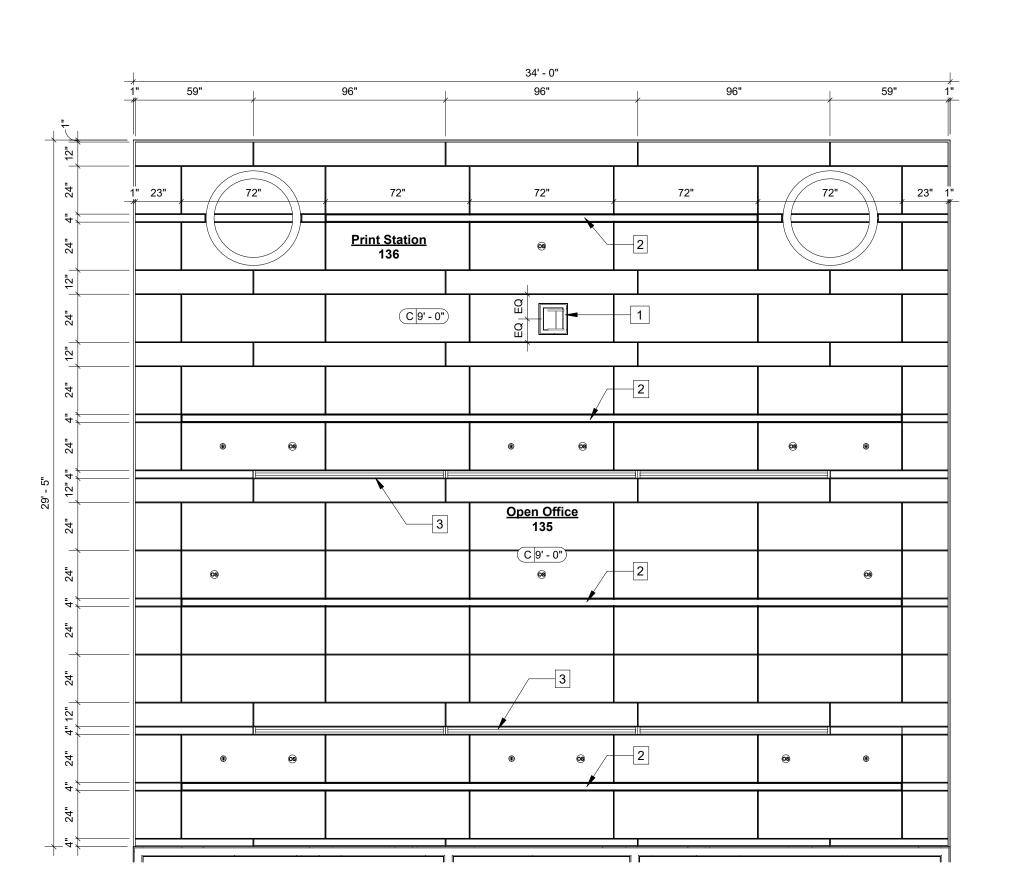
First Level RCP

SHEET NO.:

A1.3

DATE: August 18, 2025





2 Enlarged First Level - Reflected Ceiling Plan - Ceiling Tile Pattern 1/4" = 1'-0"

Pattern
1/4" = 1'-0"



RCP General Notes:

1. ALL DIMENSIONS SHOWN ARE TO FACE OF FINISH SURFACE.

2. COORDINATE WITH ELECTRICAL PLAN FOR LOCATION OF FIXTURES AND SWITCHING. ANY DISCREPANCIES DISCOVERED IN THE DRAWINGS SHALL BE BROUGHT TO THE ATTENTION OF THE ARCHITECT.

3. COORDINATE WITH MECHANICAL PLAN FOR LOCATION OF DUCTWORK AND DIFFUSERS. ANY DISCREPANCIES DISCOVERED IN THE DRAWINGS SHALL BE BROUGHT TO THE ATTENTION OF THE ARCHITECT.

4. REFER TO ELECTRICAL DWGS FOR LOCATIONS OF ALL LIGHTS WITH EMERGENCY BATTERY.

5. CONTRACTOR TO CONSULT WITH ARCHITECT AFTER DEMOLITION TO CONFIRM THERE ARE NO CONFLICTS THAT WILL REQUIRE REDUCTION TO PROPOSED CEILING HEIGHTS AND TO IDENTIFY AREAS WHERE CEILING HEIGHTS CAN BE INCREASED.

Ceiling Finish Legend:

A 9' - 0"

A - ACOUSTICAL CEILING TILE


CEILING HEIGHT B - GYPSUM BOARD CEILING CEILING FINISH

C - ARMSTRONG LYRA DROP CEILING D - ARMSTRONG DESIGNFLEX GEOMETRIC

ACOUSTICAL CEILING TILE

E - EXISTING TO REMAIN

RCP Legend:

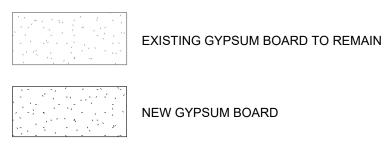





ARMSTRONG: DESIGNFLEX GEOMETRIC ACOUSTICAL CEILING TILE

Enlarged RCP Keynotes:

- COLUMN WRAP TO BE CENTERED ON WALL BELOW AND CENTERED (NORTH-TO-SOUTH) ON 2'-0" WIDE CEILING TILE ABOVE. COORDINATE WITH AOR AFTER DEMOLITION. COLUMN LOCATION MAY REQUIRE CEILING PATTERN AND NORTH WALL OF OFFICE 20 (132), STORAGE (133), AND OFFICE 21 (134) TO SHIFT NORTH SLIGHTLY TO ACCOMODATE.
- 2 LINEAR LED LIGHTS. COORDINATE WITH ELECTRICAL DWGS.
- 3 LINEAR SLOT DIFFUSERS. COORDINATE WITH MECHANICAL DWGS.



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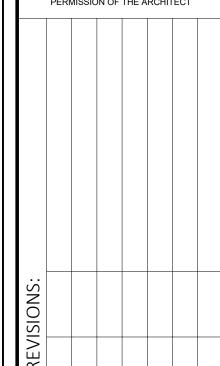
SEAL:

PROJECT TITLE:

JOB NO.: 24.121 DESIGNED: **BD**

DRAWN: JH/MP CHECKED: BD/ML

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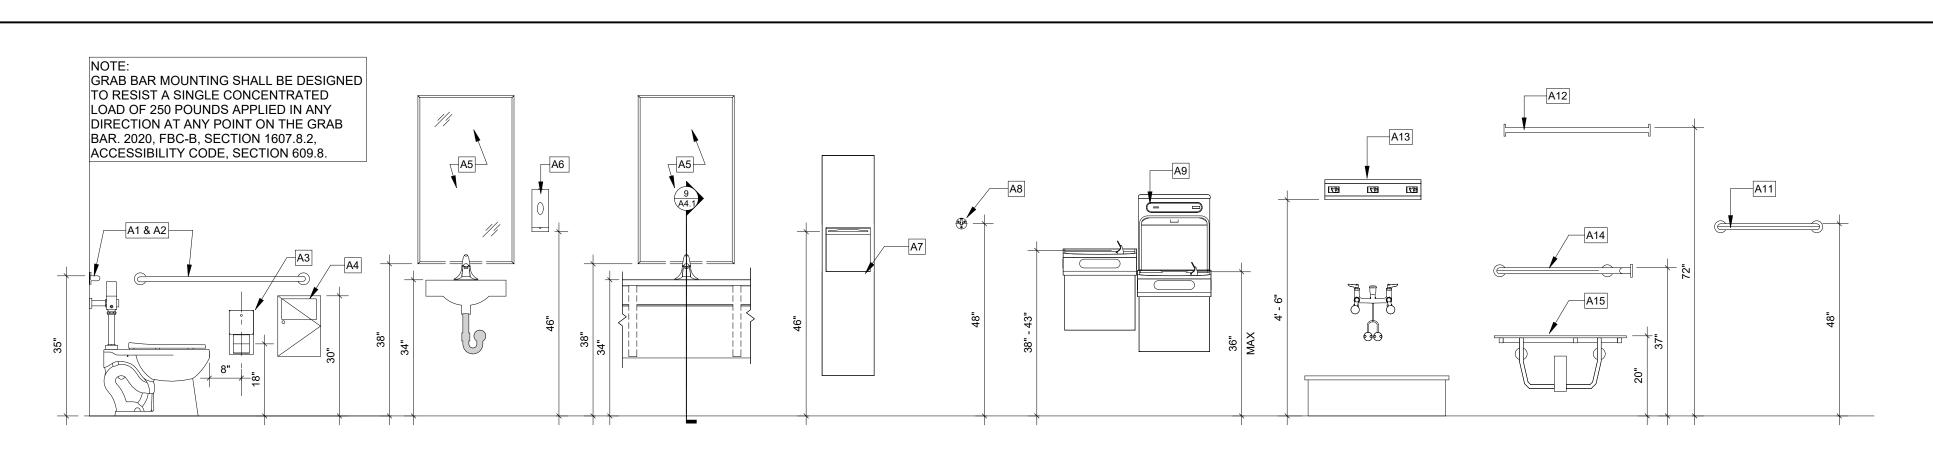
DRAWING TITLE:

Enlarged RCP

SHEET NO.:

A1.4


DATE:



Accessory Schedule:

- A1- 36" GRAB BAR 1 1/4" DIA. BOBRICK B-5806X36 A2- 42" GRAB BAR 1 1/4" DIA. BOBRICK B-5806X42
- TOILET TISSUE DISPENSER BOBRICK B-2888 SANITARY NAPKIN RECEPTACLE - BOBRICK B-254
- 24"x36" MIRROR BOBRICK B-290 2436.MBLK
- SOAP DISPENSER BOBRICK B-2111 RECESSED PAPER TOWEL & WASTE RECEPTACLE - ASI PIATTO 6467-00
- CLOTHES HOOK BOBRICK B-211
- ADA ENHANCED BOTTLE FILLER WATER COOLER ELKAY / LZSTL8WSSP A10- SOLID PLASTIC TOILET COMPARTMENTS - ASI ACCURATE PARTITION (TP1)
- A11- 24" TOWEL BAR BOBRICK, B-6747
- A12- SHOWER CURTAIN ROD BOBRICK B-207 A13- MOP AND BROOM HOLDER BOBRICK B-233 x 24
- A14- TWO-WALL GRAB BAR, 1 1/2" DIA. BOBRICK, B-6861
- A15- L-SHAPE SHOWER SEAT ASI, #8208-L


Accessory Mounting Height
1/2" = 1'-0"

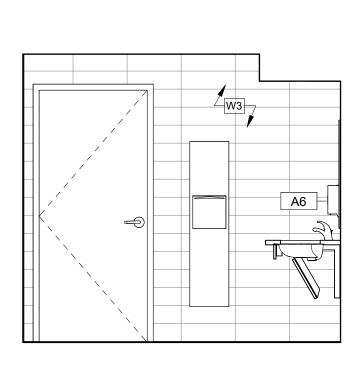

₩4 ► A5 A4 A3 A2

PROVIDE OUTSIDE CORNER WALL TRIM AT ALL OUTSIDE CORNERS FINISHED WITH WALL TILE. BASIS OF DESIGN:
SCHLUTER, QUADEC, SATIN ANODIZED ALUMINUM


1 Basement Level - Men's RR North Elevation 3/8" = 1'-0"

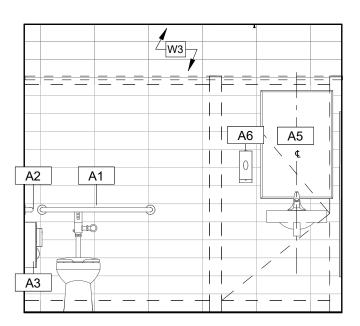

2 Basement Level - Men's RR East Elevation 3/8" = 1'-0"


RAKKS BRACKET EHV @ 30" O.C. MAX

9 A4.1

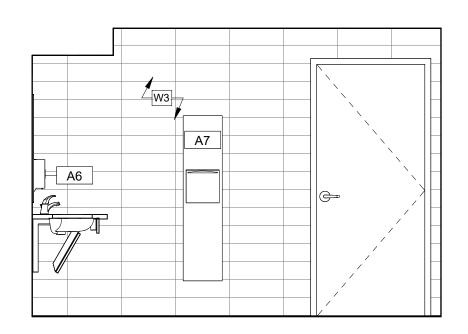


3 Basement Level - Men's RR South Elevation 3/8" = 1'-0"




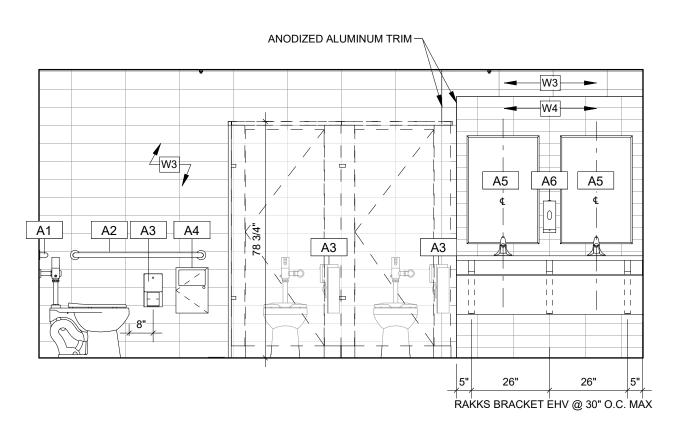

5 Basement Level - Women's RR West Elevation 3/8" = 1'-0"

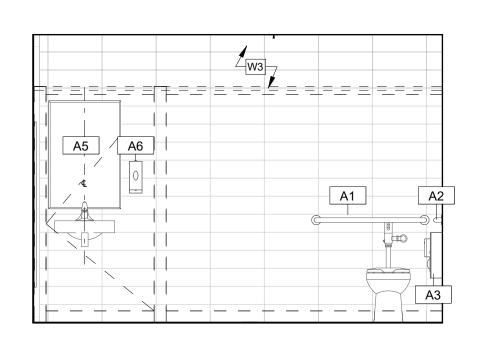

6 Basement Level - Women's RR South Elevation 3/8" = 1'-0"

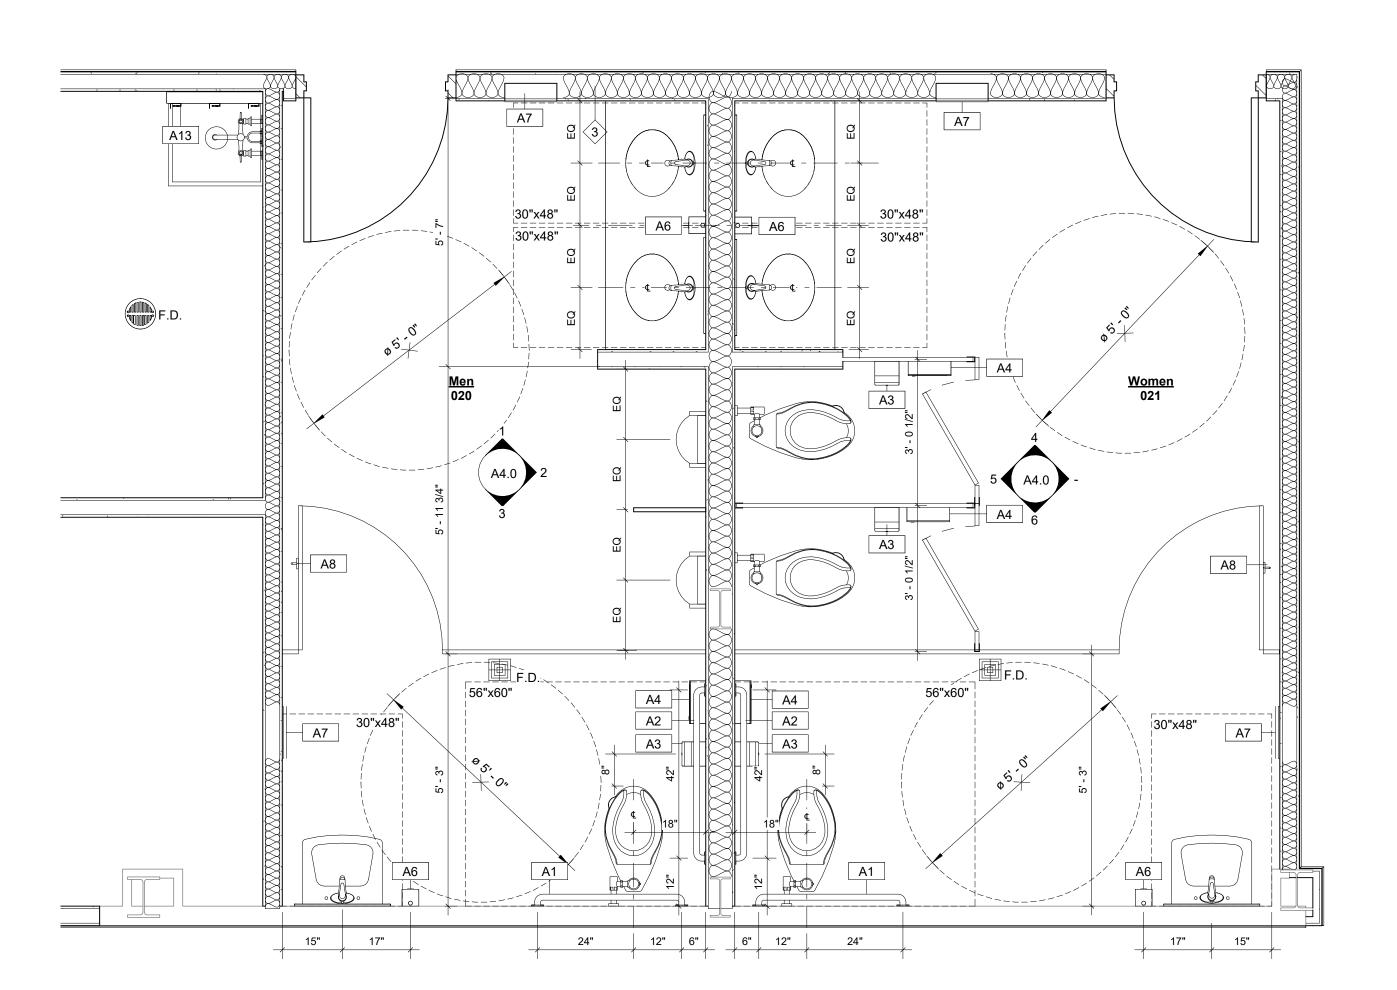

7 Basement Level - Enlarged RR Plan 1/2" = 1'-0"

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PROJECT TITLE:


FAIA

RENOV

JOB NO.: 24.121 DESIGNED: BD

DRAWN: MP CHECKED: BD/ML

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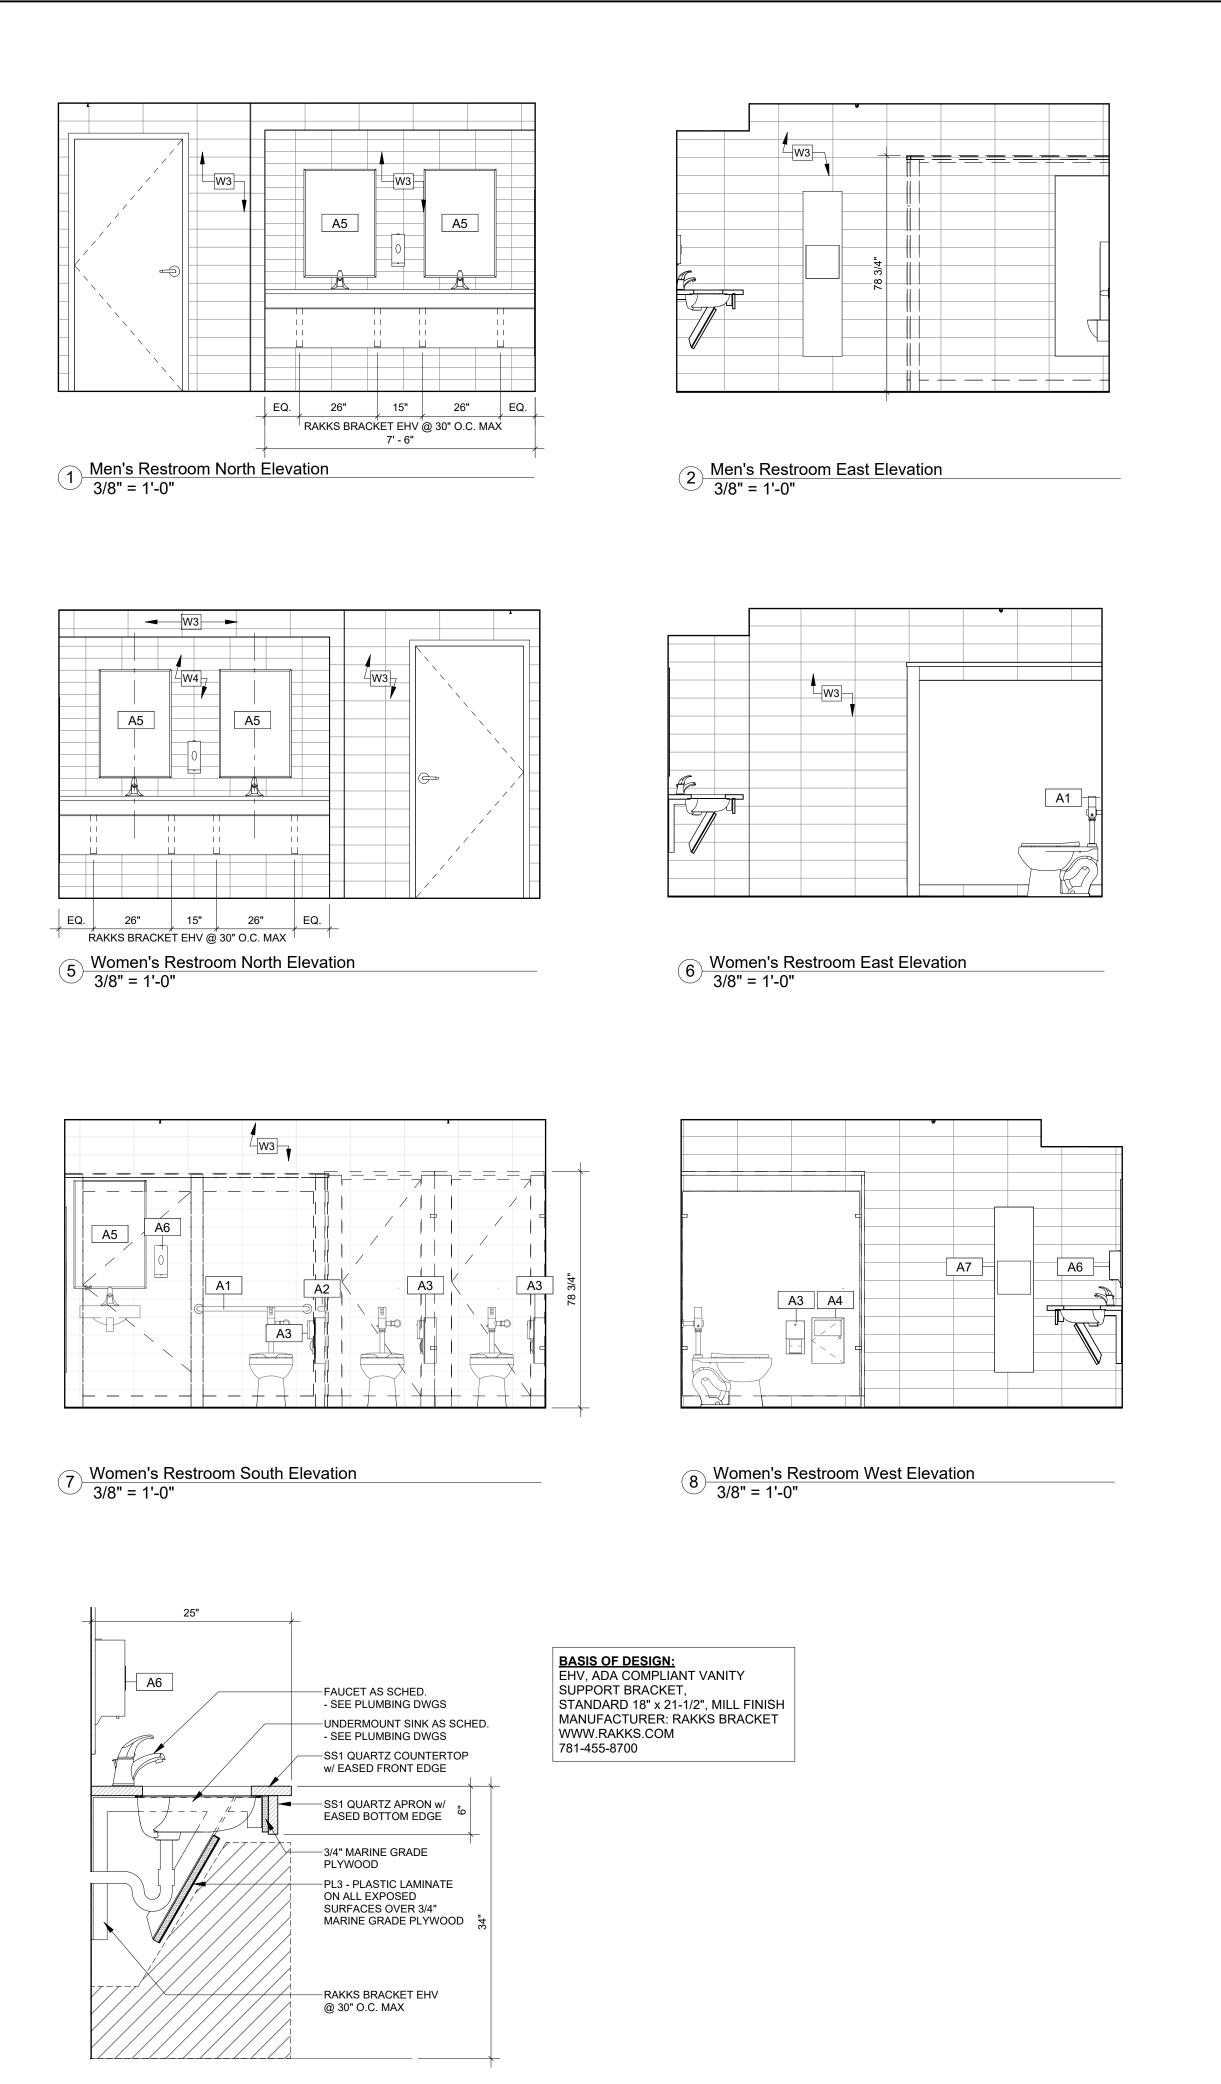
DRAWING TITLE:

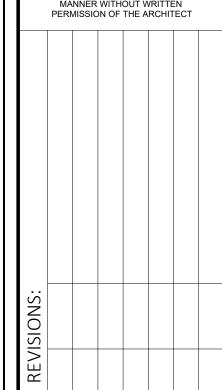Enlarged Restroom Plans, Elevations & Accessories


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DATE:




9 Typical Countertop Detail 1" = 1'-0"



Men's Restroom South Elevation
3/8" = 1'-0"

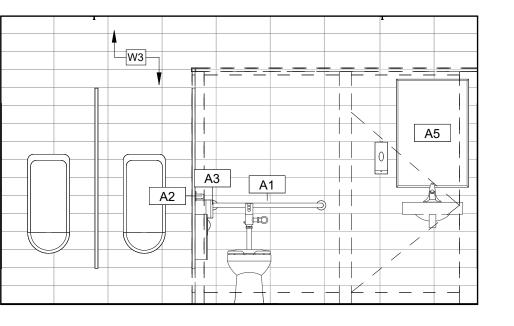PROVIDE OUTSIDE CORNER WALL TRIM AT ALL OUTSIDE CORNERS FINISHED WITH WALL TILE.

BASIS OF DESIGN: SCHLUTER, QUADEC, SATIN ANODIZED ALUMINUM

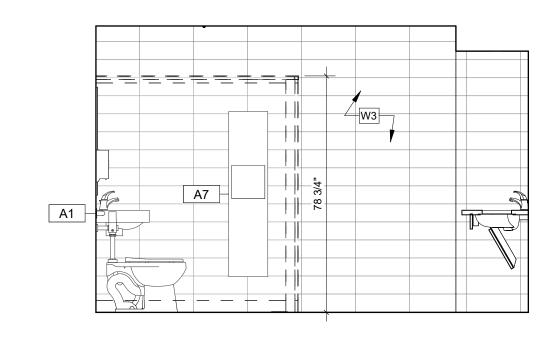

Men's Restroom West Elevation
3/8" = 1'-0"

11' - 7 3/4"

1' - 8"

Accessory Schedule:

- A1- 36" GRAB BAR 1 1/4" DIA. BOBRICK B-5806X36
- 42" GRAB BAR 1 1/4" DIA. BOBRICK B-5806X42

24"x36" MIRROR - BOBRICK B-290 2436.MBLK

- TOILET TISSUE DISPENSER BOBRICK B-2888
- SANITARY NAPKIN RECEPTACLE BOBRICK B-254
- SOAP DISPENSER BOBRICK B-2111 RECESSED PAPER TOWEL & WASTE RECEPTACLE - ASI PIATTO 6467-00
- CLOTHES HOOK BOBRICK B-211
- ADA ENHANCED BOTTLE FILLER WATER COOLER ELKAY / LZSTL8WSSP
- A10- SOLID PLASTIC TOILET COMPARTMENTS ASI ACCURATE PARTITION (TP1)
- A11- 24" TOWEL BAR BOBRICK, B-6747 A12- SHOWER CURTAIN ROD - BOBRICK B-207
- A13- MOP AND BROOM HOLDER BOBRICK B-233 x 24
- A14- TWO-WALL GRAB BAR, 1 1/2" DIA. BOBRICK, B-6861
- A15- L-SHAPE SHOWER SEAT ASI, #8208-L

30"x48"

1' - 11 1/4"

FD

A4

└ A8

3' - 0 1/2"

<u>Women</u> 127

A8

A7

56"x60

2' - 5 1/4"

1' - 8"

¹30"x48 ⁻⁻

3' - 0 1/2"



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DRAWING TITLE:

Enlarged Restroom Plans, Elevations & Accessories

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DATE:

August 18, 2025


First Level - Enlarged RR Plan
1/2" = 1'-0"

A8

A7

A4.1

PROVIDE OUTSIDE CORNER WALL TRIM AT ALL OUTSIDE CORNERS FINISHED WITH WALL TILE. BASIS OF DESIGN:
SCHLUTER, QUADEC, SATIN ANODIZED ALUMINUM

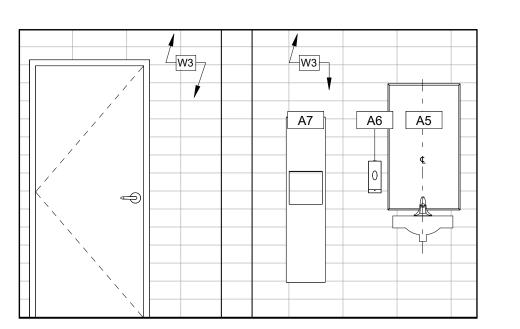



լ 6" լ 12"

_____A3

A5 ADA


18"

A4 56"x60" 56"x60" 5

16"

5 Basement Level - Enlarged Shower Plan 1/2" = 1'-0"

F.D.

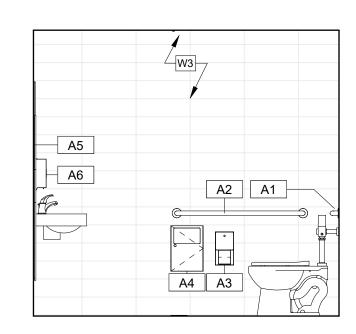

2 Shower West Elevation 3/8" = 1'-0"


30"x48"

30"x48"

A14

Shower 012

A11

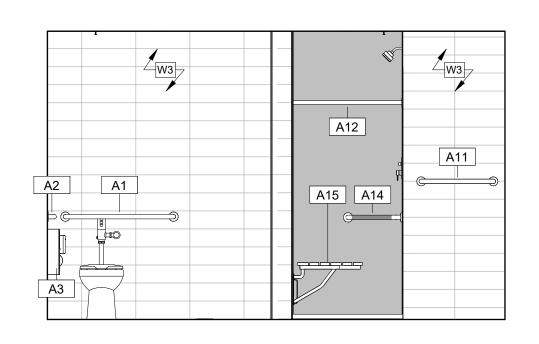

3 Shower North Elevation 3/8" = 1'-0"

NOTE: -ROUGH-IN DIMENSIONS ARE PROVIDED FOR

3' - 2" STUD R.O.

36" CLEAR

TYPICAL SHOWER PAN BASED ON ROUGH OPENING OF 38" X 37".

FIELD VERIFY ACTUAL ROUGH OPENING PRIOR TO FABRICATION.


6 Basement Level - Enlarged ADA Shower Pan 1" = 1'-0"


2 1/2" MAX

15"-16"

NOMINAL SIZE - 38" X 37" ACTUAL SIZE - 37 3/4" X 36 7/8"

REFERENCE ONLY. -MEASURE ROUGH OPENING FROM FACE OF STUD TO VERIFY SHOWER PAN

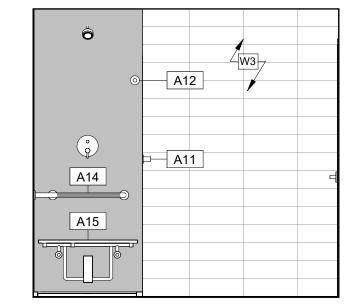

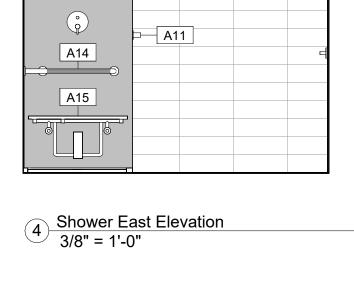



- A1- 36" GRAB BAR 1 1/4" DIA. BOBRICK B-5806X36
- 42" GRAB BAR 1 1/4" DIA. BOBRICK B-5806X42
- TOILET TISSUE DISPENSER BOBRICK B-2888 SANITARY NAPKIN RECEPTACLE - BOBRICK B-254

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- 24"x36" MIRROR BOBRICK B-290 2436.MBLK
- RECESSED PAPER TOWEL & WASTE RECEPTACLE ASI PIATTO 6467-00
- CLOTHES HOOK BOBRICK B-211
- ADA ENHANCED BOTTLE FILLER WATER COOLER ELKAY / LZSTL8WSSP A10- SOLID PLASTIC TOILET COMPARTMENTS - ASI ACCURATE PARTITION (TP1)

2' - 9 7/8"

FIN. FLR.

Typical Blocking Diagram
1" = 1'-0"

- A11- 24" TOWEL BAR BOBRICK, B-6747
- A12- SHOWER CURTAIN ROD BOBRICK B-207
- A13- MOP AND BROOM HOLDER BOBRICK B-233 x 24
- A14- TWO-WALL GRAB BAR, 1 1/2" DIA. BOBRICK, B-6861

A15- L-SHAPE SHOWER SEAT - ASI, #8208-L




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GRAB BAR BLOCKING

-ADA SEAT BLOCKING

DRAWING TITLE:

Enlarged Restroom Plans, Elevations & Accessories


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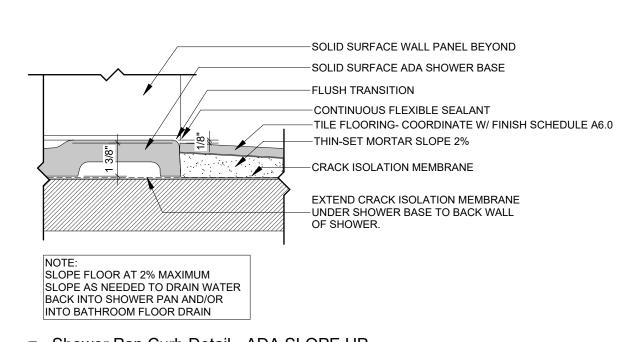
DATE: August 18, 2025

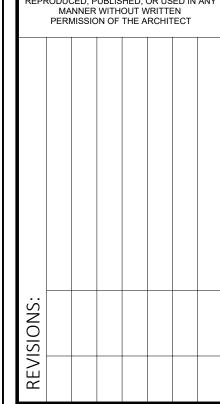
DIMENSIONS AND DRAIN LOCATION. NEW SHOWER DRAIN. REFER TO PLUMBING DRAWINGS FOR ADDITIONAL INFORMATION -NEW SOLID SURFACE SHOWER BASE INSTALL SHOWER BASE OVER CRACK ISOLATION MEMBRANE WITH
SEALANT/ADHESIVE AS RECOMMENDED BY MANUFACTURER. -EXISTING CONCRETE SLAB. NEW DRAIN LINE - REFER TO PLUMBING DRAWINGS FOR ADDITIONAL INFORMATION 22"-23"


7 Shower Drain Detail 3" = 1'-0"





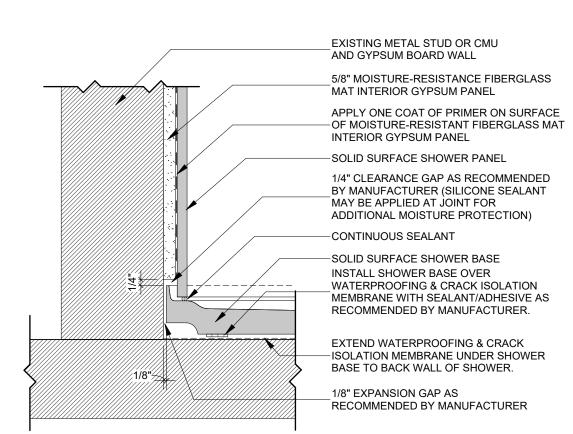

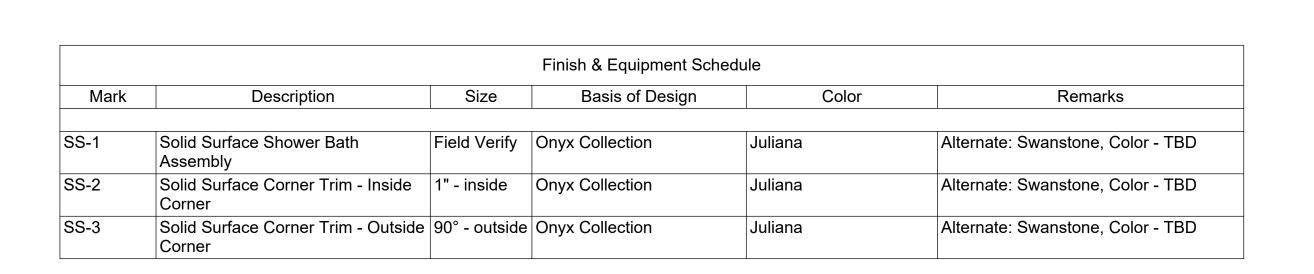

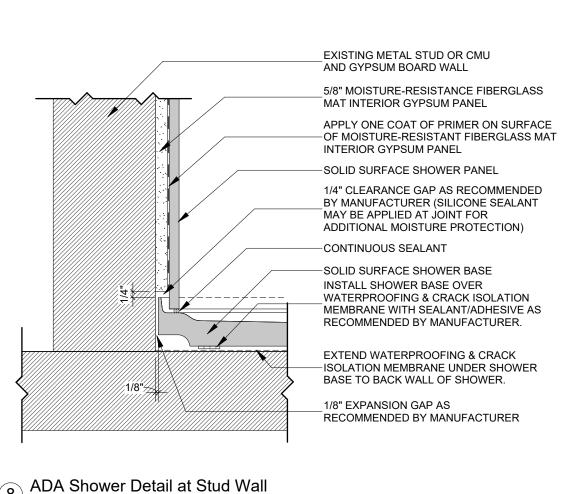

9 Shower Pan Curb Detail - ADA SLOPE UP 3" = 1'-0"

			Fi	nish Schedule - E	Basement Level				
Number	Name	Base Finish	Floor Finish	North Wall	East Wall	South Wall	West Wall	Ceiling Finish	Ceiling Height Notes
000A	Corr.	RB1	CT1	W1	W5	W1	W1	ACT1	8'-0"
000B	Corr.	RB1	CT1	W1	W1	W5	W1	ACT1	8'-0"
000C	Corr.	RB1	CT1	W1	W1	W1	W5	ACT1	8'-0"
000D	Corr.	RB1	CT1	W5	W1	W1	W1	ACT1	8'-0"
000E	Corr.	RB1	CT1	W1	W1	W1	W1	ACT1	9'-0"
000F	Corr.	RB1	CT1	W1	W1	W1	W1	ACT1	8'-0"
000G	Stair	RB1	CT2	W1	W1	W1	W1	ACT1	8'-0" / Varies
000H	Stair	RB1	CT2	W1	W1	W1	W1	ACT1	8'-0" / Varies
001	Copy Room	RB1	LVT1	W1	W1	W1	W1	ACT1	8'-0"
002A	Break	RB1	LVT1	W5	W1	W1	W1	ACT1	9'-6"
002B	Break	RB1	LVT1	W5	W1	W1	W1	ACT1	9'-6"
002C	Corr.	RB1	LVT1	W1	W1	W1	W1	ACT1	9'-6"
003	Furniture Storage	RB1	SC	W1	W1	W1	W1	ACT2	9'-0"
004	Multi-Purpose	RB1	CT1	W5	W1	W1	W1	ACT3 / GB1	9'-0"/9'-6"
004A	Riser Room	RB1	SC	W1	W1	W1	W1	GB1	Varies
005	Storage	RB1	SC	W1	W1	W1	W1	ACT1	9'-0"
006	Elec.	EX	EX	EX	EX	EX	EX	EX	EX
007	Work Room	RB1	CT1	W1	W1	W1	W1	ACT1	8'-0"
800	Office	RB1	CT1	W1	W1	W5	W1	ACT1	8'-0"
009	Office	RB1	CT1	W1	W1	W5	W1	ACT1	8'-0"
010	Office	RB1	CT1	W1	W1	W5	W1	ACT1	8'-0"
011	Gym	RB1	RF1	W1	W1	W5	W1	ACT1	8'-0"
012	Shower	-	PFT1	W3	W3	W3	W3	GB1	8'-0"
013	Mech.	RB1	SC	W1	W1	W1	W1	ACT1	8'-0"
014	Viewing Room	RB1	CT1	W1	W1	W5	W1	ACT1	8'-0"
015	Office	RB1	CT1	W1	W1	W1	W1	ACT1	8'-0"
016A	Video/Webinar	RB1	CT1	W1	W1	W5	W1	ACT1	8'-0"
017	Storage	RB1	SC	W1	W1	W1	W1	ACT1	8'-0"
018	Storage	RB1	SC	W1	W1	W1	W1	ACT1	8'-0"
019	Janitor	RB1	SC	W1	W1	W1	W1	ACT1	8'-0"
020	Men	-	PFT1	W3	W3 / W4	W3	W3	ACT1	8'-0"
021	Women	-	PFT1	W3	W3	W3	W3/W4	ACT1	8'-0"

				Finish Schedu	ule - First Level					
Number	Name	Base Finish	Floor Finish	North Wall	East Wall	South Wall	West Wall	Ceiling Finish	Ceiling Height	Notes
100	Lobby	RB1	CT1 / PFT1	W1	W1	W1	W1	ACT1	9'-0"	
100A	Corr.	RB1	CT1	W1	W1	W1	W1	ACT1	8'-8"	
100B	Corr.	RB1	CT1	W1	W1	W1	W1	ACT1	9'-4"	
100C	Corr.	RB1	CT1	W1	W5	W1	W1	ACT1	9'-6"	
100D	Corr.	RB1	CT1	W1	W1	W1	W1	ACT1	9'-6"	
100E	Corr.	RB1	CT1	W1	W1	W1	W5	ACT1	9'-6"	
100F	Corr.	RB1	CT1	W1 / W5	W1	W1	W1	ACT1	9'-4"/9'-6"	
100G	Corr.	RB1	CT1	W1	W1	W5	W1	GB1	9'-1"	
100H	Stair	RB1	CT1	W1	W1	W1	W1	GB1	9'-1"	
100J	Stair	RB1	CT2	W1	W1	W1	W1	ACT1	9'-1"	
101	Office 1	RB1	CT1	W1	W1	W5	W1	ACT1	9'-0"	
102	Office 2	RB1	CT1	W1	W1	W5	W1	ACT1	9'-0"	
103	Executive	RB1	CT1	W5	W1	W1	W1	ACT1	9'-0"	
104	L Office 1	RB1	CT1	W5	W1	W1	W1	ACT1	9'-0"	
105	L Office 2	RB1	CT1	W5	W1	W1	W1	ACT1	9'-0"	
106	L Office 3	RB1	CT1	W5	W1	W1	W1	ACT1	9'-0"	
107	L Office 4	RB1	CT1	W5	W1	W1	W1	ACT1	9'-0"	
108	Office 5	RB1	CT1	W5	W1	W1	W1	ACT1	9'-0"	
109	Office 6	RB1	CT1	W5	W1	W1	W1	ACT1	9'-0"	
110	Office 7	RB1	CT1	W5	W1	W1	W1	ACT1	9'-0"	
111	Office 8	RB1	CT1	W5	W1	W1	W1	ACT1	9'-0"	
112	L Office 5	RB1	CT1	W5	W1	W1	W1	ACT1	9'-0"	
113	Office 9	RB1	CT1	W5	W1	W1	W1	ACT1	9'-0"	
114	Office 10	RB1	CT1	W1	W1	W5	W1	ACT1	9'-0"	
115	Office 11	RB1	CT1	W1	W1	W5	W1	ACT1	9'-0"	
116	Office 12	RB1	CT1	W1	W1	W5	W1	ACT1	9'-0"	
117	Office 13	RB1	CT1	W1	W1	W5	W1	ACT1	9'-0"	
118	Office 14	RB1	CT1	W1	W1	W5	W1	ACT1	9'-0"	
119	Office 15	RB1	CT1	W1	W1	W5	W1	ACT1	9'-0"	
120	Office 16	RB1	CT1	W1	W1	W5	W1	ACT1	9'-0"	
121	Office 17	RB1	CT1	W1	W1	W5	W1	ACT1	9'-0"	
122	Office 18	RB1	CT1	W1	W1	W5	W1	ACT1	9'-0"	
123	Office 19	RB1	CT1	W1	W1	W5	W1	ACT1	9'-0"	
124	Mechanical	EX	EX	EX	EX	EX	EX	EX	EX	
125	Electrical	EX	EX	EX	EX	EX	EX	EX	EX	
126	Men	LX	PFT1	W3 / W4	W3	W3	W3	ACT1	8'-0"	
127	Women		PFT1	W3 / W4	W3	W3	W3	ACT1	8'-0"	
128	Janitor	RB1	SC	W1	W1	W1	W1	ACT1	8'-0"	
129	Office 4	RB1	CT1	W1	W1	W1	W1	ACT1	9'-0"	
130	Office 3	RB1	CT1	W1	W1	W1	W1	ACT1	9'-0"	
131	Conference	RB1	CT1	W1	W1	W1	PL1	ACT1	9'-0"	
132	Office 20	RB1	CT1	W1	W1	W1	W1	ACT1	9'-0"	
133		RB1	CT1	W1	W1	W1	W1	ACT1	9'-0"	
134	Storage Office 21	RB1	CT1	W1	W1	W1	W1	ACT1	9'-0"	
134 135		RB1	CT1	W1	VVI	W5	VVI	ACT1	9'-0"	
	Open Office			W1	10/1	W1	- W1		9'-0"	
136 137	Print Station Coffee Bar	RB1 RB1	PFT1	W1	W1 PL1	W1	VVI	ACT2 GB1	8'-0"	

			Equipment Sch	nedule			
No.	Name	Manufacturer	Model	Finish	Owner Provided / Installed	Owner Provided / GC Installed	GC Provided / Installed
EQ-1	Under Counter Refrigerator	Summit Appliance	AL54CSS	Stainless Steel			•
EQ-2	Refrigerator	Bosch	B36CT80SNS	Stainless Steel			•
EQ-3	Microwave - Built-In	Bosch	HMB30155UC	Stainless Steel			•
EQ-4	Oven - Wall	Bosch	HBL5455LUC	Stainless Steel			•
EQ-5	30" Hood	Accurex	XRRS	Stainless Steel			•
EQ-6	Cooktop	Bosch	NET8069UC	Stainless Steel			•
EQ-7	Dishwasher	Bosch	SGE53C55UC	Stainless Steel			•
EQ-8	Coffee Maker - Break Room	TBD	TBD	TBD		•	
EQ-9	Coffee Maker - Coffee Bar	TBD	TBD	TBD		•	
EQ-10	Copier - Copy Room	TBD	TBD	TBD		•	
EQ-11	Copier - Printer Room	TBD	TBD	TBD		•	
EQ-12	65" T.V. Monitor	TBD	TBD	TBD		•	
EQ-13	42" T.V. Monitor	TBD	TBD	TBD		•	

Interior Finish Schedule Legend:

Floors:
CT1 - CARPET TILE: SHAW CONTRACT, HAND DRAWN, LINEWEIGHT TILE 18X36 (5T114), GRAPHITE (13510) CT2 - BROADLOOM CARPET: SHAW CONTRACT, HAND DRAWN, CONTE (5A213), GRAPHITE (13510)

PFT1 - PORCELAIN TILE: DALTILE, MARBLE ATTACHE LAVISH, DIAMOND CARRAR MA70, SATIN OR POLISHED FINISH, 24X24, GROUT: TBD LVT1 - LVT: SHAW CONTRACT, EMERGE (0618V), TALC PLATINUM (18535), 24X24

RF1 - RUBBER FLOORING: THOR PERFORMACE ROLLED RUBBER FLOORING, 9MM, COLOR: TPR 1 (ALPHA)

SC - SEALED CONCRETE

Wall Base: RB1- RUBBER BASE: TARKETT JOHNSONITE MILLWORK REVEAL, 4.25" REVEAL MW-XX-F, COLOR: TB1 PEPPERCORN

RB1 (ALT) - RUBBER BASE: SHAW SCULPTED WALL BASE, 150VS, COLOR: FLINT 00790 TB1 - PORCELAIN TILE BASE: DALTILE, MARBLE ATTACHE LAVISH, DIAMOND CARRAR MA70, SATIN OR POLISHED FINISH, FLOOR BULLNOSE S43F9, 3X24

Walls: W1 - GYPSUM BOARD: PAINTED PT1

W2 - ACCENT PANELS: PL1

W3 - PORCELAIN TILE: DALTILE, ANNAPOLIS REMIX, SAIL AP06, GLOSSY, 6X18, GROUT: TBD

W4 - PORCELAIN TILE: DALTILE, MYTHOLOGY, TITAN RECTANGLE UNDULATED, MY96, GLOSSY, 4X12, GROUT: TBD

W5 - GYPSUM BOARD: PAINTED PT2

Ceiling:

ACT1 – ACOUSTICAL CEILING TILE: ARMSTRONG, OPTIMA TEGULAR, 24X24, ITEM 3251M WHITE, W/ 9/16 GRID

ACT2 - ACOUSTICAL CEILING TILE: ARMSTRONG, LYRA PB TEGULAR ACOUSTICAL PANELS (CUSTOM PATTERN), 9/16 SUPRAFINE CEILING GRID, 6" AXIUM CLASSIC STRAIGHT PERIMETER TRIM, WHITE ACT3 - ACOUSTICAL CEILING TILE: ARMSTRONG DESIGN FLEX GEOMETRIC ACOUSTICAL CEILING TILES, WHITE GB1 - GYPSUM BOARD: PAINTED, PT3

<u>Doors:</u> D1 - DOOR FRAMES: PAINT PT2

D2 - DOORS: SOLID CORE DOORS WITH PLASTIC LAMINATE (PL1) FACES

<u>Toilet Partition:</u> **TP1** – ASI ACCURATE PARTITIONS, ALPACO CLASSIC COLLECTION, BURNT STRAND (5107)

Paint:
PT1 – FIELD COLOR: SHERWIN WILLIAMS, EIDER WHITE SW7014

PT2 – ACCENT COLOR: SHERWIN WILLIAMS, GALE FORCE SW7605

PT3 – CEILING: SHERWIN WILLIAMS, CEILING BRIGHT WHITE SW 7007 PT4 – DOOR FRAMES & WINDOW SILLS: SHERWIN WILLIAMS, BLACK FOX SW7020

<u>Solid Surface:</u> SS1 - WILSONART, QUARTZ, COLOR: MADEIRA BEACH Q4054

Storefront: FA - FACTORY FINISH, DARK BRONZE

PL1 – CABINETS/WALLS/DOORS: WILSONART, MONTANA WALNUT 7110K-78 PL2 - COUNTERTOP: WILSONART, MUSHROOM 5013K-19, LENO WEAVE FINISH PL3 - SINK SHROUD: WILSONART, BATTLESHIP 5014K-19, LENO WEAVE FINISH

Flooring Transition Strip: FTS1 - TARKETT METAL EDGE TRIOS, MET02

Specialty Light Fixtures: LF1 – LUMOS, ZEBRAWOOD/WG-04

Roller Shade:
RS1 - DRAPER FLEX SHADE, 3% PHIFFER SHEARWEAVE, POV WHITE PLATINUM, W/ FASCIA COVER SURFACE

<u>General:</u> EX - EXISTING TO REMAIN

Interior Finish Schedule Notes:

EPOXY PAINT

2. SEE REFLECTED CEILING PLAN

3. TILE BACKER BOARD SHALL BE USED AT WALL LOCATIONS TO RECEIVE TILE FINISH.



1621 Physicians Dr. Tallahassee, Florida 32308 (P) 850.778.8007 | (F) 850.546.6150 www.bkjarchitecture.com
FL Architecture Corporation AA26002280

SEAL:

PROJECT TITLE:

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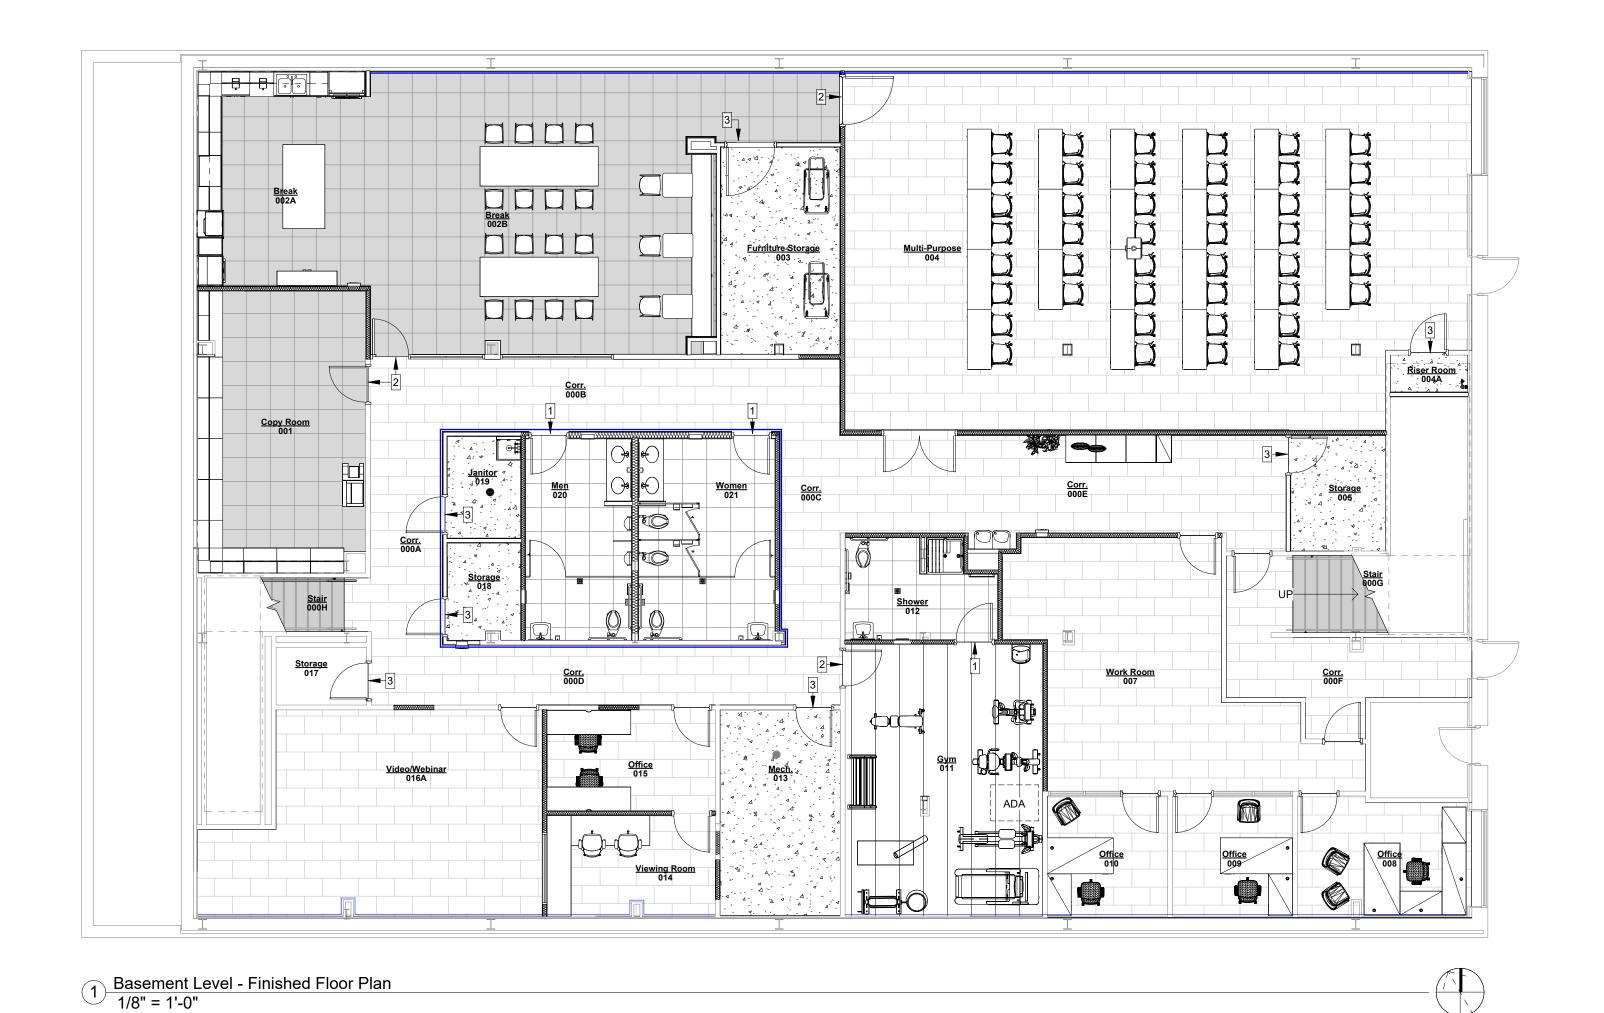
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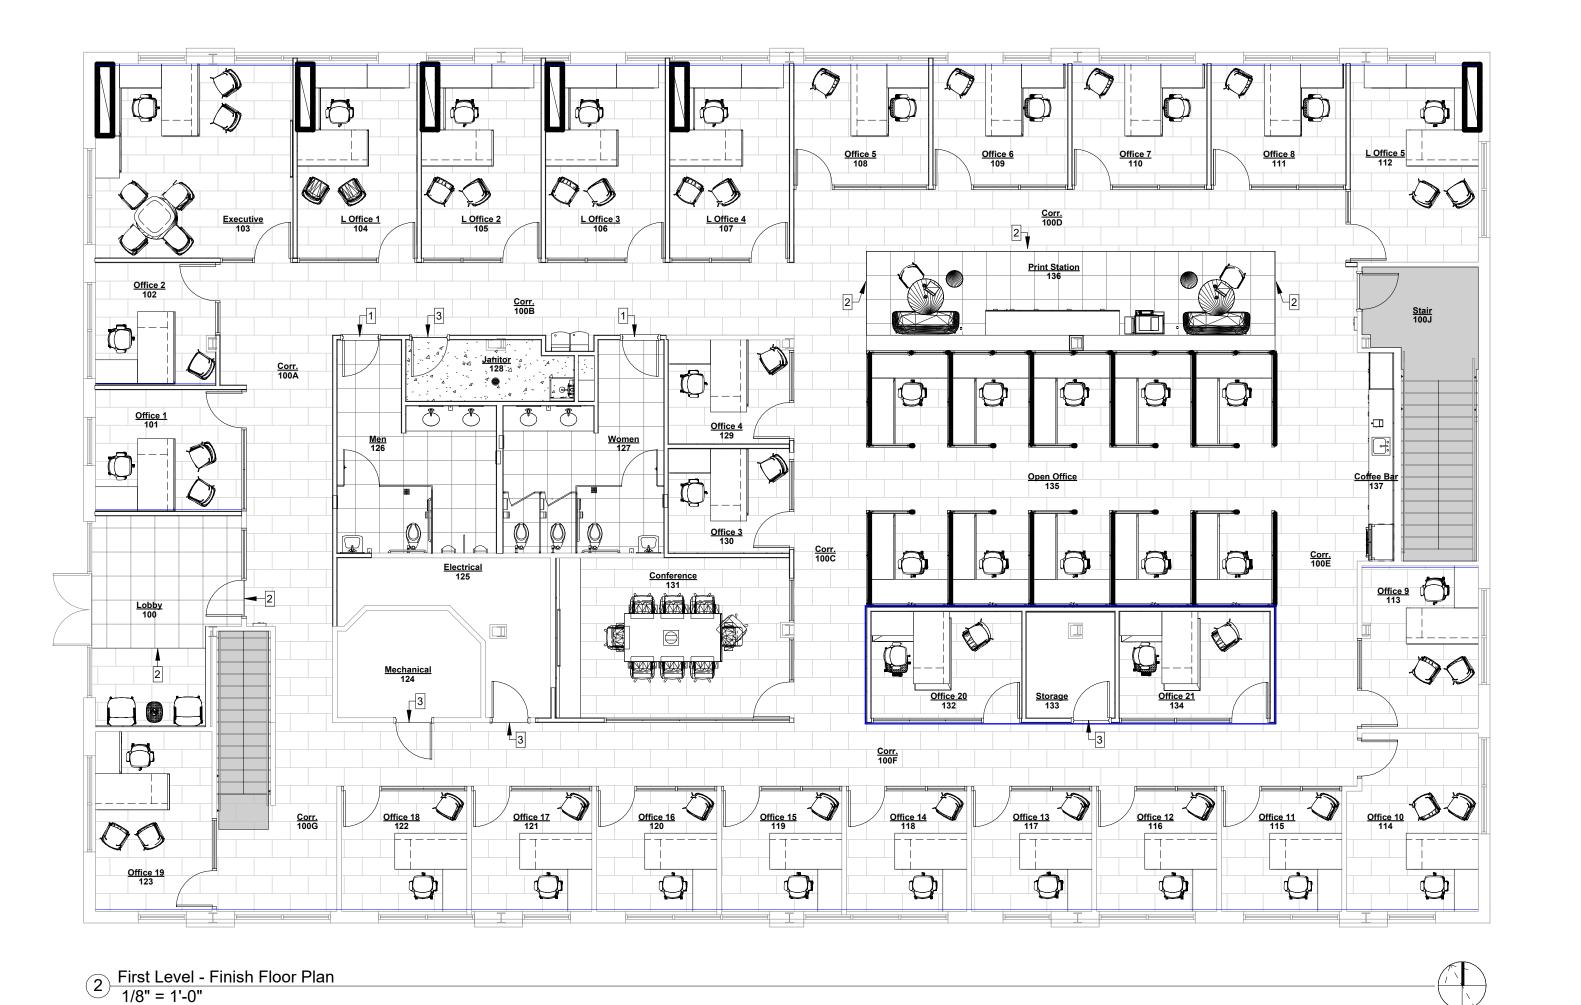
Finish Schedules

A6.0

SHEET NO.:

DATE:





Finish Plan Legend:

CT1 - 18" x 36" CARPET

PFT1 - 24" x 24" PORCELAIN TILE

RF1 - 4' x 50' RUBBER FLOORING

SC - SEALED CONCRETE

EX - EXISTING FLOORING TO REMAIN

CT2 - BROADLOOM CARPET

ACCENT WALL PAINT - PT2

LVT1 - 24" x 24" LUXURY VINYL FLOORING

Finish Plan Keynotes:

1 MARBLE THRESHOLD

2 RUBBER THRESHOLD / TRANSITION (FTS1)

3 FLOORING REDUCER

OWNER TO PROVIDE FINAL APPROVAL OF THE LOCATION OF ALL ACCENT WALLS.

ARCHITECTURE

BKJ, Inc., Architecture

BKJ, Inc., Architecture
1621 Physicians Dr.
Tallahassee, Florida 32308
(P) 850.778.8007 | (F) 850.546.6150
www.bkjarchitecture.com
FL Architecture Corporation AA26002280

SEAL:

PROJECT TITLE:

FICE RENOVATION
1117 Thomasville Road
Tallahassee, Florida

JOB NO.: 24.121

DESIGNED: BD

DRAWN: JH/MP

CHECKED: BD

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Finish Floor Plans

SHEET NO.:

DATE:

A6.1

							Frame				Frame	Frame	Hardware	
Number	Elevation	Width	Height	Thickness	Material	Finish	Elevation	Head	Jamb	Thr.	Material	Finish	Set	Notes
000G	В	3' - 0"	7' - 0"	1 3/4"	WD	PL	EX	EX	EX	24/A6.2	НМ	PT	HW-4	2
001	В	3' - 0"	7' - 0"	1 3/4"	WD	PL	EX	EX	EX	25/A6.2	НМ	PT	HW-1	2
002	В	3' - 0"	7' - 0"	1 3/4"	WD	PL	SF14	5/A6.2	9,10/A6.2	21/A6.2	AL	FA	HW-1	
003	Α	4' - 0"	7' - 0"	1 3/4"	WD	PL	HM1	1/A6.2	2/A6.2	23/A6.2	НМ	PT	HW-3	
004A	Α	3' - 0"	7' - 0"	1 3/4"	WD	PL	HM1	1/A6.2	2/A6.2	23/A6.2	НМ	PT	HW-3	
004B	В	6' - 0"	7' - 0"	1 3/4"	WD	PL	HM1	1/A6.2	2/A6.2	21/A6.2	НМ	PT	HW-6	
004C	Α	4' - 0"	7' - 0"	1 3/4"	WD	PL	HM1	1/A6.2	2/A6.2	21/A6.2	НМ	PT	HW-6	
005	Α	3' - 0"	7' - 0"	1 3/4"	WD	PL	HM1	1/A6.2	2/A6.2	23/A6.2	НМ	PT	HW-3	
007A	Α	3' - 0"	7' - 0"	1 3/4"	WD	PL	HM1	1/A6.2	2/A6.2	24/A6.2	НМ	PT	HW-1	
007B	Α	3' - 0"	7' - 0"	1 3/4"	WD	PL	EX	EX	EX	24/A6.2	НМ	PT	HW-1	2
800	В	3' - 0"	7' - 0"	1 3/4"	WD	PL	EX	EX	EX	24/A6.2	НМ	PT	HW-1	2
009	В	3' - 0"	7' - 0"	1 3/4"	WD	PL	EX	EX	EX	24/A6.2	НМ	PT	HW-1	2
010	В	3' - 0"	7' - 0"	1 3/4"	WD	PL	EX	EX	EX	24/A6.2	НМ	PT	HW-1	2
011	В	3' - 0"	7' - 0"	1 3/4"	WD	PL	HM1	1/A6.2	2/A6.2	3/A6.2	НМ	PT	HW-1	
012	Α	3' - 0"	7' - 0"	1 3/4"	WD	PL	HM1	1/A6.2	2/A6.2	4/A6.2	НМ	PT	HW-5	
013	Α	3' - 0"	7' - 0"	1 3/4"	WD	PL	EX	EX	EX	23/A6.2	НМ	PT	HW-3	2
015A	В	3' - 0"	7' - 0"	1 3/4"	WD	PL	HM1	1/A6.2	2/A6.2	24/A6.2	НМ	PT	HW-1	
015B	В	3' - 0"	7' - 0"	1 3/4"	WD	PL	HM1	1/A6.2	2/A6.2	24/A6.2	HM	PT	HW-1	
016A	Α	3' - 0"	7' - 0"	1 3/4"	WD	PL	HM1	1/A6.2	2/A6.2	24/A6.2	НМ	PT	HW-1	
017	Α	3' - 0"	7' - 0"	1 3/4"	WD	PL	EX	EX	EX	23/A6.2	НМ	PT	HW-3	2
018	Α	3' - 0"	7' - 0"	1 3/4"	WD	PL	HM1	1/A6.2	2/A6.2	23/A6.2	НМ	PT	HW-3	
019	Α	3' - 0"	7' - 0"	1 3/4"	WD	PL	HM1	1/A6.2	2/A6.2	23/A6.2	НМ	PT	HW-3	
020	Α	3' - 0"	7' - 0"	1 3/4"	WD	PL	HM1	1/A6.2	2/A6.2	4/A6.2	НМ	PT	HW-4	
021	Α	3' - 0"	7' - 0"	1 3/4"	WD	PL	HM1	1/A6.2	2/A6.2	4/A6.2	HM	PT	HW-4	

Number	Elevation	Width	Height	Thickness	Material	Finish	Frame Elevation	Head	Jamb	Thr.	Frame Material	Frame Finish	Hardware Set	Note
100	В	3' - 0"	8' - 0"	1 3/4"	WD	PL	SF1	5/A6.2	9,10/A6.2	25/A6.2	AL	FA	HW-2	1
	A	3' - 0"	8' - 0"	1 3/4"		PL	HM1	1/A6.2	2/A6.2	24/A6.2	HM	PT	HW-4	<u> </u>
1003	В	3' - 0"	8' - 0"	1 3/4"		PL	SF2	5/A6.2	9,10/A6.2	21/A6.2	AL	FA	HW-1	
102	В	3' - 0"	8' - 0"	1 3/4"		PL	SF3	5/A6.2	10,13/A6.2	21/A6.2	AL	FA	HW-1	
103	В	3' - 0"	8' - 0"	1 3/4"		PL	SF3	5/A6.2	10,13/A6.2	21/A6.2	AL	FA	HW-1	
103	В	3' - 0"	8' - 0"	1 3/4"		PL	SF4	5/A6.2	10,12/A6.2	21/A6.2	AL	FA	HW-1	
105	В	3' - 0"	8' - 0"	1 3/4"		PL	SF4	5/A6.2	10,12/A6.2	21/A6.2	AL	FA	HW-1	
106	В	3' - 0"	8' - 0"	1 3/4"		PL	SF4	5/A6.2	10,12/A6.2	21/A6.2	AL	FA	HW-1	
107	В	3' - 0"	8' - 0"	1 3/4"		PL	SF4	-			AL	FA	HW-1	
	В	3' - 0"				PL	SF4 SF5	5/A6.2	10,15/A6.2	21/A6.2				
108			8' - 0"	1 3/4"				5/A6.2	10,16/A6.2	21/A6.2	AL	FA	HW-1	
109	В	3' - 0"	8' - 0"	1 3/4"		PL	SF5	5/A6.2	10,12/A6.2	21/A6.2	AL	FA	HW-1	
110	В	3' - 0"	8' - 0"	1 3/4"	WD	PL	SF5	5/A6.2	10,12/A6.2	21/A6.2	AL	FA	HW-1	
111	В	3' - 0"	8' - 0"	1 3/4"		PL	SF5	5/A6.2	10,12/A6.2	21/A6.2	AL	FA	HW-1	
112	В	3' - 0"	8' - 0"	1 3/4"		PL	SF3	5/A6.2	10,15/A6.2	21/A6.2	AL	FA	HW-1	
113	В	3' - 0"	8' - 0"	1 3/4"		PL	SF6	5/A6.2	10,11/A6.2	21/A6.2	AL	FA	HW-1	
114	В	3' - 0"	8' - 0"	1 3/4"		PL	SF12	5/A6.2	9/A6.2	21/A6.2	AL	FA	HW-1	
115	В	3' - 0"	8' - 0"	1 3/4"		PL	SF7	5/A6.2	10,12/A6.2	21/A6.2	AL	FA	HW-1	
116	В	3' - 0"	8' - 0"	1 3/4"		PL	SF7	5/A6.2	10,12/A6.2	21/A6.2	AL	FA	HW-1	
117	В	3' - 0"	8' - 0"	1 3/4"		PL	SF7	5/A6.2	10,12/A6.2	21/A6.2	AL	FA	HW-1	
118	В	3' - 0"	8' - 0"	1 3/4"		PL	SF7	5/A6.2	10,12/A6.2	21/A6.2	AL	FA	HW-1	
119	В	3' - 0"	8' - 0"	1 3/4"	WD	PL	SF7	6/A6.2	10,12/A6.2	21/A6.2	AL	FA	HW-1	
	В	3' - 0"	8' - 0"	1 3/4"		PL	SF7	6/A6.2	10,12/A6.2	21/A6.2	AL	FA	HW-1	
121	В	3' - 0"	8' - 0"	1 3/4"	WD	PL	SF7	6/A6.2	10,12/A6.2	21/A6.2	AL	FA	HW-1	
122	В	3' - 0"	8' - 0"	1 3/4"	WD	PL	SF7	6/A6.2	10,15/A6.2	21/A6.2	AL	FA	HW-1	
123	В	3' - 0"	8' - 0"	1 3/4"	WD	PL	SF1	5/A6.2	9,10/A6.2	21/A6.2	AL	FA	HW-1	
24	Α	3' - 0"	7' - 0"	1 3/4"	WD	PL	EX	EX	EX	23/A6.2	НМ	PT	HW-3	2
125	Α	3' - 0"	7' - 0"	1 3/4"	WD	PL	EX	EX	EX	23/A6.2	HM	PT	HW-3	2
126	Α	3' - 0"	7' - 0"	1 3/4"	WD	PL	HM1	1/A6.2	2/A6.2	4/A6.2	HM	PT	HW-4	
127	A	3' - 0"	7' - 0"	1 3/4"	WD	PL	HM1	1/A6.2	2/A6.2	4/A6.2	HM	PT	HW-4	
128	Α	3' - 0"	7' - 0"	1 3/4"	WD	PL	HM1	1/A6.2	2/A6.2	23/A6.2	НМ	PT	HW-3	
29	В	3' - 0"	8' - 0"	1 3/4"	WD	PL	SF1	5/A6.2	9,10/A6.2	21/A6.2	AL	FA	HW-1	
130	В	3' - 0"	8' - 0"	1 3/4"	WD	PL	SF1	5/A6.2	9,10/A6.2	21/A6.2	AL	FA	HW-1	
131	В	3' - 0"	8' - 0"	1 3/4"	WD	PL	SF10	5/A6.2	10,18/A6.2	21/A6.2	AL	PT	HW-4	
132	В	3' - 0"	8' - 0"	1 3/4"	WD	PL	SF6	5/A6.2	9,10/A6.2	21/A6.2	AL	FA	HW-1	
133	A	3' - 0"	8' - 0"	1 3/4"	WD	PL	HM1	1/A6.2	2/A6.2	23/A6.2	НМ	PT	HW-3	
134	В	3' - 0"	8' - 0"	1 3/4"		PL	SF6	5/A6.2	10,15/A6.2	21/A6.2	AL	FA	HW-1	

Door Hardware Sets:

* Refer to written specifications for door hardware.

HW-1 OFFICE

HW-4 PASSAGE

HW-5 PRIVACY

HW-6 CLASSROOM

HW-3 STOREROOM

Door Schedule Keynotes:

CARD READER ACCESS EXISTING DOOR FRAME TO REMAIN. PAINT PT-4

Door Legend:

ALUMINUM FACTORY HOLLOW METAL PLASTIC LAMINATE

STAIN SIMILAR WD EX WOOD EXISTING

Glazing Legend:

NOT USED

G2 NOT USED


G3 NOT USED

1/2" CLEAR TEMPERED GLASS

3/8" CLEAR TEMPERED GLASS

1/4" CLEAR TEMPERED GLASS

1. PROVIDE TEMPERED GLASS WHERE REQUIRED BY CODE.

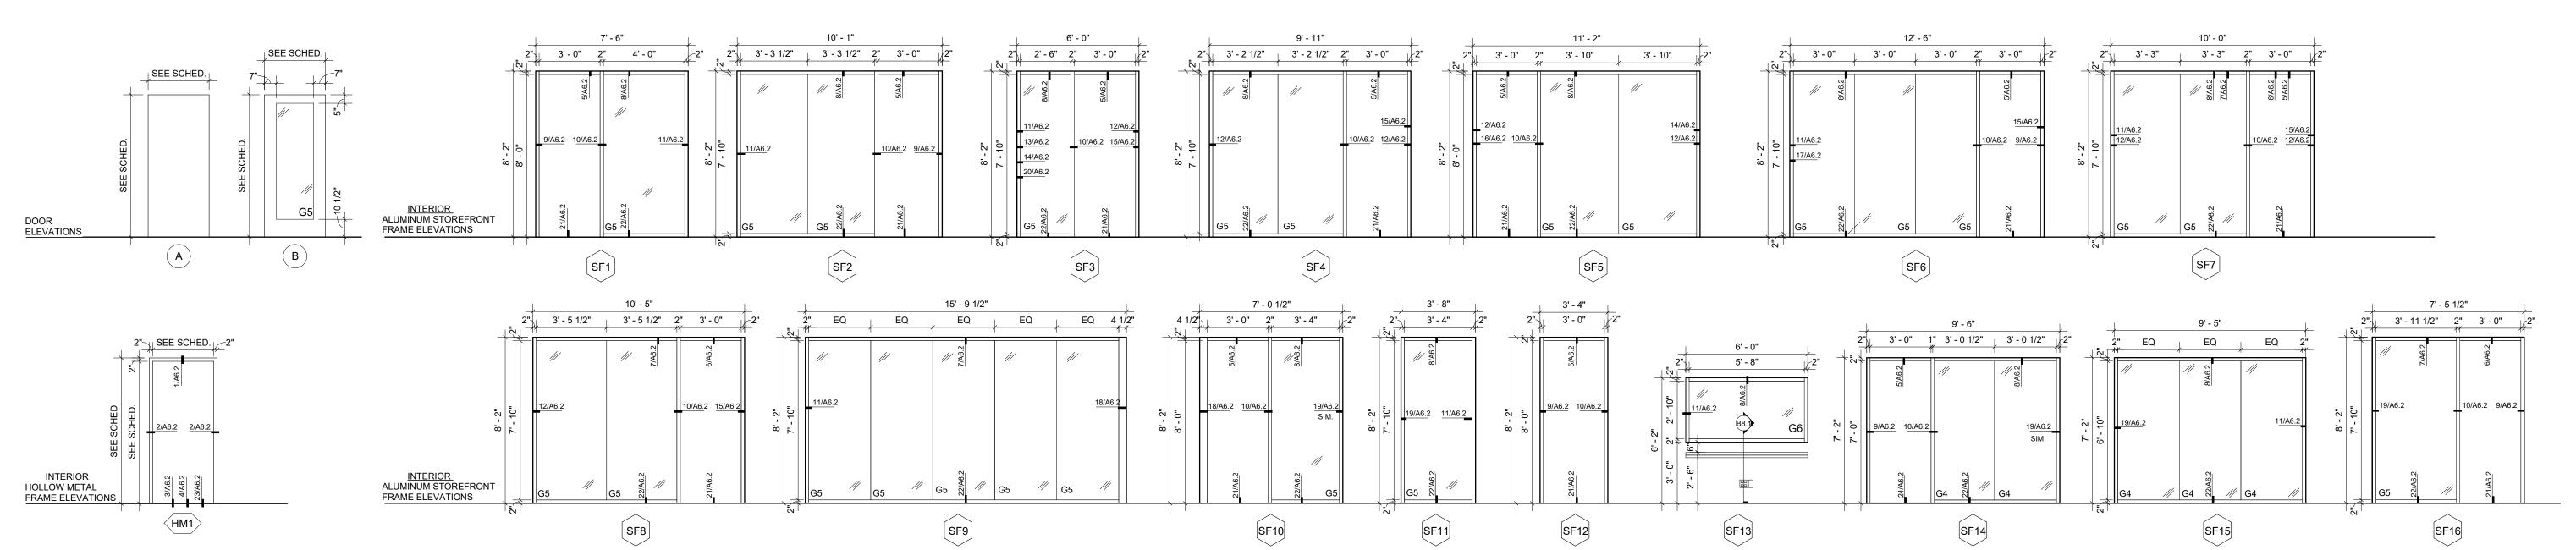



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JOB NO.: 24.121

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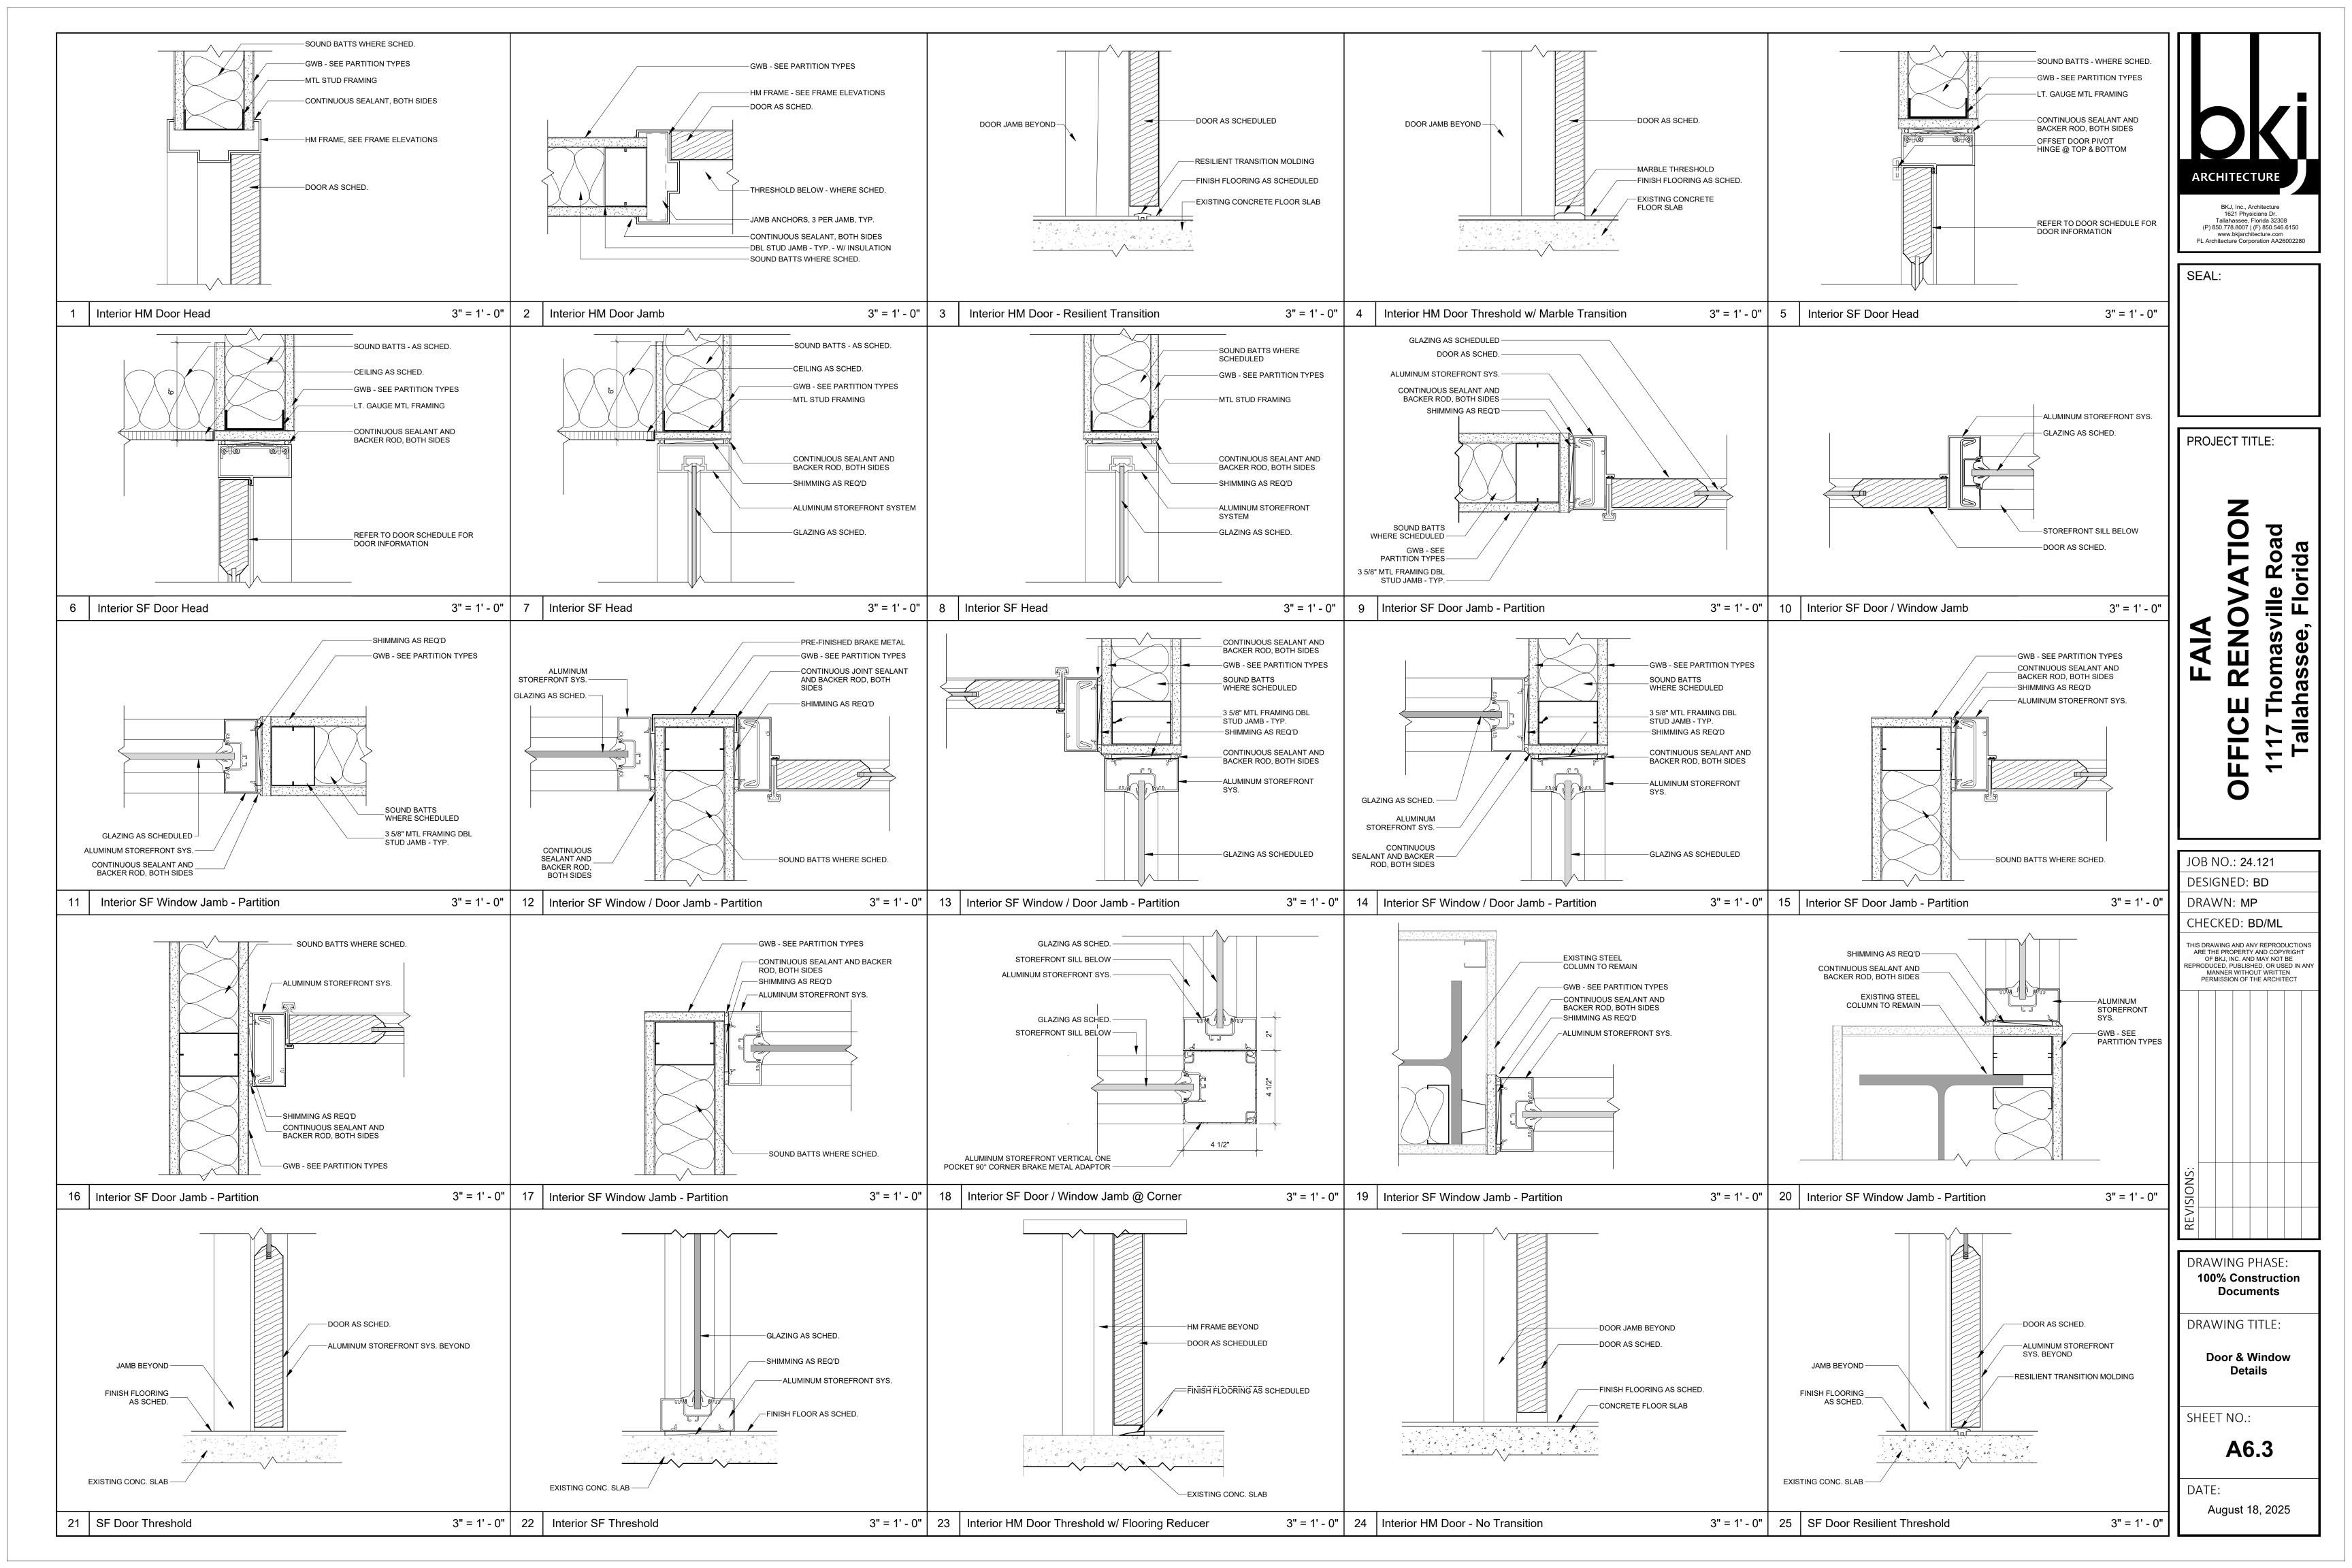
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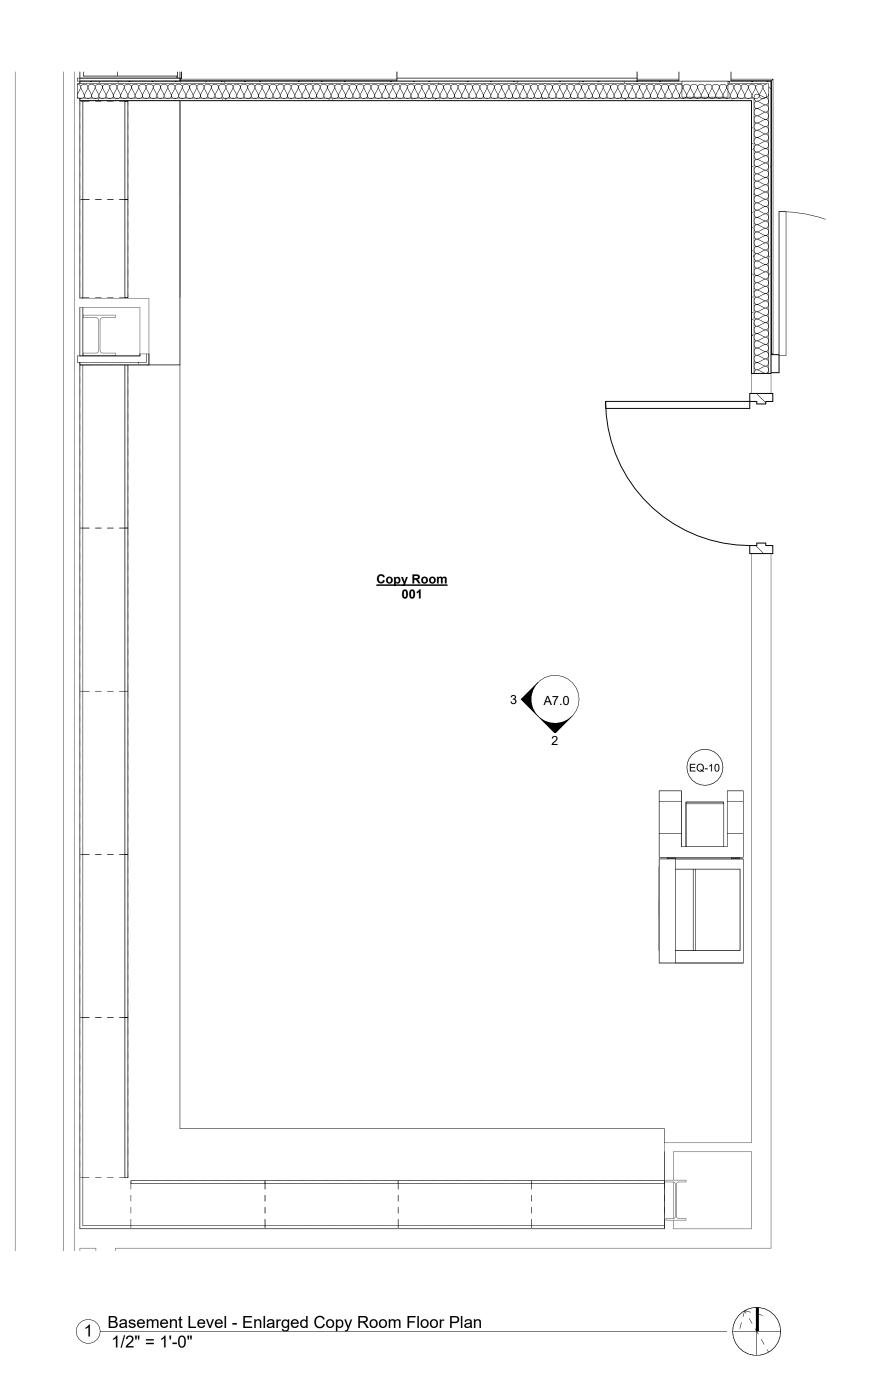
Door Schedule & Door / Frame Elevations, **Details**


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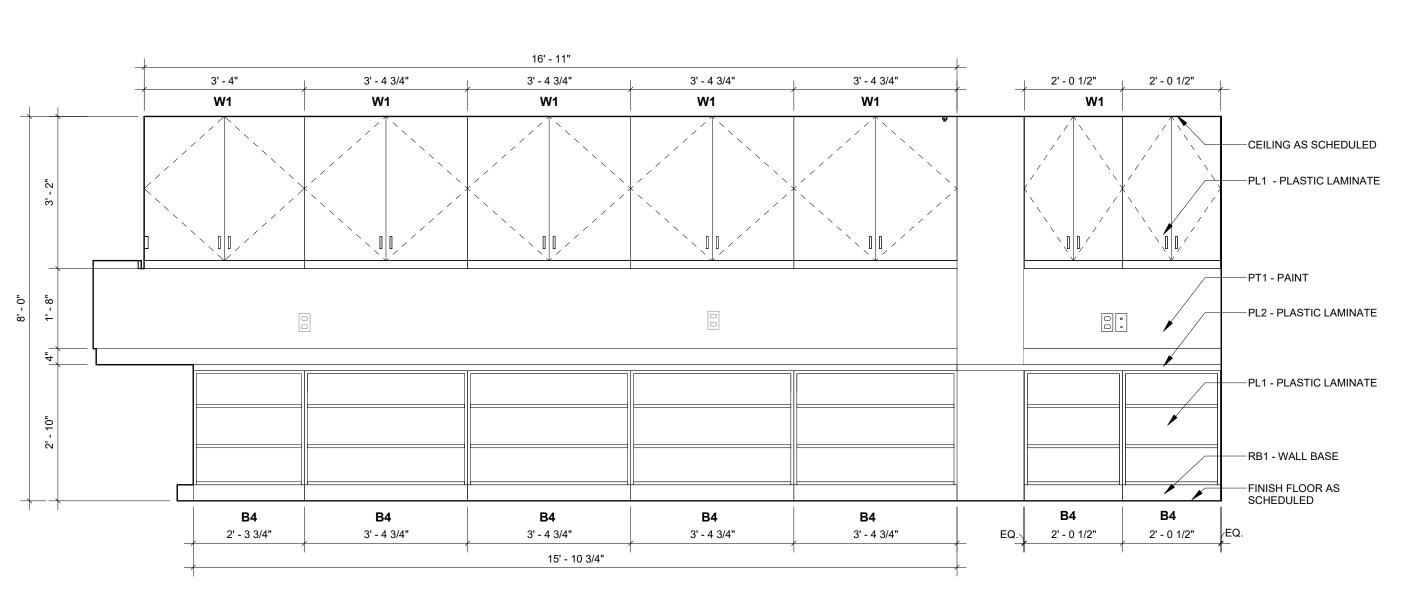
DATE:

A6.2







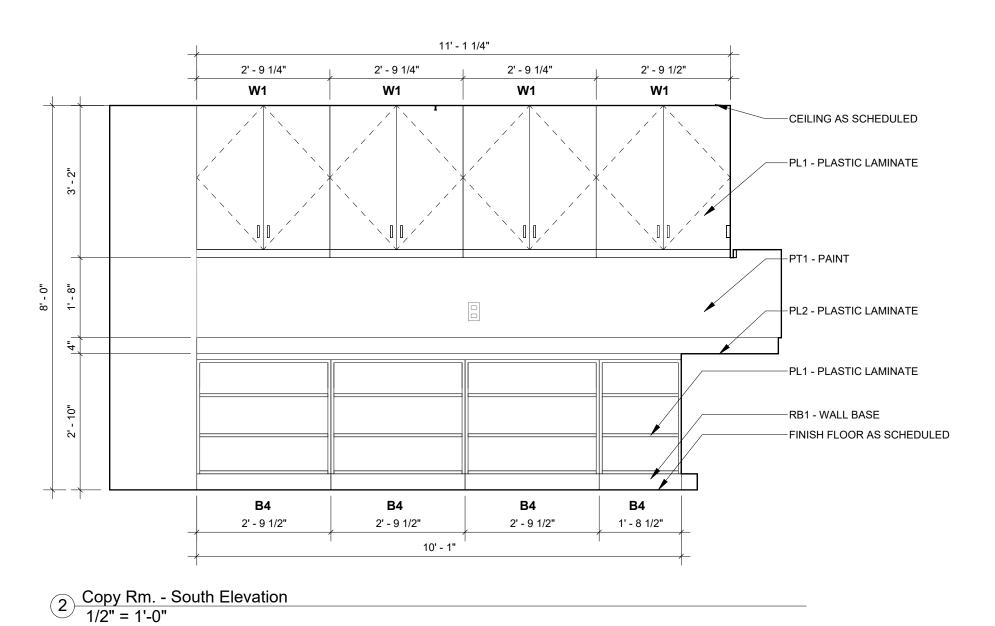

3 Copy Rm. - West Elevation 1/2" = 1'-0"

Millwork General Notes:

1. MILLWORK TO BE USED AS BASIS OF DESIGN.

CONTRACTOR TO SUBMIT SHOP DRAWINGS FOR ALL MILLWORK TO TENANT FOR COORDINATION AND FINAL APPROVAL.

3. MILLWORK DIMENSIONS ARE MEASURED FROM FACE OF FINISH

4.PROVIDE BLOCKING IN WALLS FOR MILLWORK AS NEEDED

5. PROVIDE HAFELE PULL CUBE (H1935), ALUMINUM, 5" DOOR PULLS.6. P.L. SKIRT BELOW UPPER CABINETS ON ALL EXPOSED SIDES OF CABINETS (I.E.- BREAK ROOM SINK).

NOTE: COORDINATE EQUIPMENT DIMENSIONS AND ROUGH-IN REQUIREMENTS WITH OWNER.

ARCHITECTURE

BKJ, Inc., Architecture

BKJ, Inc., Architecture 1621 Physicians Dr. Tallahassee, Florida 32308 (P) 850.778.8007 | (F) 850.546.6150 www.bkjarchitecture.com FL Architecture Corporation AA26002280

SEAL:

PROJECT TITLE:

DFFICE RENOVATION1117 Thomasville Road
Tallahassee, Florida

DESIGNED: BD

DRAWN: JH/MP

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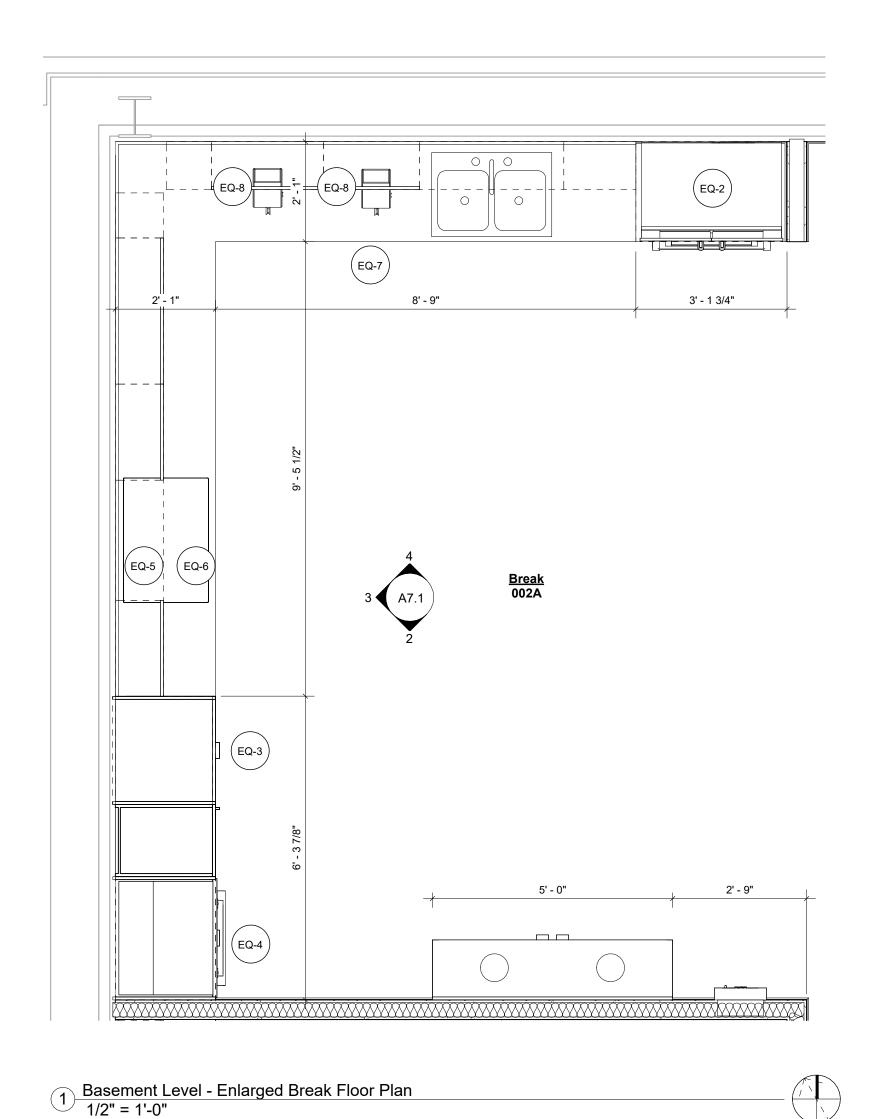
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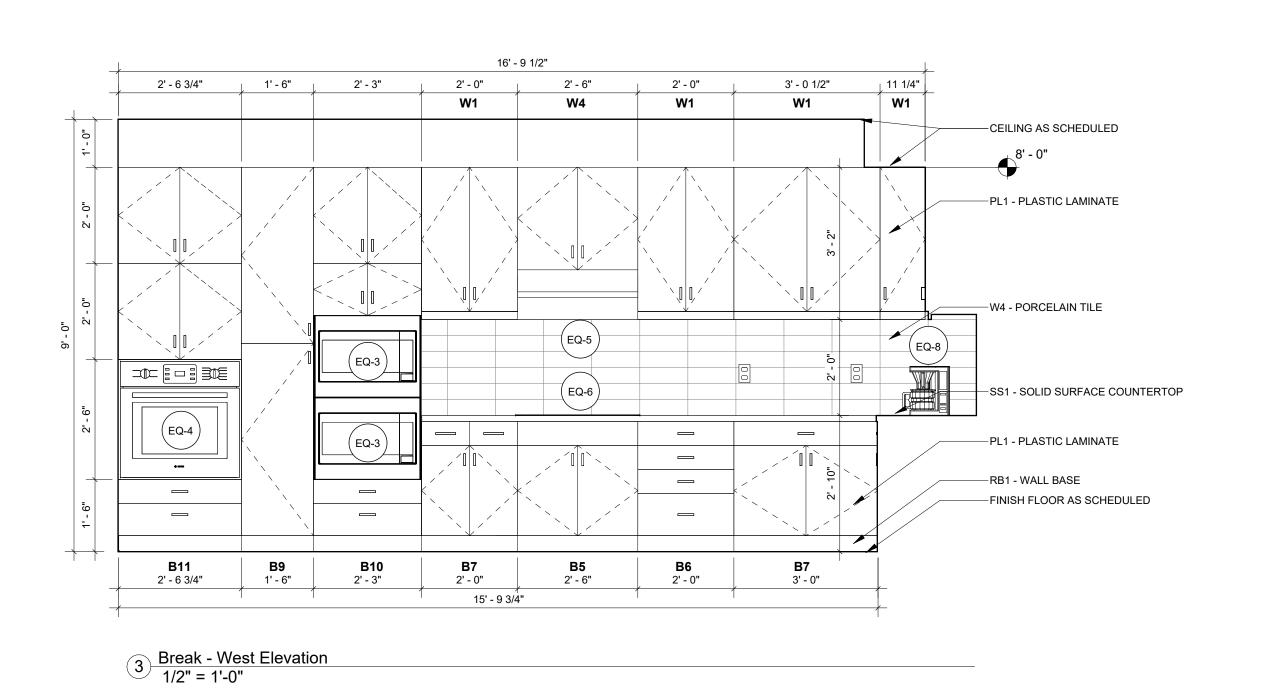
Millwork Enlarged Plans & Elevations -Copy Room


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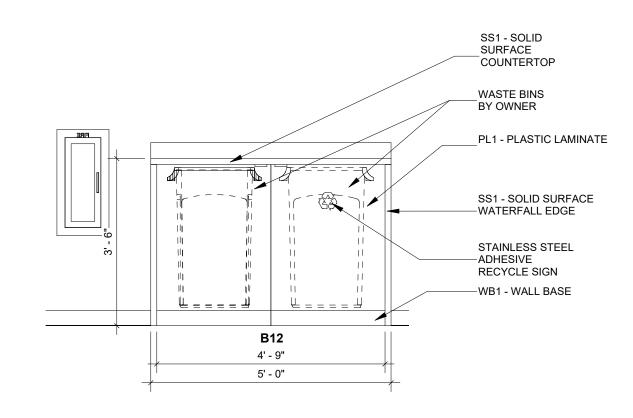
A7.0

ATE:







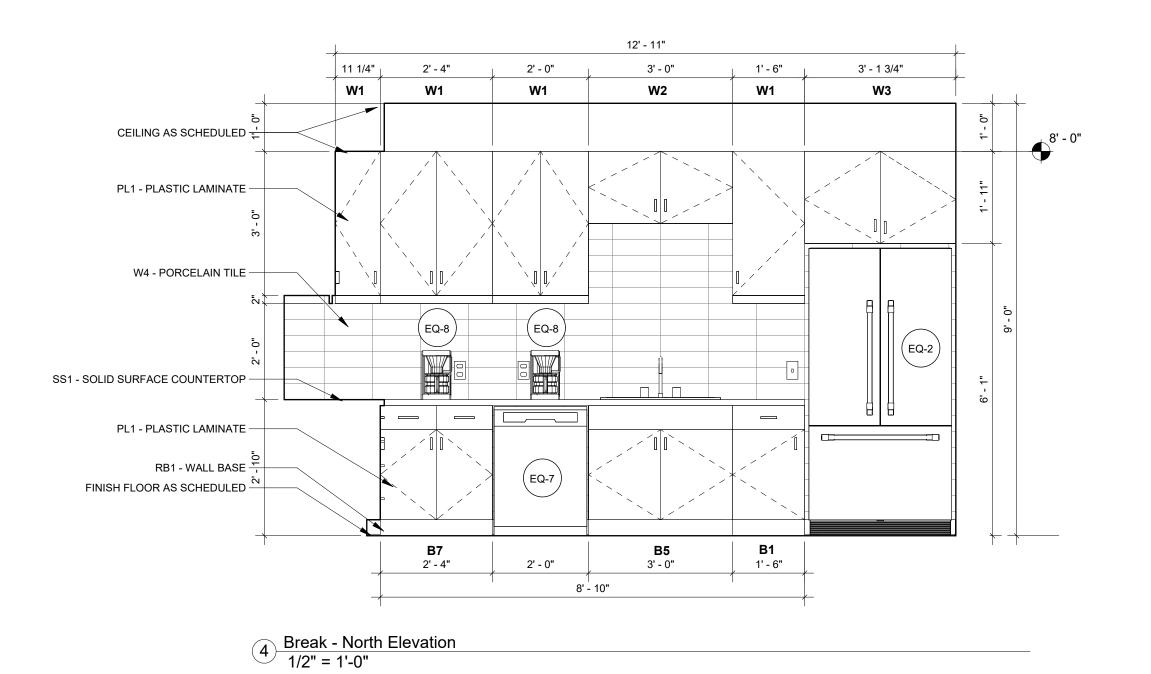

2 Break - South Elevation 1/2" = 1'-0"

Millwork General Notes:

1. MILLWORK TO BE USED AS BASIS OF DESIGN.

2. CONTRACTOR TO SUBMIT SHOP DRAWINGS FOR ALL MILLWORK TO TENANT FOR COORDINATION AND FINAL APPROVAL.

3. MILLWORK DIMENSIONS ARE MEASURED FROM FACE OF FINISH

4.PROVIDE BLOCKING IN WALLS FOR MILLWORK AS NEEDED

5. PROVIDE HAFELE PULL CUBE (H1935), ALUMINUM, 5" DOOR PULLS. 6. P.L. SKIRT BELOW UPPER CABINETS ON ALL EXPOSED SIDES OF CABINETS (I.E.- BREAK ROOM SINK).

NOTE: COORDINATE EQUIPMENT DIMENSIONS AND ROUGH-IN REQUIREMENTS WITH OWNER.

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PROJECT TITLE:

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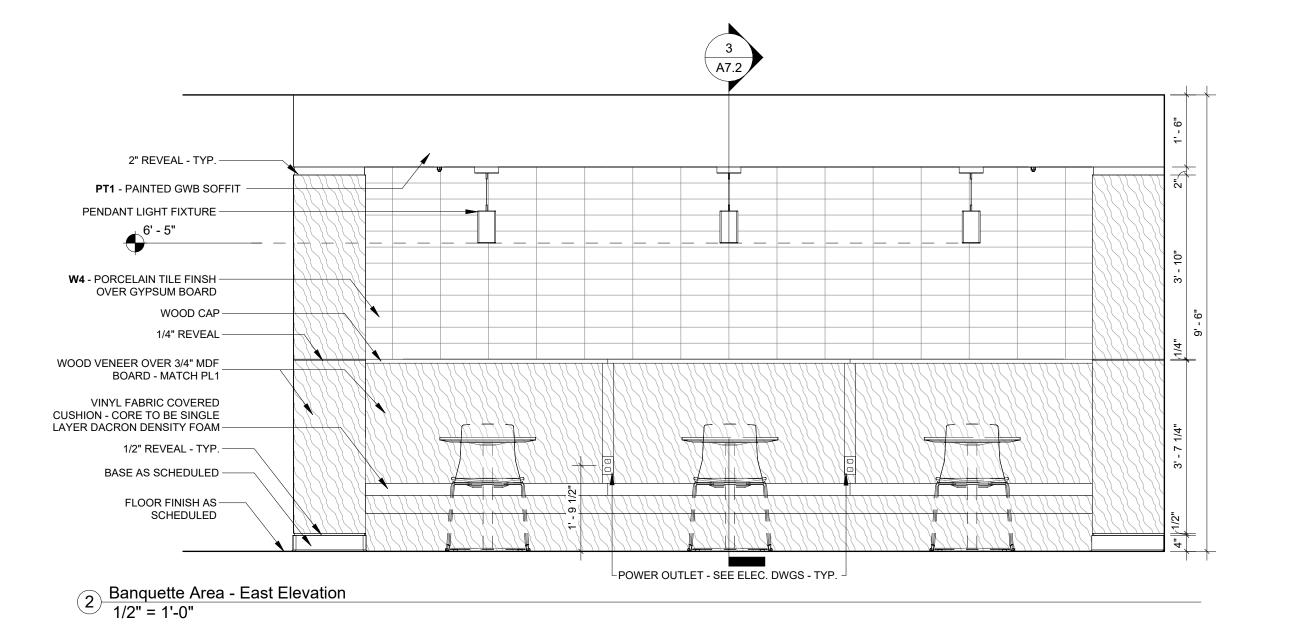
DRAWING TITLE:

Millwork Enlarged Plans & Elevations -**Break Room**

SHEET NO.:

A7.1

DATE:




PROVIDE C-CHANNEL TO BRIDGE BETWEEN

EXISTING HAT CHANNELS, SECURE NEW

CEILING/SOFFIT/BULKHEAD FRAMING TO


NEW C-CHANNELS AS REQUIRED

DIAGONAL MTL BRACING @ 32" O.C.

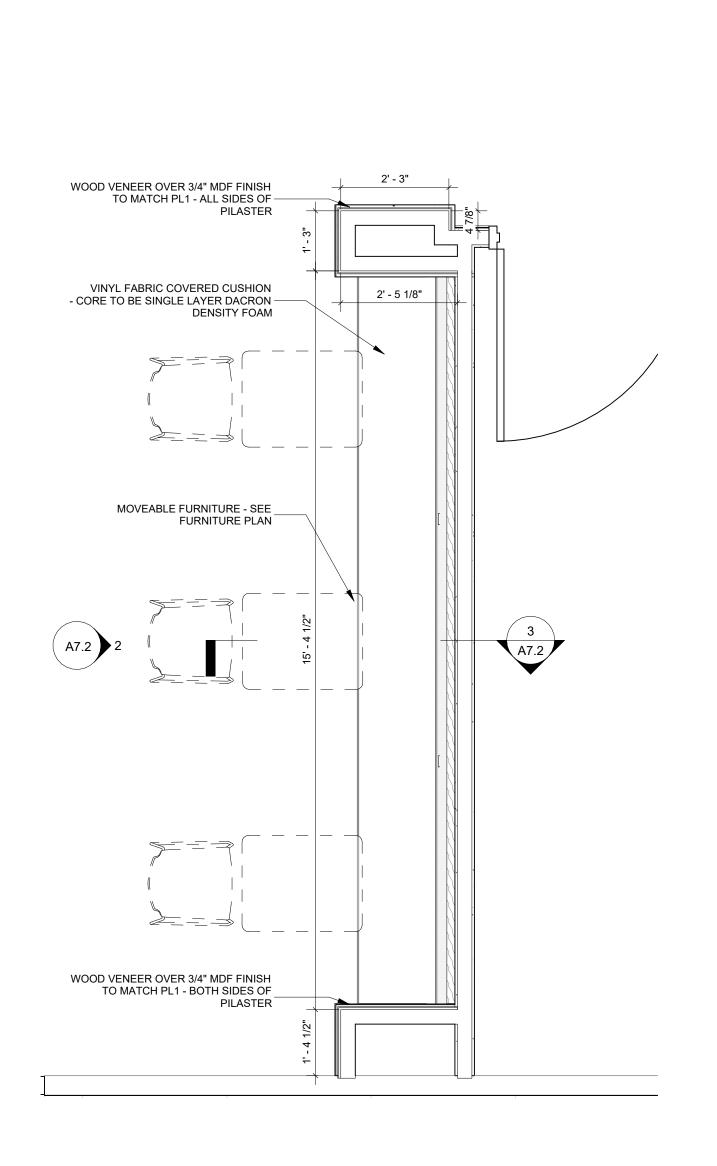

1 Basement Level - Enlarged Banquette Plan 1/2" = 1'-0"



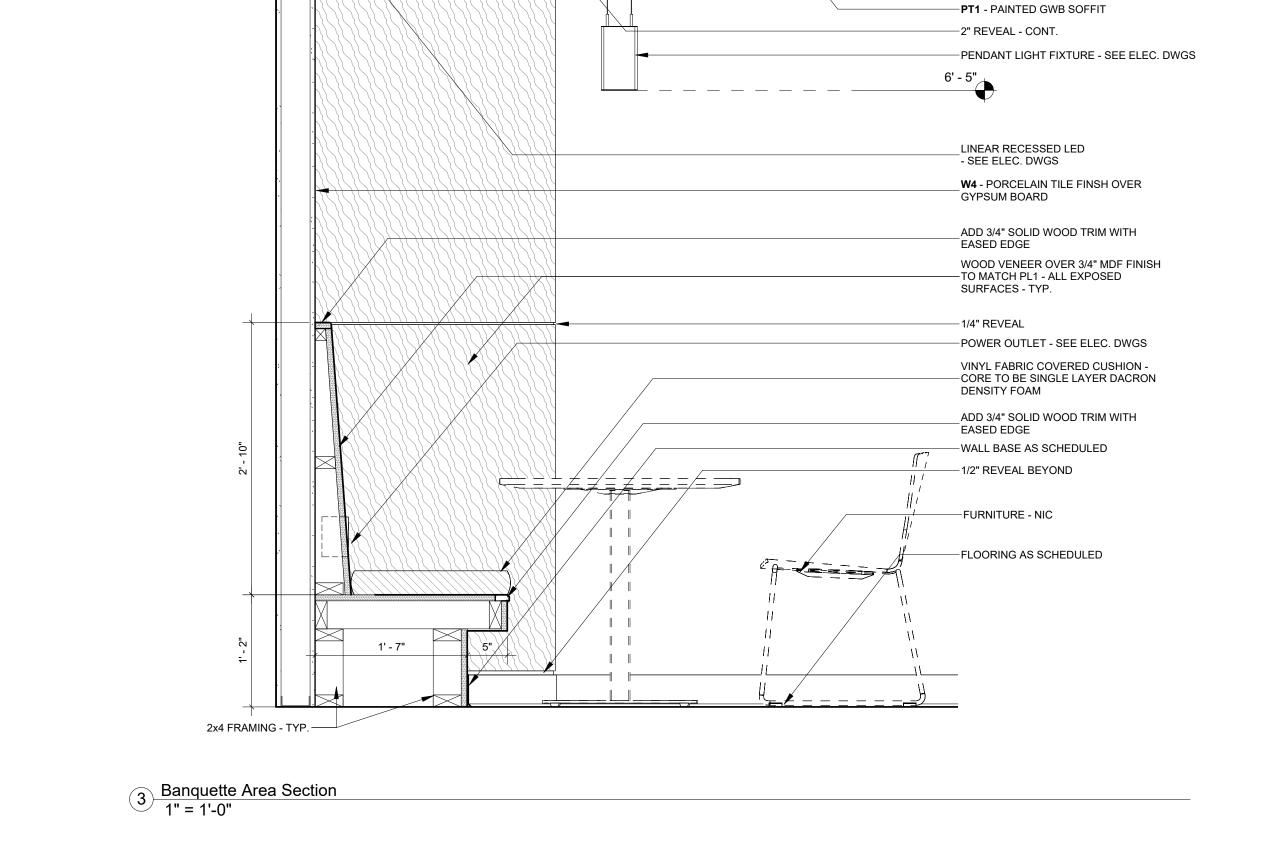

__MTL FRAMING @ 16" O.C. MAX - DIAGONAL BRACING TO ABOVE @ 48" O.C. MAX

Millwork General Notes:

1. MILLWORK TO BE USED AS BASIS OF DESIGN.

2. CONTRACTOR TO SUBMIT SHOP DRAWINGS FOR ALL MILLWORK TO TENANT FOR COORDINATION AND FINAL APPROVAL.

3. MILLWORK DIMENSIONS ARE MEASURED FROM FACE OF FINISH SURFACE

4.PROVIDE BLOCKING IN WALLS FOR MILLWORK AS NEEDED

5. PROVIDE HAFELE PULL CUBE (H1935), ALUMINUM, 5" DOOR PULLS.

6. P.L. SKIRT BELOW UPPER CABINETS ON ALL EXPOSED SIDES OF CABINETS (I.E.- BREAK ROOM SINK).

NOTE: COORDINATE EQUIPMENT DIMENSIONS AND ROUGH-IN REQUIREMENTS WITH OWNER.

ARCHITECTURE

BKJ, Inc., Architecture 1621 Physicians Dr. Tallahassee, Florida 32308 (P) 850.778.8007 | (F) 850.546.6150 www.bkjarchitecture.com FL Architecture Corporation AA26002280

SEAL:

PROJECT TITLE:

FICE RENOVATION 117 Thomasville Road Tallahassee, Florida

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Ch	HEC	KE	D: I	BD/	ML							
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REVISIONS:												

JOB NO.: 24.121

DESIGNED: **BD**

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DRAWING PHASE:


DRAWING TITLE:

Millwork Enlarged Plans & Elevations -Break Room

SHEET NO.:

A7.2

DATE:

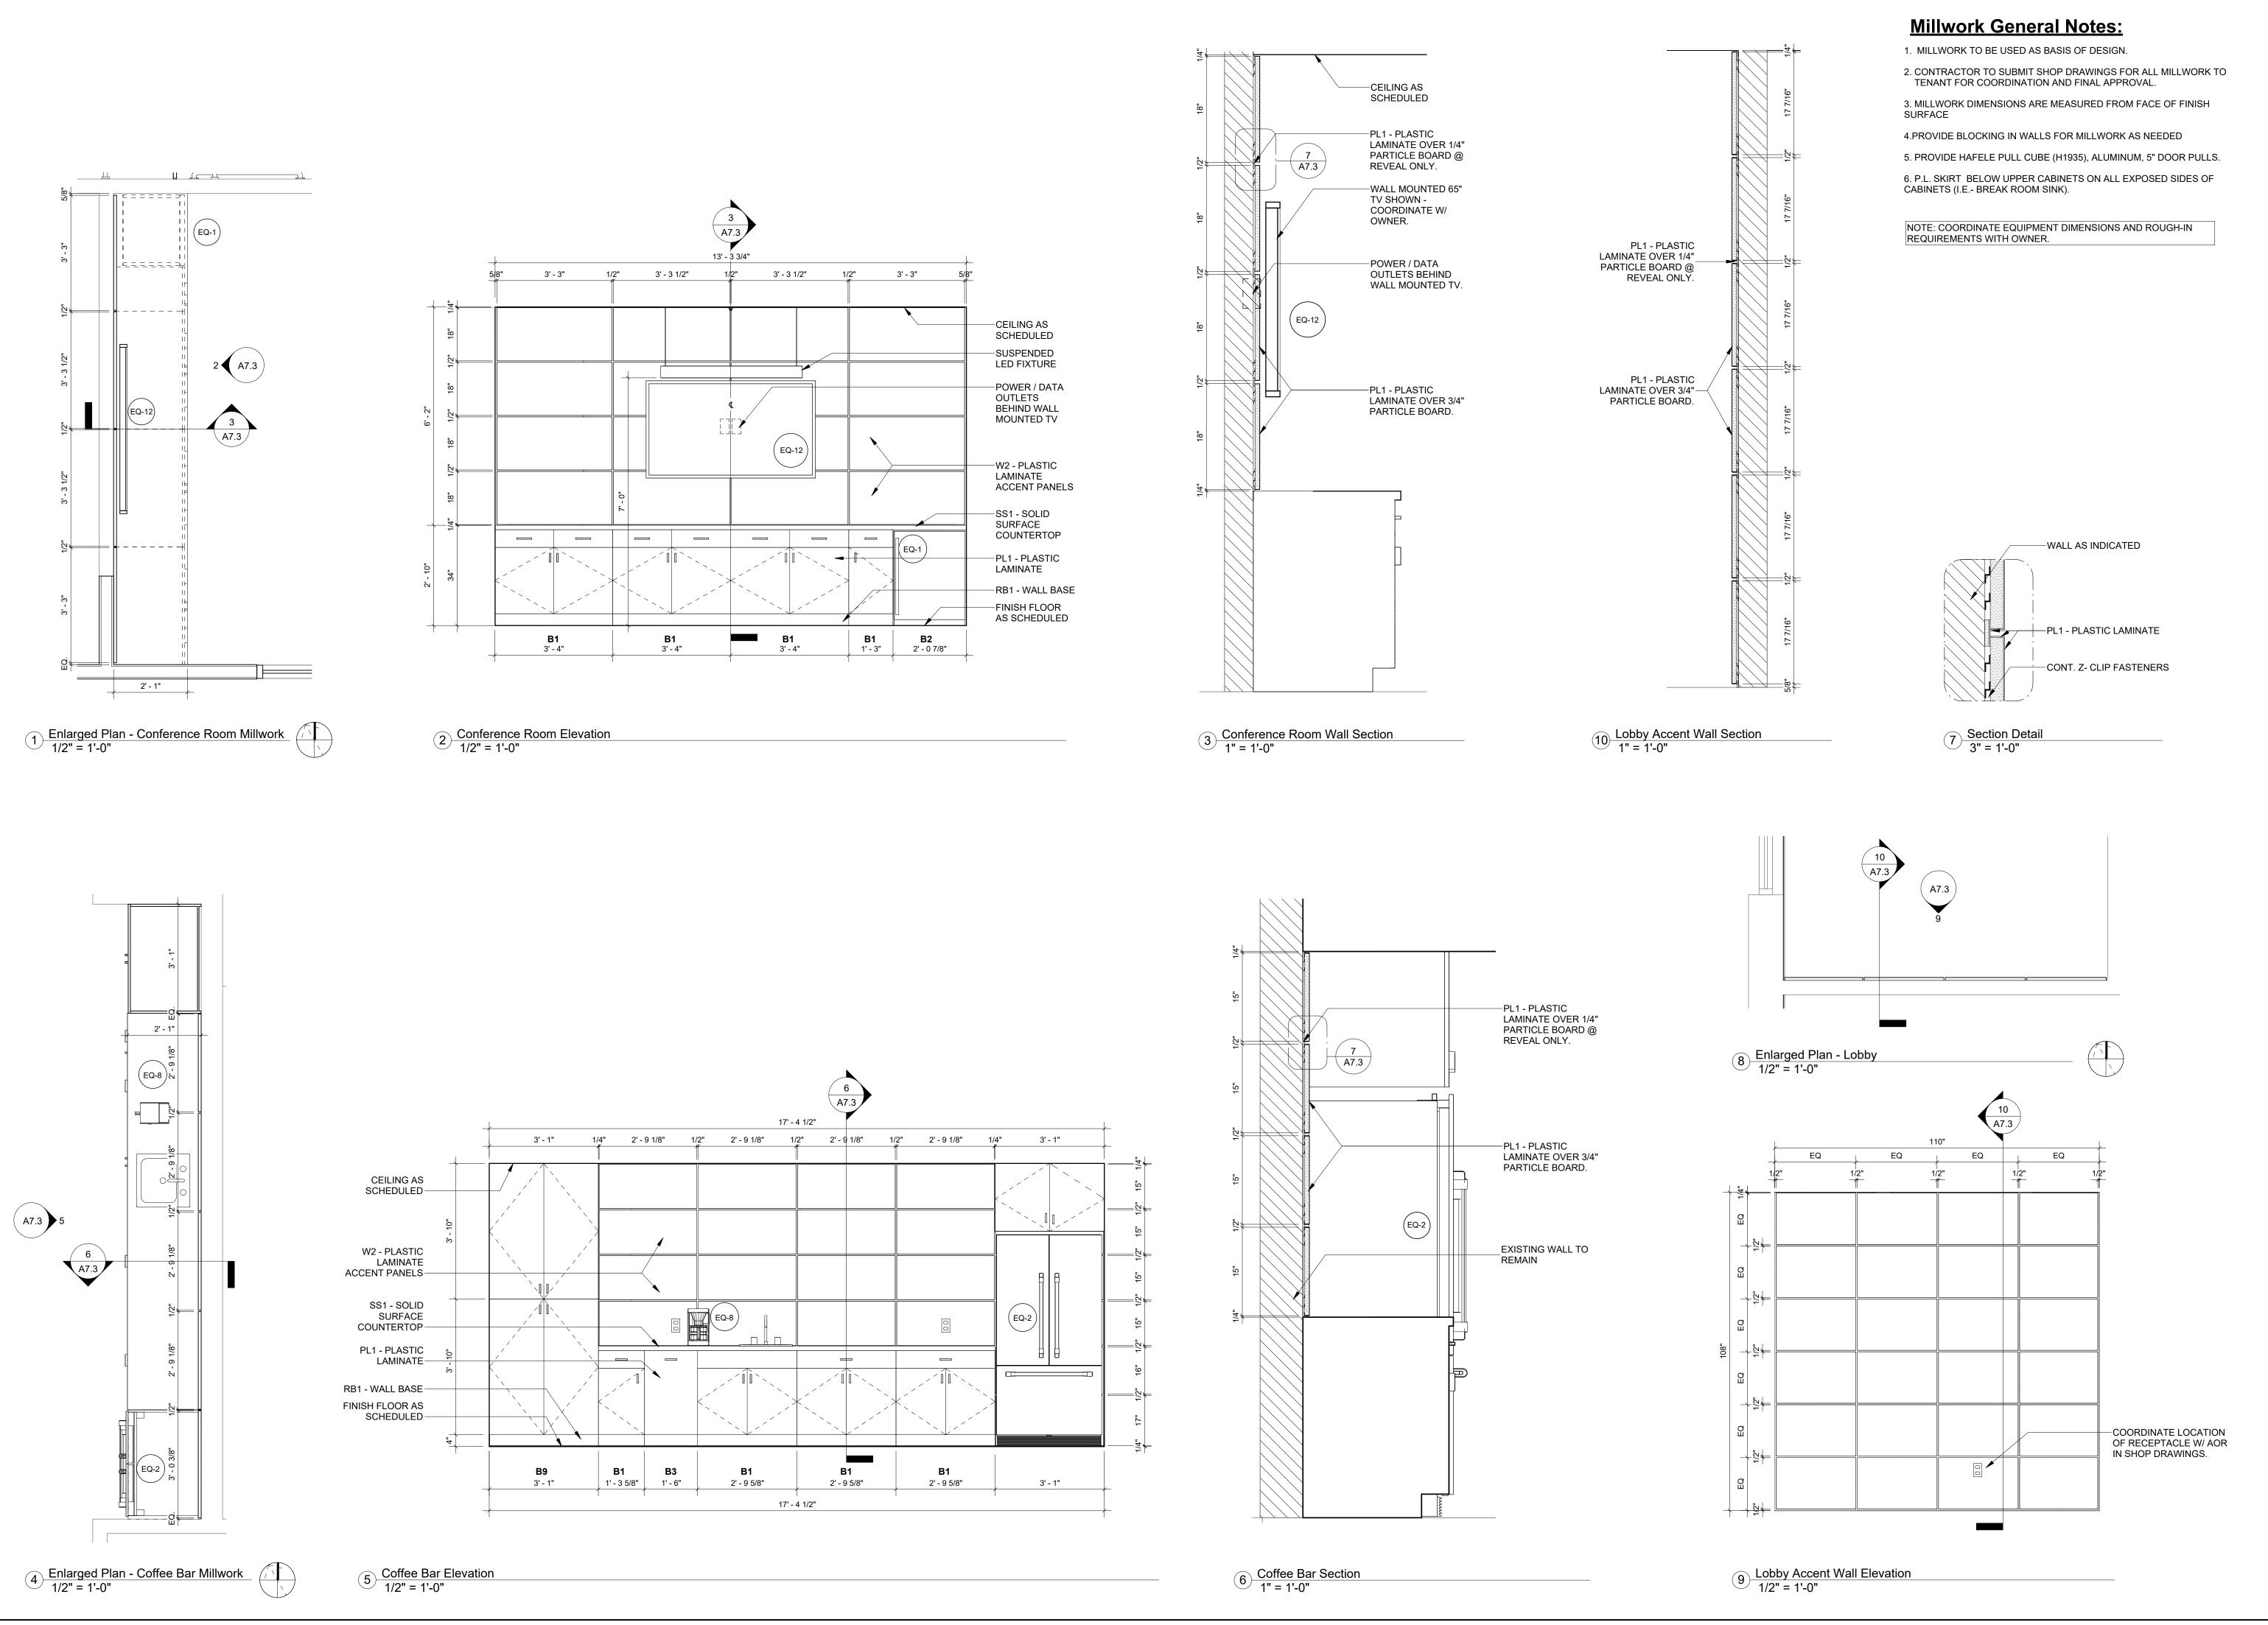

ARCHITECTURE

BKJ, Inc., Architecture 1621 Physicians Dr. Tallahassee, Florida 32308 (P) 850.778.8007 | (F) 850.546.6150 www.bkjarchitecture.com FL Architecture Corporation AA26002280

SEAL:

PROJECT TITLE:

RENOVATION nomasville Road nassee, Florida

JOB NO.: 24.121

DESIGNED: BD

DRAWN: JH/MP

CHECKED: BD/ML

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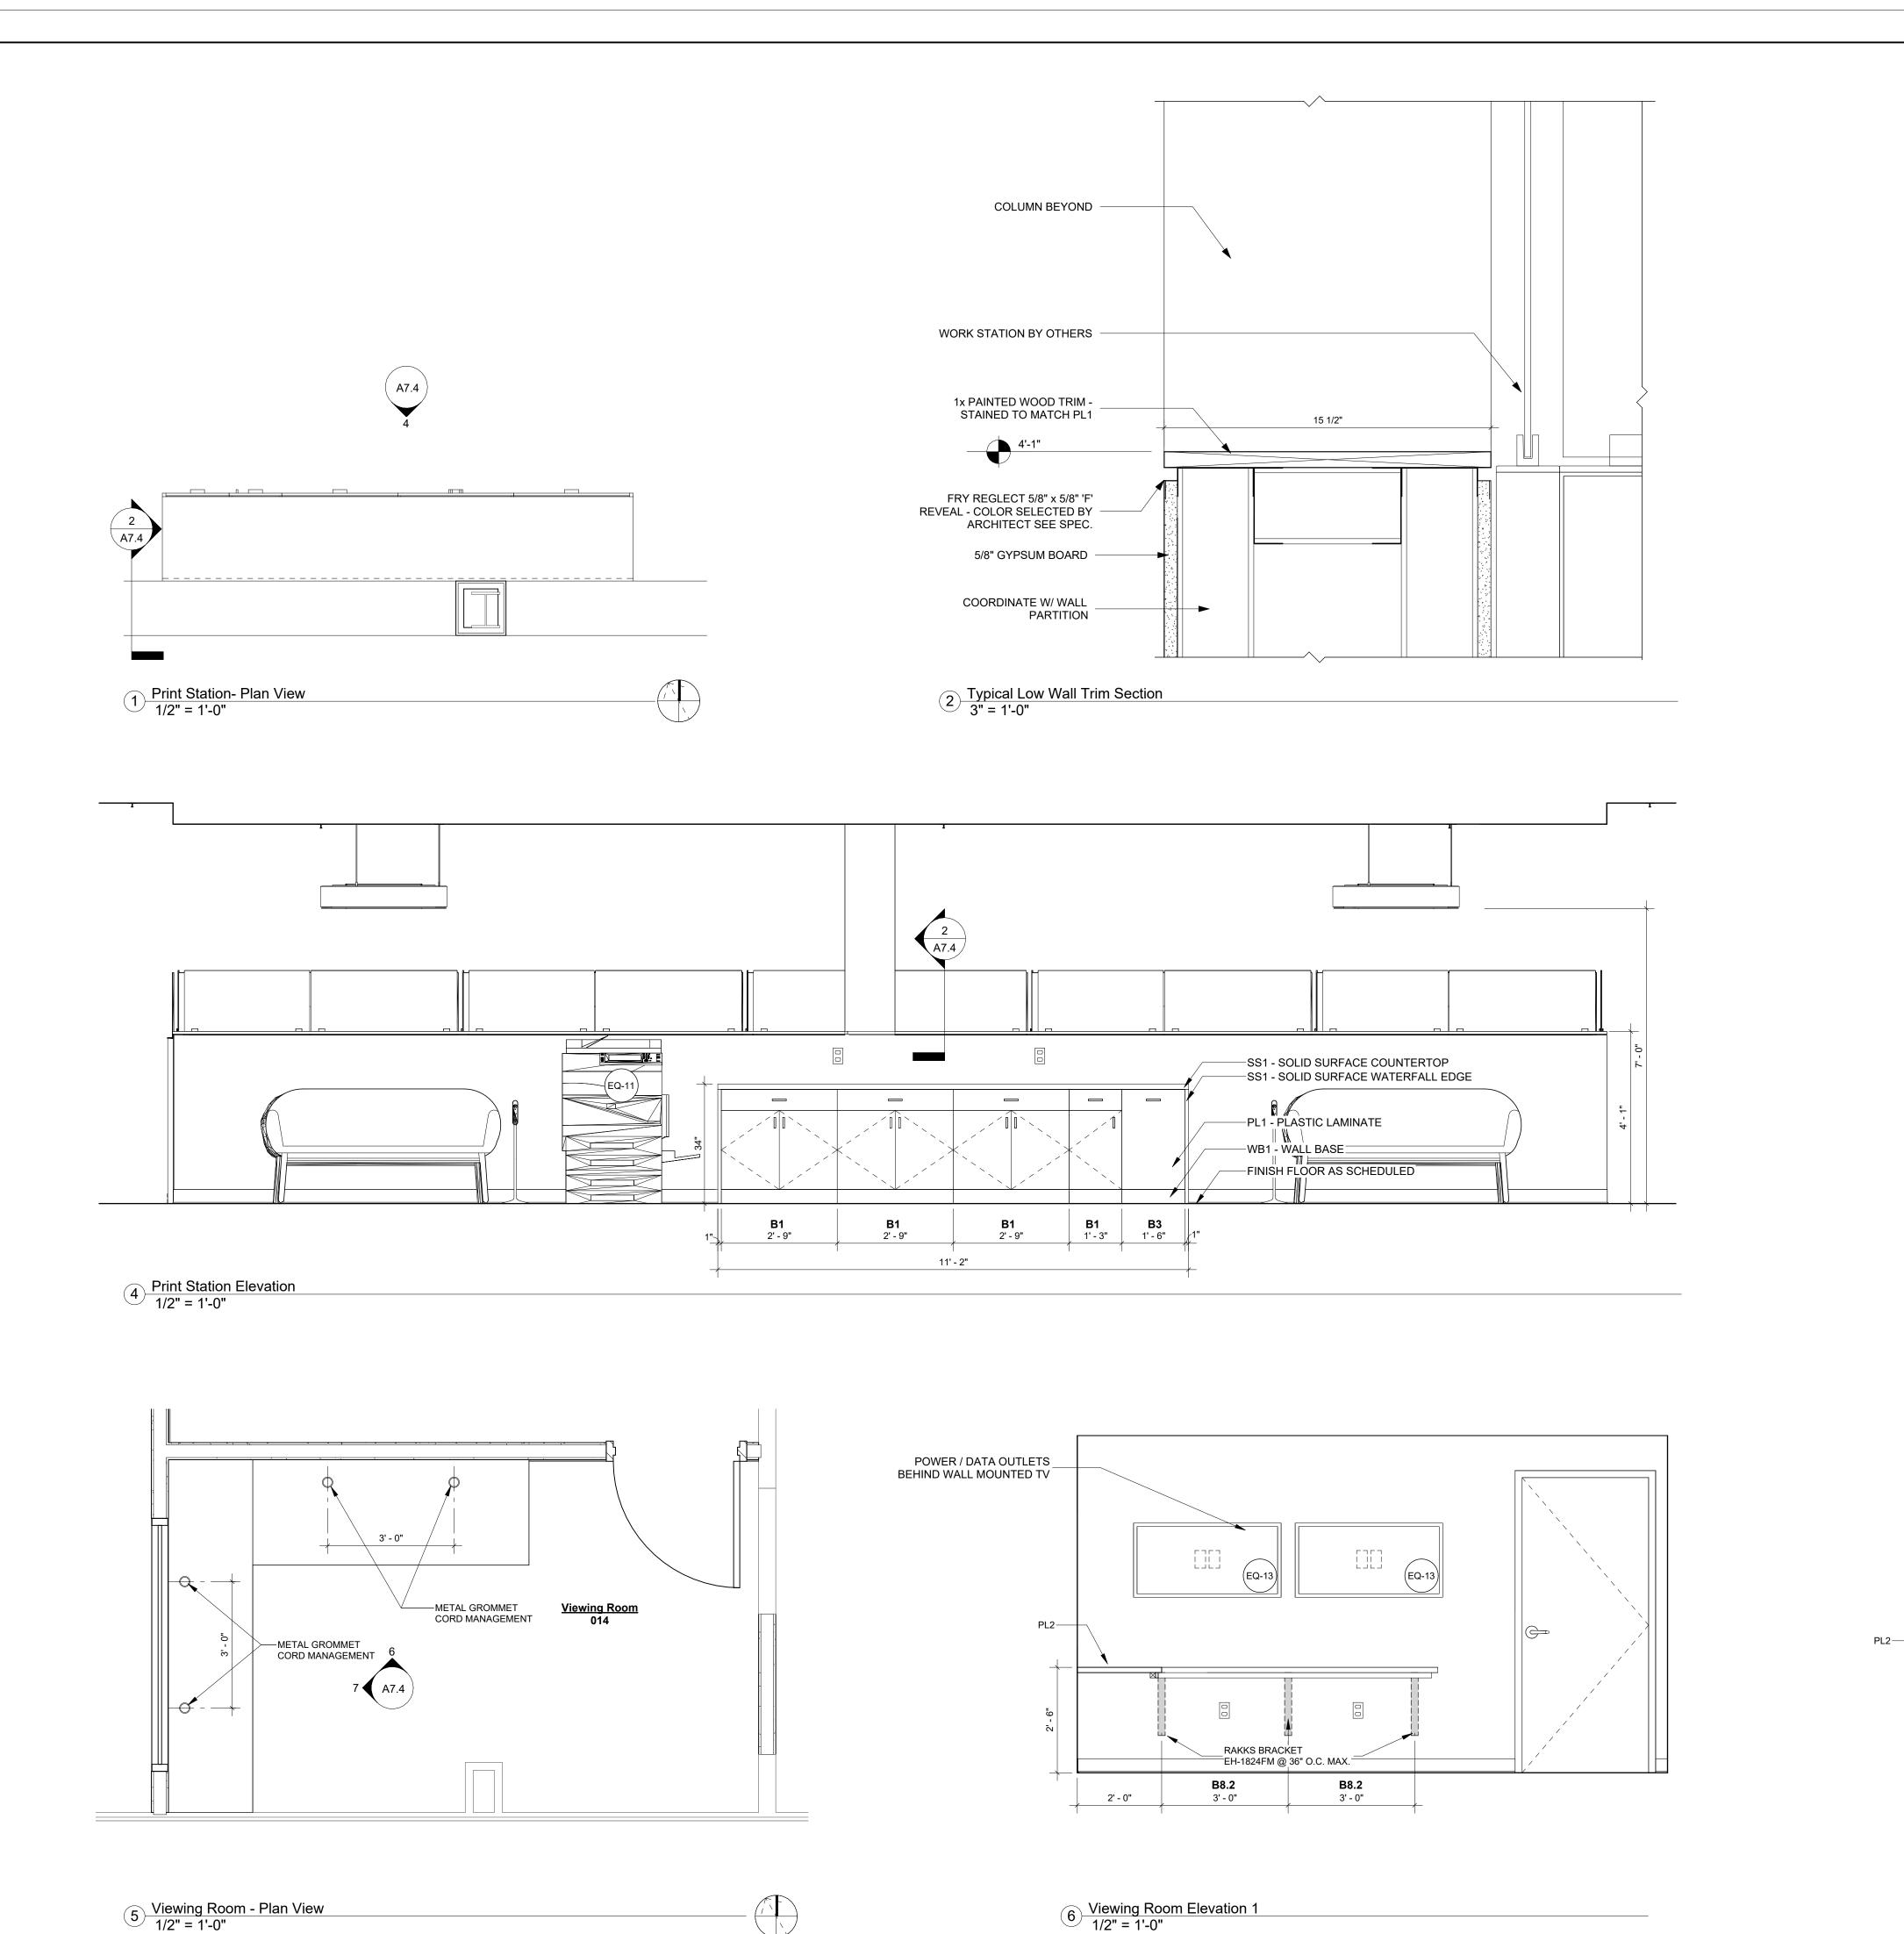
DRAWING TITLE:

Millwork Enlarged Plans & Elevations -Conference, Lobby, & Coffee Bar

SHEET NO.:

A7.3

DATE:



Millwork General Notes:

1. MILLWORK TO BE USED AS BASIS OF DESIGN.

B8.1 A7.5

B8.1 2' - 8 3/8"

7 Viewing Room Elevation 2
1/2" = 1'-0"

SF13

RAKKS BRACKET

B8.1 2' - 8"

—EH-1818FM @ 36" -

O.C. MAX.

- 2. CONTRACTOR TO SUBMIT SHOP DRAWINGS FOR ALL MILLWORK TO TENANT FOR COORDINATION AND FINAL APPROVAL.
- 3. MILLWORK DIMENSIONS ARE MEASURED FROM FACE OF FINISH SURFACE
- 4.PROVIDE BLOCKING IN WALLS FOR MILLWORK AS NEEDED
- 5. PROVIDE HAFELE PULL CUBE (H1935), ALUMINUM, 5" DOOR PULLS.6. P.L. SKIRT BELOW UPPER CABINETS ON ALL EXPOSED SIDES OF CABINETS (I.E.- BREAK ROOM SINK).

NOTE: COORDINATE EQUIPMENT DIMENSIONS AND ROUGH-IN REQUIREMENTS WITH OWNER.

BKJ, Inc., Architecture
1621 Physicians Dr.
Tallahassee, Florida 32308
(P) 850.778.8007 | (F) 850.546.6150
www.bkjarchitecture.com
FL Architecture Corporation AA26002280

SEAL:

PROJECT TITLE:

E RENOVATION
Thomasville Road

JOB NO.: 24.121

DESIGNED: BD

DRAWN: JH/MP

CHECKED: BD/ML

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DRAWING PHASE:

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Documents


DRAWING TITLE:

Millwork Enlarged Plans & Elevations -Print Station & Viewing Room

SHEET NO.:

A7.4

DATE:

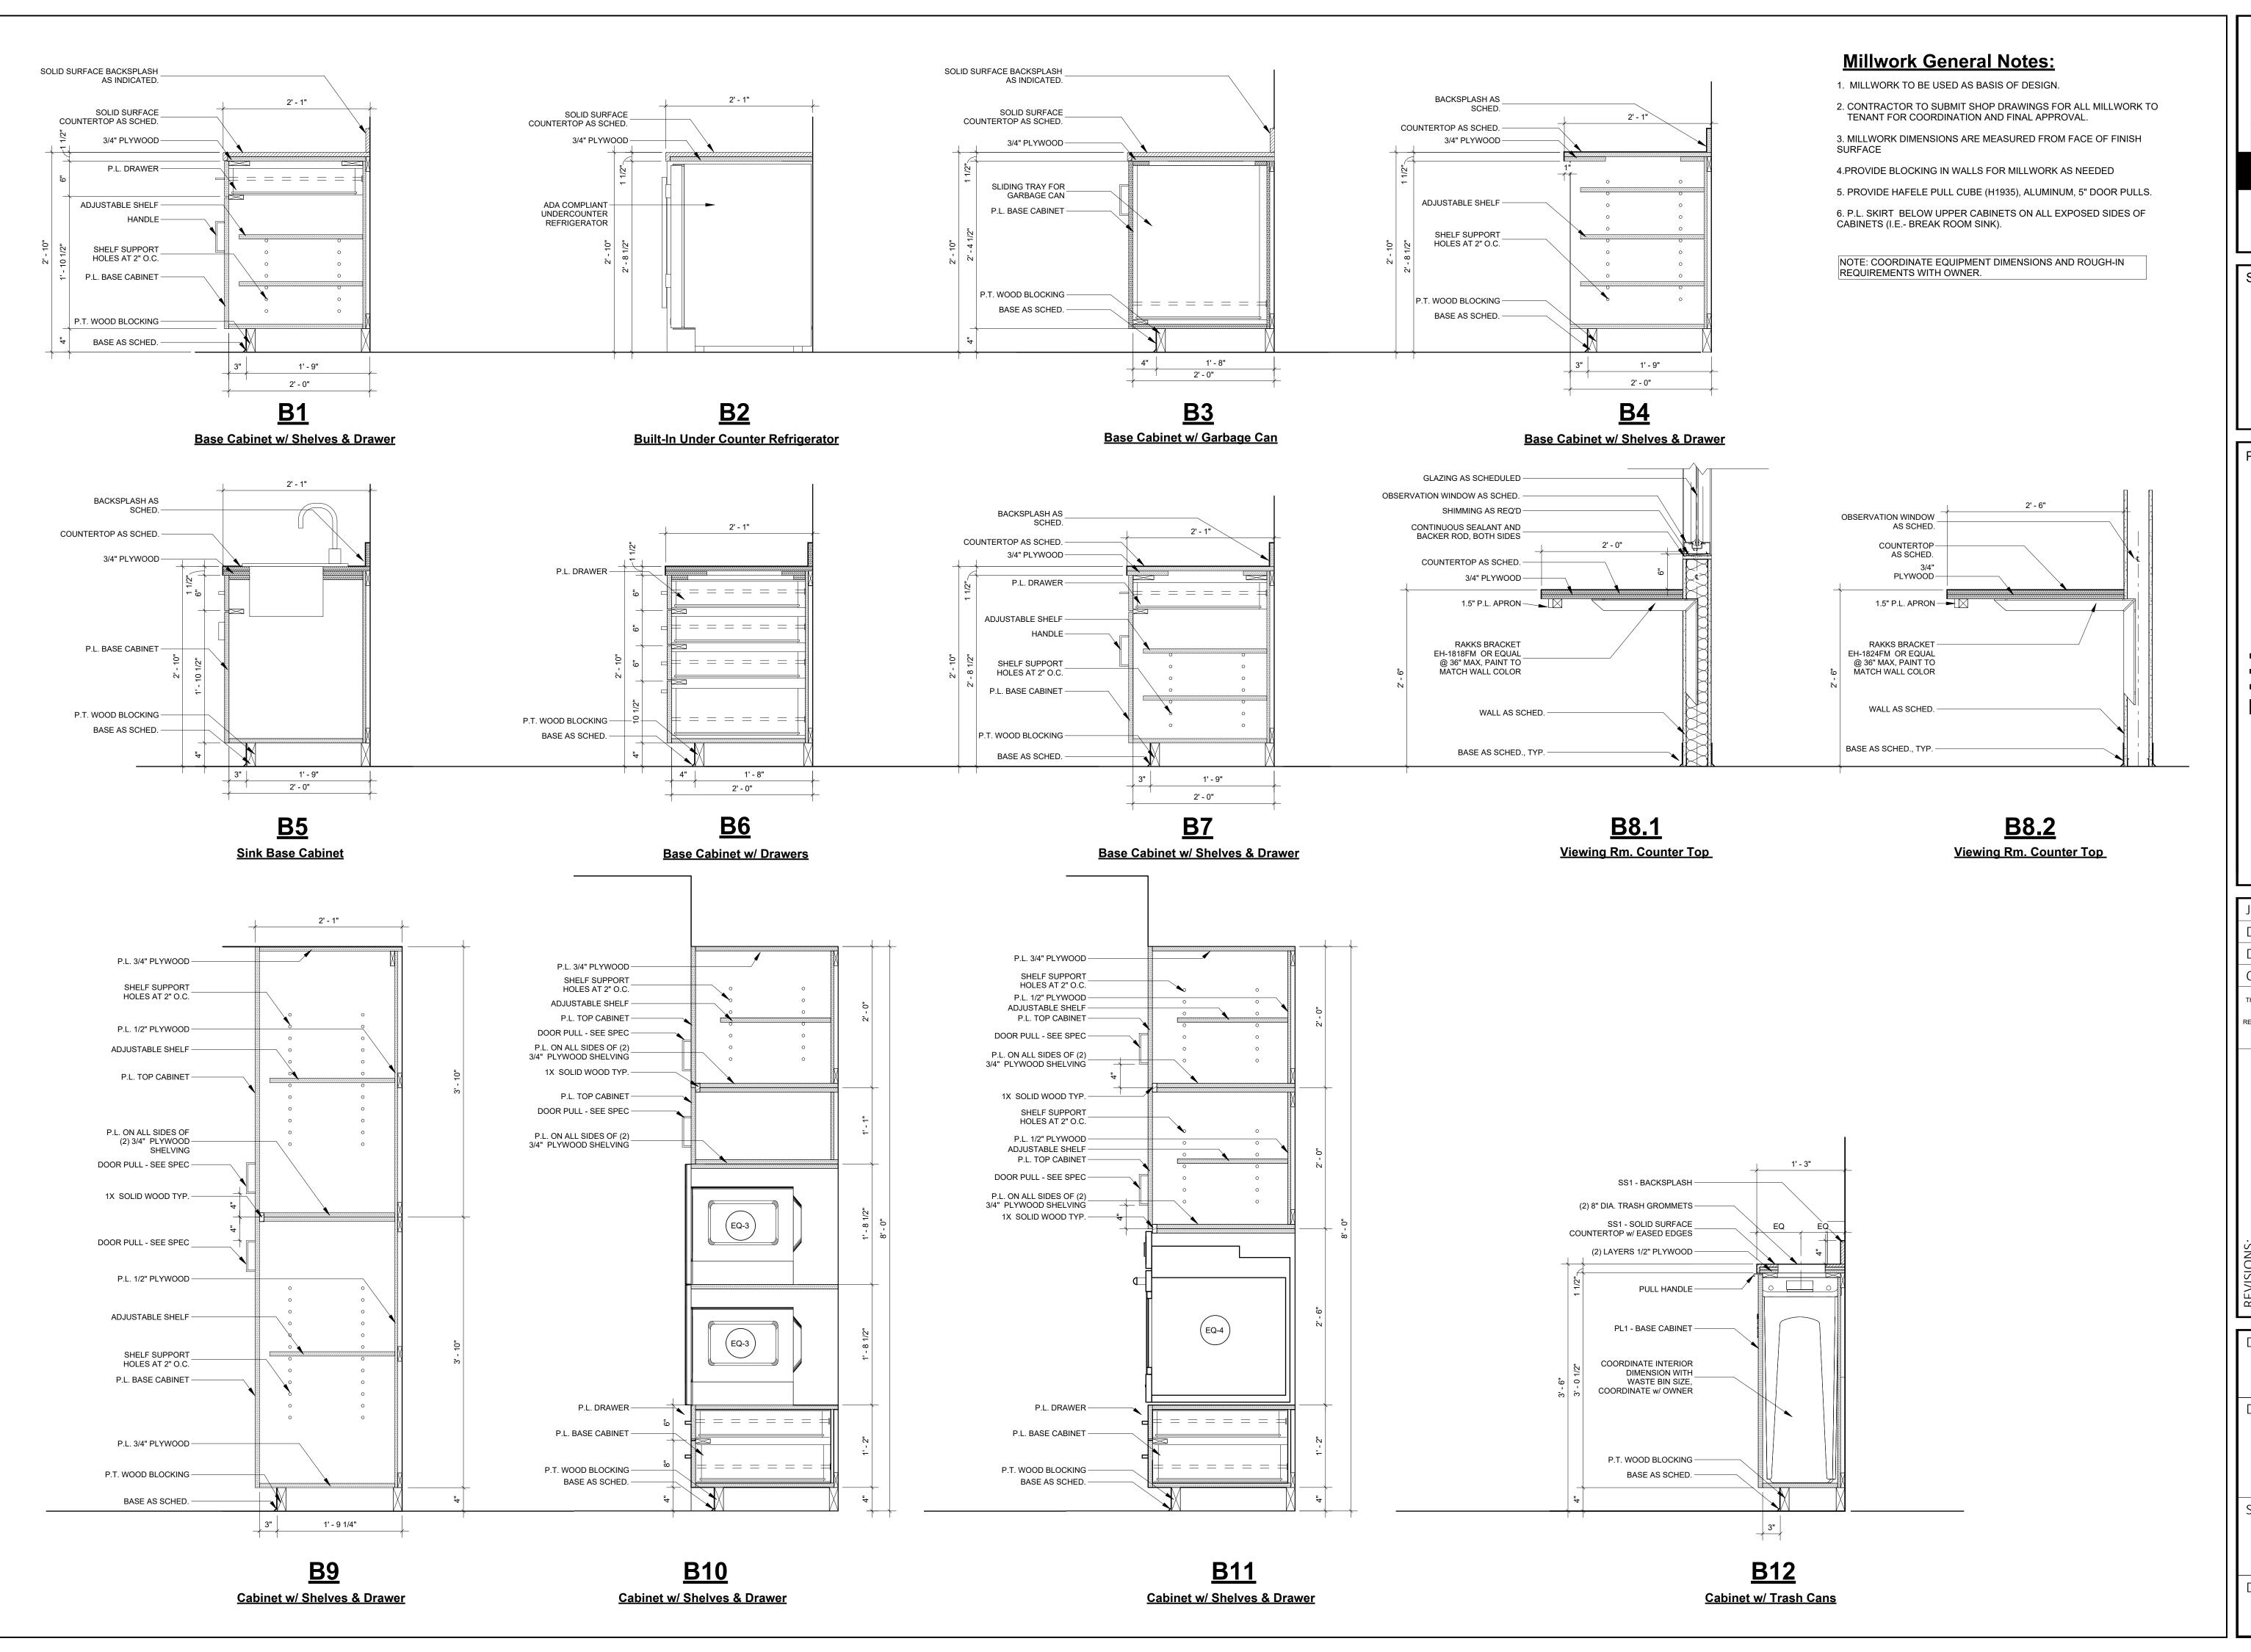

ARCHITECTURE

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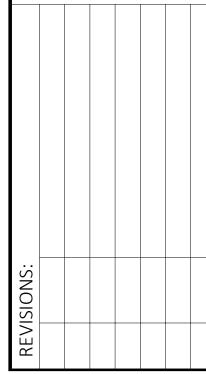
PROJECT TITLE:

ICE RENOVATION
17 Thomasville Road

JOB NO.: 24.121
DESIGNED: BD
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DRAWING PHASE:
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Documents

DRAWING TITLE:

Millwork Sections

SHEET NO.: **A7.5**

D.A.T.E.

SHELF SUPPORT HOLES SHELF SUPPORT HOLES SHELF SUPPORT HOLES SHELF SUPPORT HOLES P.L. ADJUSTABLE SHELF -P.L. ADJUSTABLE SHELF -P.L. ADJUSTABLE SHELF -P.L. ADJUSTABLE SHELF SHELF SUPPORT HOLES _ AT 2" O.C. P.L. ALL EXPOSED _ SURFACES _ P.L. ADJUSTABLE SHELF — P.L. ALL EXPOSED _ SURFACES HOOD AS SPEC. -P.L. ALL EXPOSED _ SURFACES P.L. ALL EXPOSED _ P.L. SKIRT-UNDER CABINET LIGHTING - _ COORDINATE W/ ELECTRICAL P.L. ALL EXPOSED _ SURFACES <u>W1</u> <u>W4</u> <u>W3</u> <u>W2</u> <u>W3</u> Wall Cabinet Wall Cabinet Wall Cabinet Wall Cabinet Wall Cabinet

Millwork General Notes:

- 1. MILLWORK TO BE USED AS BASIS OF DESIGN.
- CONTRACTOR TO SUBMIT SHOP DRAWINGS FOR ALL MILLWORK TO TENANT FOR COORDINATION AND FINAL APPROVAL.

3. MILLWORK DIMENSIONS ARE MEASURED FROM FACE OF FINISH SURFACE

- 4.PROVIDE BLOCKING IN WALLS FOR MILLWORK AS NEEDED
- 5. PROVIDE HAFELE PULL CUBE (H1935), ALUMINUM, 5" DOOR PULLS.

6. P.L. SKIRT BELOW UPPER CABINETS ON ALL EXPOSED SIDES OF CABINETS (I.E.- BREAK ROOM SINK).

NOTE: COORDINATE EQUIPMENT DIMENSIONS AND ROUGH-IN REQUIREMENTS WITH OWNER.

ARCHITECTURE

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SEAL:

PROJECT TITLE:

FICE RENOVATION
117 Thomasville Road

JOB NO.: 24.121

DESIGNED: BD

DRAWN: MP

CHECKED: BD/ML

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Millwork Sections

SHEET NO.:

A7.6

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