

DEMOLITION PLAN SHEET NOTES

- REFER TO DEMOLITION DOCUMENTS FROM ALL DISCIPLINES.
 REFER TO SPECIFICATIONS FOR ADDITIONAL DEMOLITION REQUIREMENTS.
 REMOVE NON ASBESTOS CONTAINING MATERIAL PRIOR TO ABATEMENT WHERE THERE IS NO POTENTIAL FOR DISTURBANCE OF ASBESTOS:
- A. CEILING TILES
 B. HVAC COMPONENTS
 C. LIGHT FIXTURES
- D. DOORS
 E. FURNITURE
 F. NON-ACM FLOORING MA
- F. NON-ACM FLOORING MATERIAL

 4. REFER TO ASBESTOS ABATEMENT REPORT BY MIHIR ENVIRONICS INC. AND ABATE ALL ASBESTOS CONTAINING MATERIALS AS INDICATED INCLUDING:

 A. FLOORING MATERIAL AND MASTIC
- B. PIPE FITTINGS INSULATIONC. SPRAY APPLIED FIREPROOFING MATERIAL AT INTERIOR WALLS AND COLUMNSD. HVAC DUCT INSULATION WITH BLACK MASTIC
- E. TRANSIT PIPE (EXHAUST DUCT)
 F. UNDER SINK COATING
 G. TRANSIT PANELS (FUME HOOD)
- H. CHALKBOARDS
- I. LAB COUNTER TOPS
 J. COOLER INSULATION
- COOLER INSULATION
 COORDINATE DEMOLITION WORK AND REQUIRED SHUTDOWNS WITH OWNER, PROVIDE 72 HOURS NOTIFICATION MINIMUM.
- PROVIDE CONSTRUCTION BARRIERS PRIOR TO DEMOLITION. COORDINATE WITH OWNER AND ARCHITECT.
 RESTORE ANY DISTURBANCE OR DAMAGE TO EXISTING FACILITY UTILITIES
- RESULTING DIRECTLY OR INDIRECTLY FROM THE OPERATION OF THIS CONTRACT.

 8. MAINTAIN THE EXISTING FIRE ALARM SYSTEM OPERATIONAL FOR SPACES TO REMAIN DURING DEMOLITION.
- MAINTAIN ACCESS TO AND FROM EXISTING EMERGENCY EGRESSES AND FIRE LANES.
 COORDINATE MATERIAL AND EQUIPMENT SALVAGE WITH OWNER. DISPOSE OF REMAINING MATERIAL AND EQUIPMENT.

11. PRIOR TO BID, VISIT THE SITE TO SURVEY THE EXTENT OF REMOVAL REQUIRED.

- 12. CONDUCT EXPLORATORY INVESTIGATION INTO AREAS SCHEDULED FOR DEMOLITION PRIOR TO REMOVAL AND CONTACT OWNER AND ARCHITECT IMMEDIATELY IF
- HAZARDOUS MATERIALS ARE UNCOVERED.

 13. REPAIR EXISTING FIRE RATED ASSEMBLIES, WHETHER DAMAGED THROUGH THIS PROJECT'S WORK OR DISCOVERED PREVIOUSLY DAMAGED, TO PROVIDE RATING
- INDICATED.

 14. REMOVE ELEMENTS AS INDICATED. TYPICAL WALL REMOVAL INCLUDES FINISHES AND MECHANICAL, PLUMBING, AND ELECTRICAL SYSTEMS WITHIN THE WALL. REMOVE DOORS, CASEWORK, WINDOWS, FRAMES, AND FIXTURES. REMOVE MECHANICAL,
- 15. REMOVE ALL LOOSE FURNITURE, WHITEBOARDS, PROJECTION SCREENS AND BLINDS.16. REMOVE ALL CASEWORK AS INDICATED.

ELECTRICAL, AND PLUMBING ELEMENTS INDICATED.

- 17. PATCH EXISTING SURFACES WHERE ELEMENTS ARE REMOVED.
 18. CUT AND PATCH EXISTING WALLS AS REQUIRED TO INSTALL NEW MECHANICAL, ELECTRICAL, AND PLUMBING ELEMENTS INDICATED.
- 19. CUT AND PATCH EXISTING FLOORS AS REQUIRED TO INSTALL NEW MECHANICAL, ELECTRICAL, AND PLUMBING ELEMENTS INDICATED.
- 20. TREATMENT OF EXISTING FLOORS AND WALL BASE:

 A. REMOVE EXISTING FINISH FLOORING AND WALL BASE IN AREAS SHOWN TO RECEIVE NEW FINISH FLOORING AND WALL BALL BASE.
- B. PATCH AND FLOAT EXISTING FLOORS LEVEL TO RECEIVE NEW FINISH
 21. TREATMENT OF EXISTING WALLS AND CEILINGS:
 A. REMOVE EXISTING SIGNS, VISUAL DISPLAY BOARDS, WALL COVERINGS, AND
- OTHER ITEMS AND FINISHES ATTACHED TO EXISTING TO REMAIN SURFACES.

 B. PREPARE SURFACES TO RECEIVE NEW FINISH INDICATED
- 22. DO NOT REMOVE EXISTING PLASTER FINISH ON INSIDE FACE OF EXTERIOR WALLS. PATCH FLUSH WHERE INTERSECTING WALLS OR OTHER ELEMENTS ARE REMOVED.23. ABATE PLASTER WRAPS ON BUILDING COLUMNS.

TYPICAL PHASING GRAPHICS

EXISTING CONSTRUCTION TO REMAIN

EXISTING CONSTRUCTION TO BE REMOVED

NOT IN PROJECT

SCOPE

NEW CONSTRUCTION

- D02 REMOVE FUME HOOD. REFER TO ASBESTOS ABATEMENT REPORT FOR
- FUME HOOD TRANSITE PANELS TO BE ABATED.

 D03 REMOVE CHECKER PLATE AND INFILL STRUCTURAL FLOOR.
- D04 REMOVE COOLER, INFILL 2" FLOOR TO LEVEL. ABATE COOLER INSULATION MASTIC, REFER TO ASBESTOS ABATEMENT REPORT D05 REMOVE AUTOCLAVE.
- D06 REMOVE METAL COLUMN ANCHORS AT CMU WALL.

 D07 REMOVE METAL SHIELDING AT WALLS CEILINGS AND F
- D07 REMOVE METAL SHIELDING AT WALLS, CEILINGS, AND FLOOR.
 D08 REMOVE EYEWASH AND EMERGENCY SHOWER.
- OWNER TO REMOVE ART INSTALLTION.
 REMOVE PLUMBING FIXTURE.
- D12 REMOVE WINDOW GUARD.

KEYNOTE LEGEND

- D13 REMOVE ALL FIXTURES, STALL DIVIDERS, AND FLOOR AND WALL FINISHES. PREP SURFACES FOR NEW TILE FINISHES.

 D14 FIELD VERIFY IF SHIELDING IS PRESENT. REMOVE METAL SHIELDING
- FROM ALL SURFACES IF PRESENT.

 D15 ABATE FLOOR TILE AND MASTIC.
- ABATE SHEETING FLOOR AND MASTIC.

 ABATE CARPET AND MASTIC.
- D18 REMOVE NON-ACM FLOORING PRIOR TO START OF ASBESTOS ABATEMENT.
- D19 ABATE PIPE INSULATION AND DEBRIS UNDER SINK AND CABINETS.
 D20 ABATE LAB COUNTER TOP AND SINK IF APPLICABLE.
- D21 REMOVE TOILET CARRIERS TO ACCOMMODATE NEW PLAN.
 D22 REMOVE MASONRY WALL FULL HEIGHT.
- D23 REMOVE MASONRY WALL FOR INSTALLATION OF NEW DOOR, PROVIDE
- D24 REMOVE WINDOW DURING MAIN PROJECT, DETAILS WILL BE PROVIDED IN MAIN PROJECT SET.

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BMITTAL: ISSUE DATE:

DESCRIPTION

07/23/2024

DATE

50% CONSTRUCTION DOCUMENTS

REVISION

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ONE TEACHING
LABS

FLORIDA STATE UNIVERSITY 89 CHIEFTAN WAY, TALLAHASSEE, FL 32306

KEY PLAN



WING TITLE:

LEVEL 2 DEMOLITION

PLAN

PROJECT NO.: 23055-00 DRAWN BY: AS

AD102



DEMOLITION PLAN SHEET NOTES

1. REFER TO DEMOLITION DOCUMENTS FROM ALL DISCIPLINES.

2. REFER TO SPECIFICATIONS FOR ADDITIONAL DEMOLITION REQUIREMENTS. 3. REMOVE NON ASBESTOS CONTAINING MATERIAL PRIOR TO ABATEMENT WHERE THERE IS NO POTENTIAL FOR DISTURBANCE OF ASBESTOS:

A. CEILING TILES B. HVAC COMPONENTS

C. LIGHT FIXTURES

D. DOORS E. FURNITURE

F. NON-ACM FLOORING MATERIAL 4. REFER TO ASBESTOS ABATEMENT REPORT BY MIHIR ENVIRONICS INC. AND ABATE ALL ASBESTOS CONTAINING MATERIALS AS INDICATED INCLUDING:

A. FLOORING MATERIAL AND MASTIC B. PIPE FITTINGS INSULATION

C. SPRAY APPLIED FIREPROOFING MATERIAL AT INTERIOR WALLS AND COLUMNS D. HVAC DUCT INSULATION WITH BLACK MASTIC

E. TRANSIT PIPE (EXHAUST DUCT)

F. UNDER SINK COATING G. TRANSIT PANELS (FUME HOOD)

H. CHALKBOARDS I. LAB COUNTER TOPS

J. COOLER INSULATION 5. COORDINATE DEMOLITION WORK AND REQUIRED SHUTDOWNS WITH OWNER,

PROVIDE 72 HOURS NOTIFICATION MINIMUM. 6. PROVIDE CONSTRUCTION BARRIERS PRIOR TO DEMOLITION. COORDINATE WITH OWNER AND ARCHITECT.

7. RESTORE ANY DISTURBANCE OR DAMAGE TO EXISTING FACILITY UTILITIES RESULTING DIRECTLY OR INDIRECTLY FROM THE OPERATION OF THIS CONTRACT.

8. MAINTAIN THE EXISTING FIRE ALARM SYSTEM OPERATIONAL FOR SPACES TO REMAIN DURING DEMOLITION. 9. MAINTAIN ACCESS TO AND FROM EXISTING EMERGENCY EGRESSES AND FIRE LANES.

10. COORDINATE MATERIAL AND EQUIPMENT SALVAGE WITH OWNER. DISPOSE OF REMAINING MATERIAL AND EQUIPMENT. 11. PRIOR TO BID, VISIT THE SITE TO SURVEY THE EXTENT OF REMOVAL REQUIRED.

12. CONDUCT EXPLORATORY INVESTIGATION INTO AREAS SCHEDULED FOR DEMOLITION PRIOR TO REMOVAL AND CONTACT OWNER AND ARCHITECT IMMEDIATELY IF HAZARDOUS MATERIALS ARE UNCOVERED.

13. REPAIR EXISTING FIRE RATED ASSEMBLIES, WHETHER DAMAGED THROUGH THIS PROJECT'S WORK OR DISCOVERED PREVIOUSLY DAMAGED, TO PROVIDE RATING 14. REMOVE ELEMENTS AS INDICATED. TYPICAL WALL REMOVAL INCLUDES FINISHES AND MECHANICAL, PLUMBING, AND ELECTRICAL SYSTEMS WITHIN THE WALL. REMOVE

DOORS, CASEWORK, WINDOWS, FRAMES, AND FIXTURES. REMOVE MECHANICAL,

ELECTRICAL, AND PLUMBING ELEMENTS INDICATED. 15. REMOVE ALL LOOSE FURNITURE, WHITEBOARDS, PROJECTION SCREENS AND BLINDS. 16. REMOVE ALL CASEWORK AS INDICATED.

17. PATCH EXISTING SURFACES WHERE ELEMENTS ARE REMOVED. 18. CUT AND PATCH EXISTING WALLS AS REQUIRED TO INSTALL NEW MECHANICAL,

ELECTRICAL, AND PLUMBING ELEMENTS INDICATED. 19. CUT AND PATCH EXISTING FLOORS AS REQUIRED TO INSTALL NEW MECHANICAL, ELECTRICAL, AND PLUMBING ELEMENTS INDICATED.

20. TREATMENT OF EXISTING FLOORS AND WALL BASE: A. REMOVE EXISTING FINISH FLOORING AND WALL BASE IN AREAS SHOWN TO RECEIVE NEW FINISH FLOORING AND WALL BALL BASE.

B. PATCH AND FLOAT EXISTING FLOORS LEVEL TO RECEIVE NEW FINISH 21. TREATMENT OF EXISTING WALLS AND CEILINGS:

A. REMOVE EXISTING SIGNS, VISUAL DISPLAY BOARDS, WALL COVERINGS, AND OTHER ITEMS AND FINISHES ATTACHED TO EXISTING TO REMAIN SURFACES. B. PREPARE SURFACES TO RECEIVE NEW FINISH INDICATED

22. DO NOT REMOVE EXISTING PLASTER FINISH ON INSIDE FACE OF EXTERIOR WALLS. PATCH FLUSH WHERE INTERSECTING WALLS OR OTHER ELEMENTS ARE REMOVED. 23. ABATE PLASTER WRAPS ON BUILDING COLUMNS.

CEILING DEMOLITION LEGEND

REMOVE AREA OF CEILING FOR PLUMBING DEMOLITION. REFER TO PLUMBING DEMOLITION PLAN. PROVIDE NEW CEILING AND GRID AS REQUIRED IF EXISTING CEILING IS DAMAGED. MATCH EXISTING TYPE AND HEIGHT.

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KEY PLAN

LEVEL 1 CEILING **DEMOLITION PLAN**



EXISTING CONSTRUCTION TO REMAIN

EXISTING CONSTRUCTION TO BE REMOVED

NEW CONSTRUCTION

NOT IN PROJECT

KEYNOTE LEGEND

SCOPE

D01 REMOVE EXISTING GUARD AND HANDRAILS AT STAIR.
EXISTING STAIR AND FINISHES TO REMAIN, PROTECT
DURING DEMOLITION AND INSTALLATION OF NEW GUARD
AND HANDRAILS.

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KEY PLAN

PRAWING TITLE:

LEVEL 1 FLOOR PLAN AND DEMOLITION PLAN

PROJECT NO.: 23055-00 DRAWN BY: KAL
CHECKED BY: JMO

KEYNOTE LEGEND

101 INSTALL WINDOW GUARD.102 COMMUNITY WASTE STATION.

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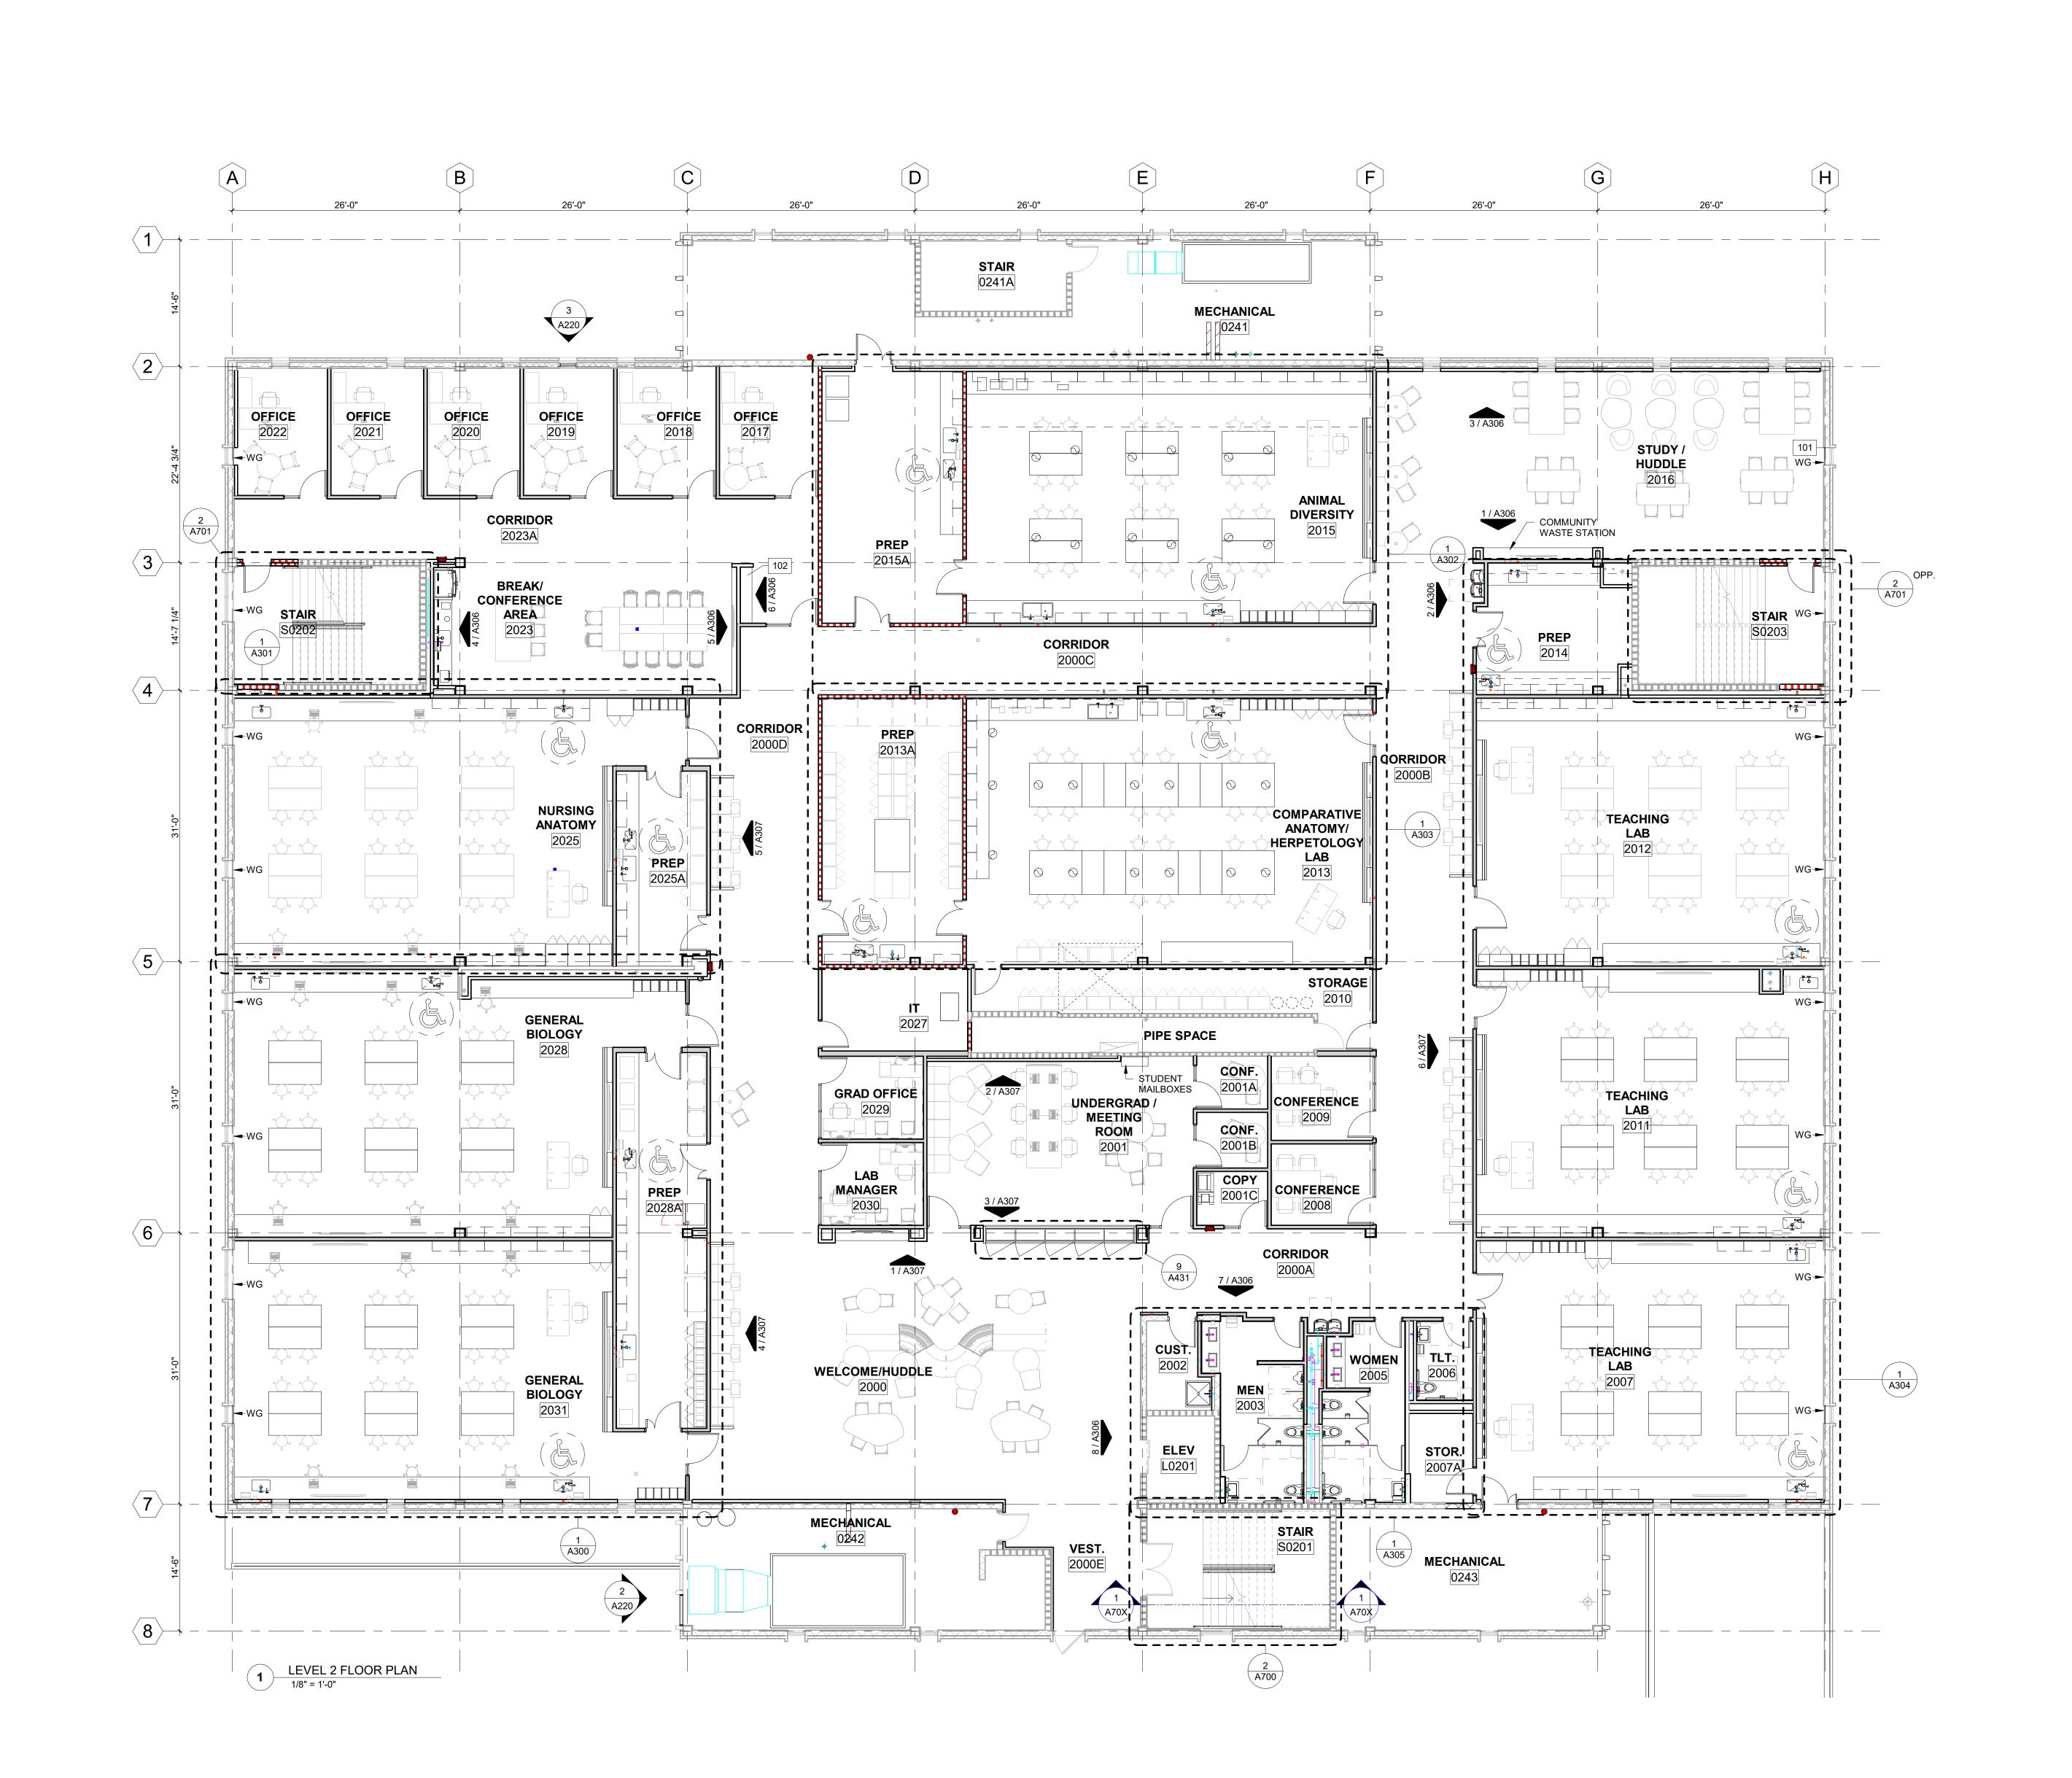
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KEY PLAN

DRAWING TITLE:

LEVEL 2 FLOOR PLAN

PROJECT NO.: 23055-00 DRAWN BY: KAL
CHECKED BY: JMO





PARTITION PLAN SHEET NOTES

- SEE WALL SECTIONS FOR EXTERIOR WALL ASSEMBLY INFORMATION.
 INTERIOR PARTITIONS ARE TYPE A3D UNLESS OTHERWISE INDICATED.
 PROVIDE HEADERS TO STRUCTURE ABOVE AT INTERIOR STOREFRONT
- PARTITIONS.

 4. PROVIDE IN WALL BACKING FOR WALL MOUNTED ITEMS.

 5. PARTITIONS NOT DIMENSIONED ARE GENERALLY LOCATED BY ONE OF
- THE FOLLOWING CRITERIA:

 A. CENTERLINE CENTER OF PARTITION ALIGNS WITH A STRUCTURAL GRIDLINE OR OBJECT CENTERLINE (SUCH AS WINDOW MULLION OR
- B. ALIGN LOCATE PARTITION FLUSH WITH FACE OF GYPSUM BOARD OR
 OTHER SURFACE INDICATED
 C. MAINTAIN DIMENSIONS NOTED AS "MINIMUM" OR "CLEAR"
- C. MAINTAIN DIMENSIONS NOTED AS "MINIMUM" OR "CLEAR"
 6. PROVIDE MINIMUM 1'-0" CLEAR AT PUSH SIDES OF DOORS AND 1'-6" CLEAR AT PULL SIDES OF DOORS UNLESS INDICATED OTHERWISE.
- CLEAR AT PULL SIDES OF DOORS UNLESS INDICATED OTHERWISE.

 7. MOUNT SINKS AND LAVATORIES WITH A MINIMUM OF 1'-3" FROM THE CENTERLINE OF THE FIXTURE TO THE FINISH SURFACE OF ADJACENT
- 8. WALL PRIORITY: WHERE RATED PARTITIONS INTERSECT OTHER RATED PARTITIONS OR UNRATED PARTITIONS, CONSTRUCT HIGHER RATED PARTITION CONTINUOUS AND ABUT THE LOWER RATED OR UNRATED PARTITION TO THE HIGHER RATED PARTITION.
- MAINTAIN FIRE RATING INDICATED FOR EXISTING PARTITIONS.
 WHERE NEW PARTITIONS EXTEND OR ABUT EXISTING PARTITIONS, ALIGN THE FINISH FACE OF THE NEW PARTITION WITH THE EXISTING PARTITION AND PROVIDE A TRANSITION WITHOUT VISIBLE SEAMS OR JOINTS.
 PROVIDE COMMUNICATIONS ROOM BOARD ON ALL WALLS OF IT 2027.
- 11. PROVIDE COMMUNICATIONS ROOM BOARD ON ALL WALLS OF IT 2027. SEE 06 1000. 3/4" THICK AC GRADE PLYWOOD, 8' X 4' PANELS TRIMMED TO FIT WALL LENGTH. MOUNT WITH BOTTOM OF PANEL AT TOP OF WALL BASE. TOP OF PANEL AT 8'-4". INSTALL SMOOTH SIDE OUT. THE PLYWOOD SHALL BE VOID FREE AND PAINTED FRONT, BACK, AND EDGES PRIOR TO INSTALLATION. MOUNT ON TOP OF GYPSUM BOARD, NOT IN LIEU OF GYPSUM BOARD.

KEYNOTE LEGEND

WALLS.

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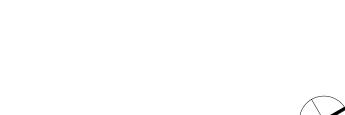
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KEY PLAN



DRAWING TITLE:

LEVEL 2 PARTITION PLAN

PROJECT NO.: 23055-00 DRAWN BY:

СНЕСКЕД ВҮ: **А122**



CEILING PLAN SHEET NOTES

- CEILING ELEMENTS (LIGHTS, GRILLS, ETC...) SHOWN FOR LOCATION AND COORDINATION.
 COORDINATE LOCATION, SIZE, AND REQUIREMENTS OF CEILING ELEMENTS WITH M/E/P/F DOCUMENTS.
 SUSPENDED TILE CEILING GRIDS SHALL BE SET WITH EITHER A FULL TILE OR A GRID INTERSECTION OCCURRING AT THE CENTER OF THE CEILING EXPANSE SO
- GRID INTERSECTION OCCURRING AT THE CENTER OF THE CEILING EXPANSE SO AS TO ACHIEVE TILES OF EQUAL WIDTH AT OPPOSING SIDES OF THE CEILING. NO CEILING GRID CONFIGURATION SHALL RESULT IN A TILE AT ANY PERIMETER EDGE OF LESS THAN 4 INCHES IN WIDTH.
- IMMEDIATELY BRING DISCREPANCIES TO THE ARCHITECT'S ATTENTION.
 IN ACOUSTICAL PANEL CEILINGS, CENTER CEILING ELEMENTS IN PANELS.
 IN GYPSUM WALL BOARD CEILINGS ALIGN CEILING ELEMENTS WITH ADJACENT CEILING ELEMENTS.
- 7. PROVIDE ACCESS PANELS IN NON-ACCESSIBLE CEILINGS (SUCH AS GYPSUM BOARD) WHERE REQUIRED FOR ACCESS TO SERVICEABLE MECHANICAL, ELECTRICAL, OR PLUMBING DEVICES. PROVIDE COORDINATED ACCESS PANEL LOCATION SHOP DRAWING FOR REVIEW AND APPROVAL BY ARCHITECT PRIOR TO INSTALLATION.
- 8. ACOUSTIC PANEL CEILINGS ARE APC1 AND 8'-0" AFF UNLESS OTHERWISE INDICATED.

CEILING LEGEND

CEILING TAG	711 0 1	NG FINISH HT AFF	
RECESSED DOWNLIGHTS	0	SUSPENDED CEILING GRID, SEE PLAN AND SPECIFICATIONS FOR	
1'x4', 2'x4' & 2'x2' RECESSED LIGHT FIXTURE		PANEL SIZES	
SUSPENDED LIGHT FIXTURE	\odot	GWB CEILING	
RECESSED LINEAR LIGHT FIXTURES			
HVAC TERMINALS	SUPPLY RETURN E	EXHAUST	

KEYNOTE LEGEND

107 CUT NEW OPENING ABOVE IN LEVEL 3 SLAB AND ROOF SLAB FOR DUCT PENETRATION.

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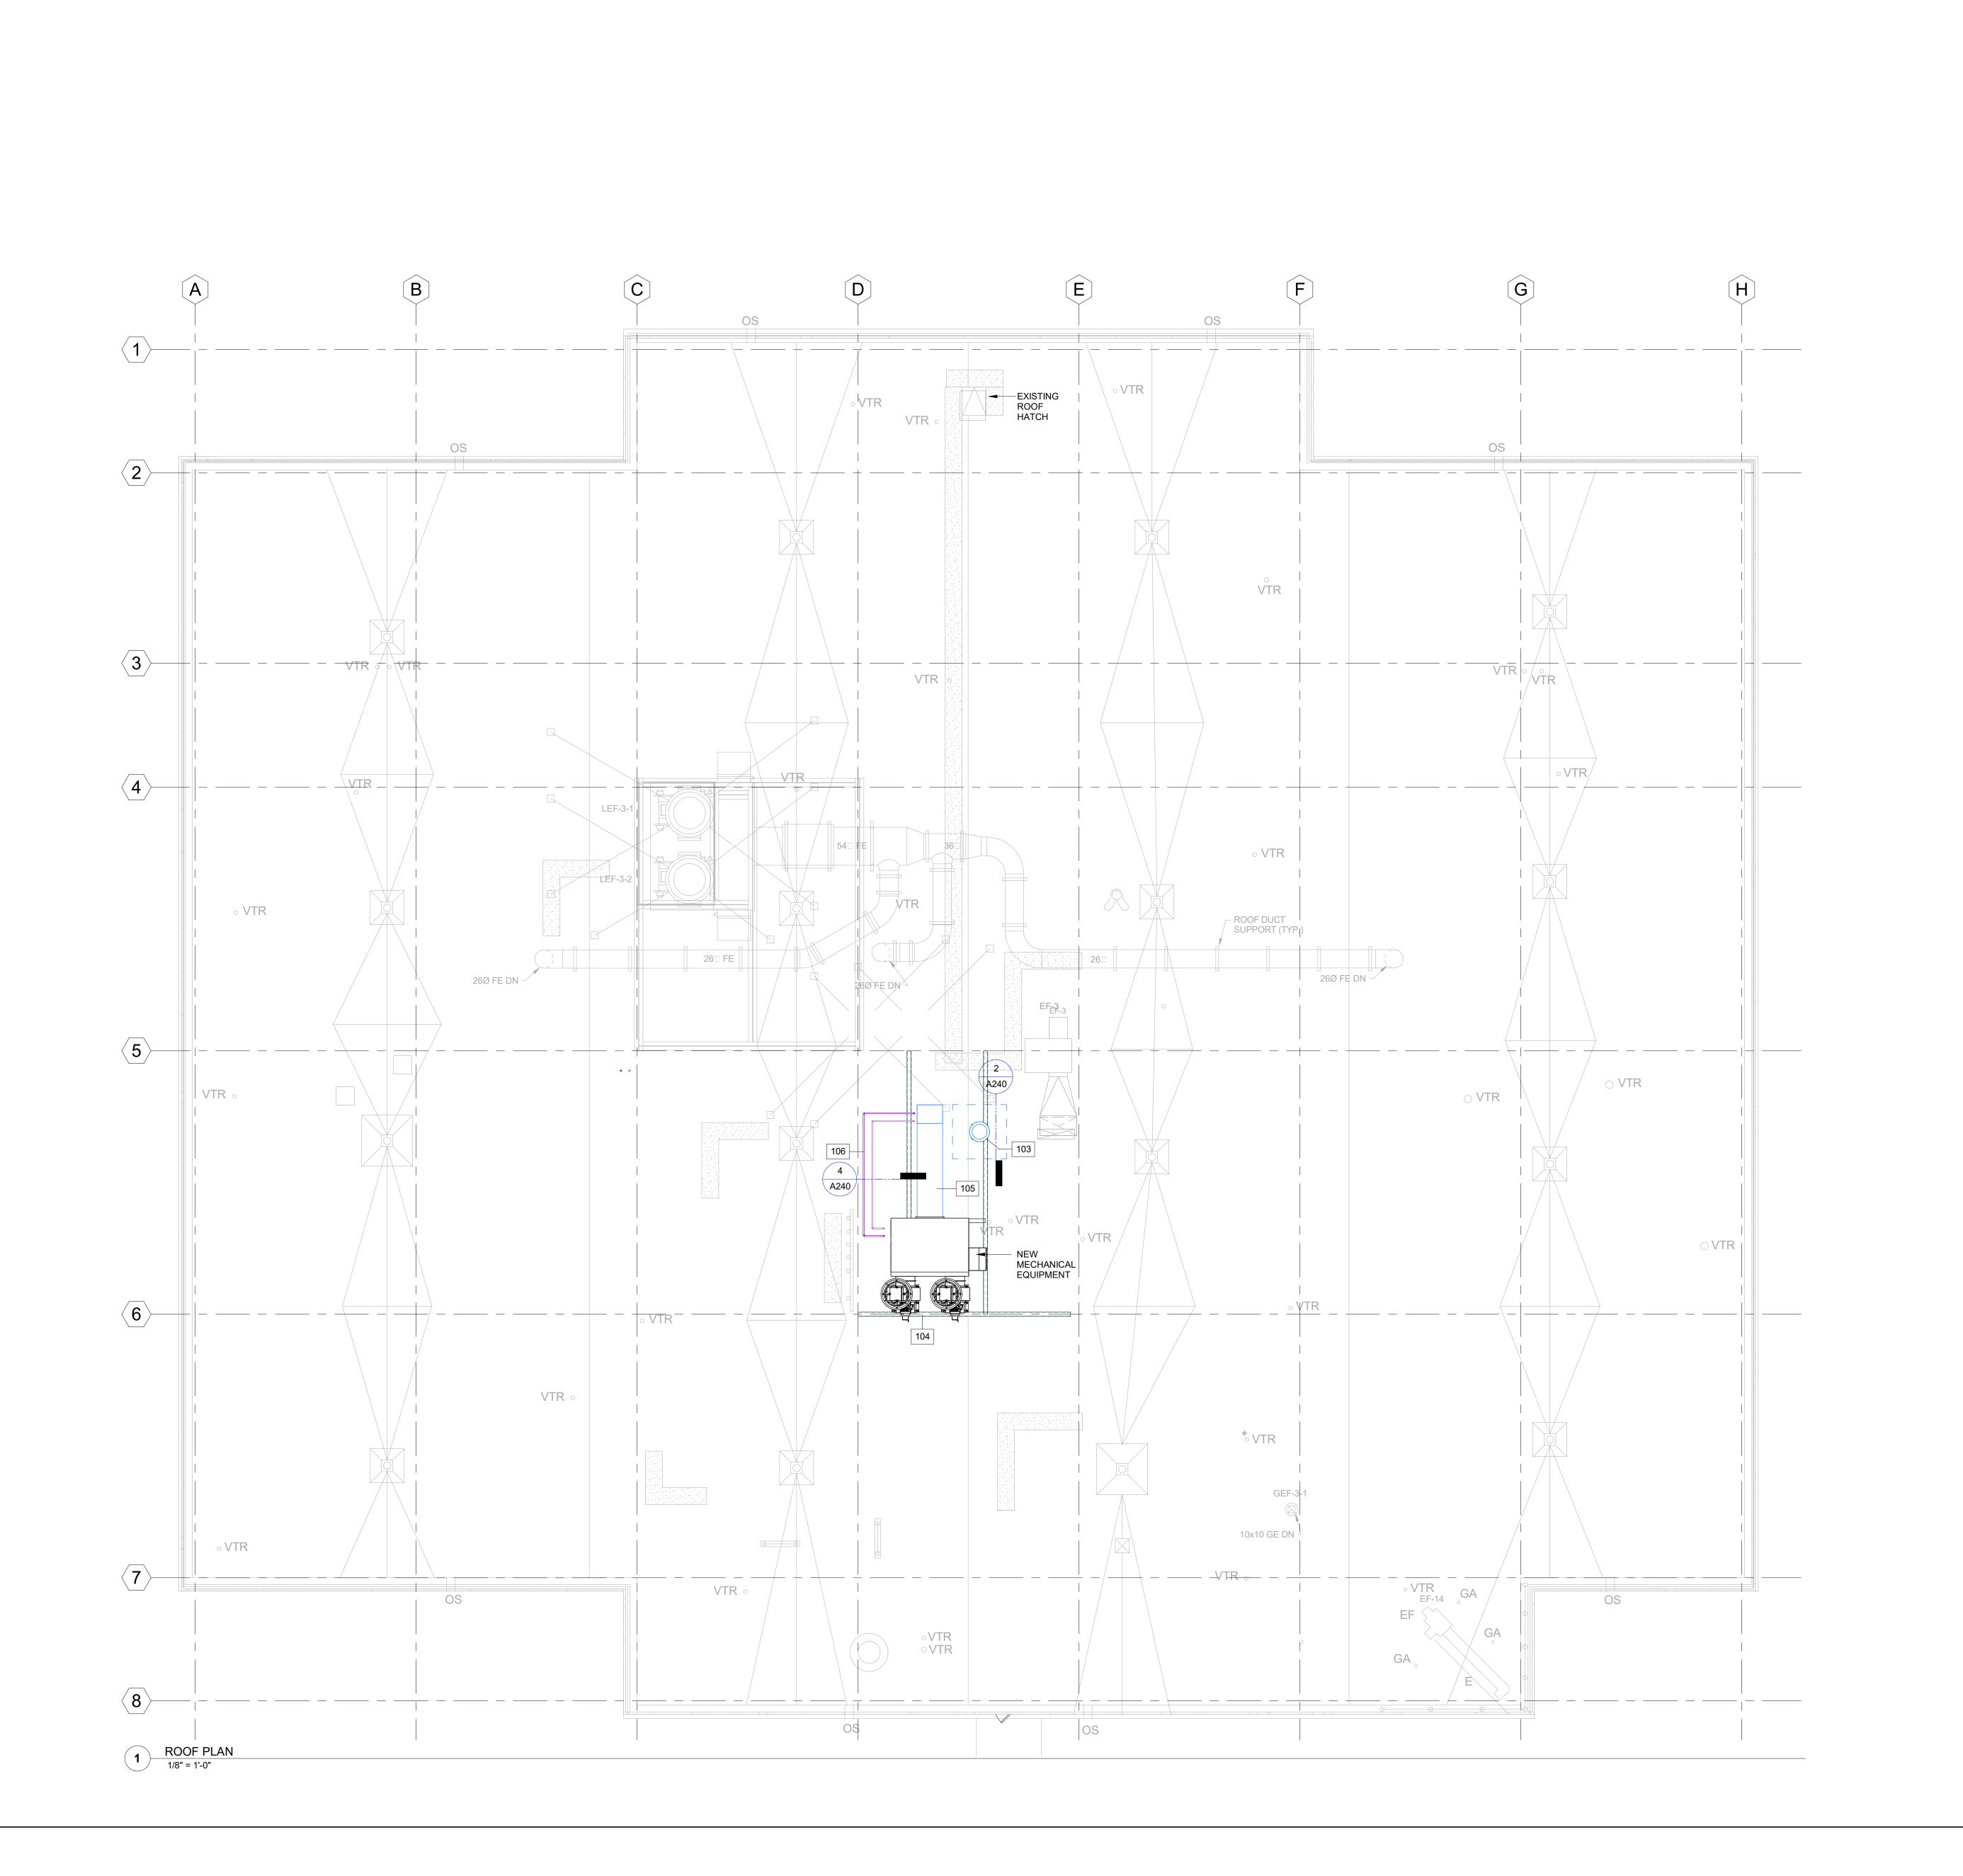
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RAWING TITLE:

LEVEL 2 CEILING PLAN

PROJECT NO.: 23055-00 DRAWN BY:

Δ132



ROOF PLAN SHEET NOTES

1. COORDINATE ALL EQUIPMENT SHOWN ON THE ROOF PLAN WITH CONSTRUCTION DOCUMENTS ASSOCIATED WITH THEIR RESPECTIVE DISCIPLINES.

KEYNOTE LEGEND

103 REMOVE PORTION OF EXISTING ROOF AS REQUIRED TO INSTALL NEW

- EXHAUST DUCT.

 4 PROVIDE CURB FOR NEW MECHANICAL EQUIPMENT.

 BOOF MOUNTED BACK FOR DUCT SUPPORT
- 105 ROOF MOUNTED RACK FOR DUCT SUPPORT.106 BLOCK SUPPORT FOR CONDENSATE PIPES.

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KEY PLAN

AWING TITLE:

ROOF PLAN

PROJECT NO.: 23055-00 DRAWN BY: AH
CHECKED BY: JMO



SLAB COORDINATION LEGEND

FLOOR BOX

o FLOOR DRAIN

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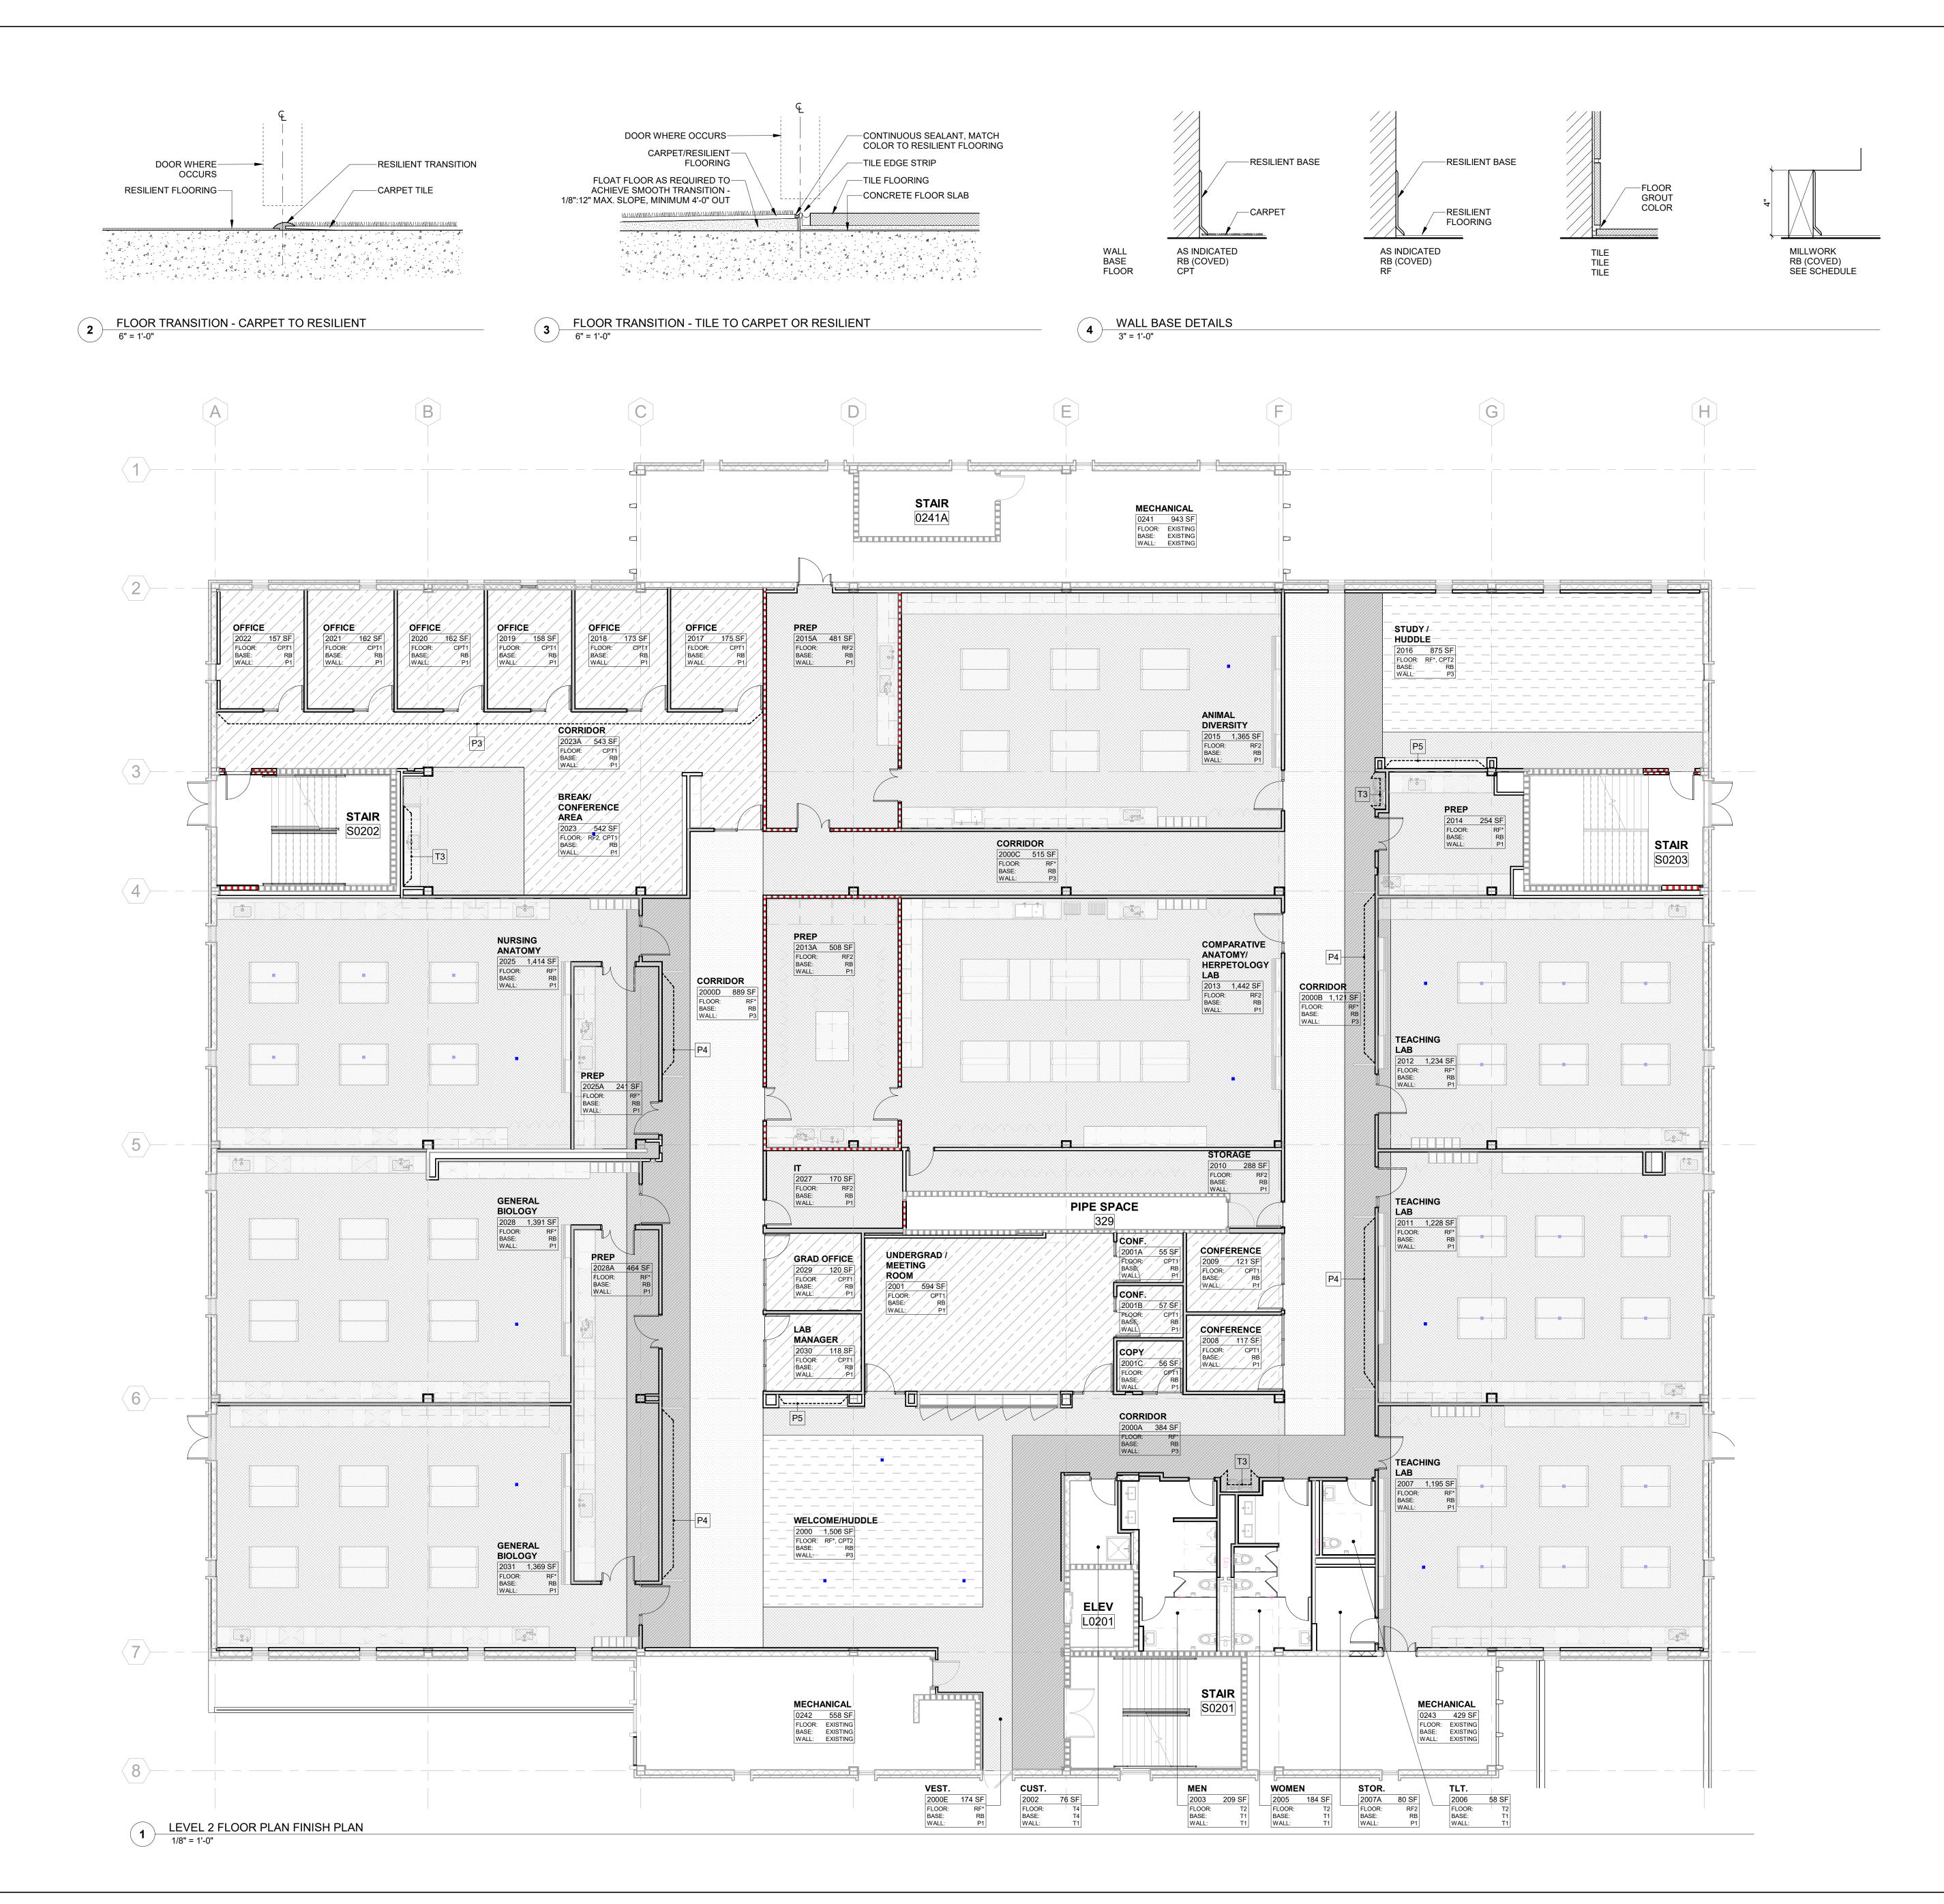
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DRAWING TITLE:

LEVEL 2 SLAB

LEVEL 2 SLAB COORDINATION PLAN

PROJECT NO.: 23055-00 DRAWN BY: AH
CHECKED BY: JMO



FINISH PLAN SHEET NOTES

1. AREAS SHOWN IN ROOM IDENTIFICATION TAGS ARE FOR REFERENCE ONLY. DO NOT USE THESE AREAS FOR TAKE-OFFS. 2. REFER TO CUTTING AND PATCHING SPECIFICATION. MATCH, PATCH, AND

EXTEND EXISTING FINISHES TO PROVIDE SEAMLESS TRANSITION BETWEEN NEW AND EXISTING. 3. PAINT ALL WALL SURFACES, DOOR FRAMES, SOFFITS, AND CEILINGS UNLESS

OTHERWISE INDICATED. 4. PAINT ALL MECHANICAL AND ELECTRICAL EQUIPMENT EXPOSED IN FINISHED SPACES UNLESS OTHERWISE INDICATED. 5. PAINT AND COATING APPLICATION SUMMARY (XXXX MATCH SHEEN AND PAINT

PRODUCT TO SPECXXXX)
A. INTERIOR CONCRETE AND CMU WALLS - I-OP (EGGSHELL LATEX)

B. INTERIOR CONCRETE AND WOOD FLOORS, PAINTED - I-OP-FL (SATIN ACRYLIC) C. INTERIOR CONCRETE FLOORS, SEALED - I-TR-C

INTERIOR GYPSUM BOARD WALLS, TYPICAL - I-OP (EGGSHELL LATEX) INTERIOR GYPSUM BOARD CEILINGS, TYPICAL - I-OP (FLAT LATEX) INTERIOR WOOD, OPAQUE - I-OP-MD-DT (SEMI-GLOSS ACRYLIC) G. INTERIOR METALS - I-OP-MD-DT (SEMI-GLOSS ACRYLIC) H. INTERIOR MEDIUM DUTY WALLS AND CEILINGS - I-OP-MD-WC (EGGSHELL

a. TOÍLET ROOMS b. KITCHENS INTERIOR OVERHEAD METALS (INCLUDING BEAMS, JOISTS, DECKING) - I-OP-

DF (EGGSHELL DRYWALL) J. INTERIOR LIGHT INDUSTRIAL COATINGS, WHERE INDICATED TO RECEIVE **EPOXY PAINT - SEE SPECIFICATION**

K. EXTERIOR CONCRETE AND CMU WALLS - E-OP (SATIN LATEX) L. EXTERIOR CEMENT PLASTER - E-OP (SATIN LATEX)

M. EXTERIOR WOOD - E-OP (LATEX, SHEEN AS SPECIFIED) N. EXTERIOR STEEL - ME-OP-3A (GLOSS ALKYD) O. EXTERIOR GALVANIZED STEEL - MgE-OP-3A (GLOSS ALKYD)

6. PAINT COLOR SUMMARY A. PAINT HOLLOW METAL DOOR FRAMES TO MATCH ADJACENT WALL. B. PAINT CEILINGS AND SOFFITS P1, UNLESS OTHERWISE INDICATED. 7. THE TRANSITION OF DIFFERENT FLOORING MATERIALS AT A DOORWAY SHALL

OCCUR AT THE CENTERLINE OF DOOR UNLESS OTHERWISE INDICATED. 8. INSTALL FLOORING WALL TO WALL IN ROOMS INDICATED TO RECEIVE NEW FLOORING. EXTEND BENEATH CASEWORK UNLESS OTHERWISE INDICATED.

9. INSTALL WATERPROOFING AND CRACK ISOLATION MEMBRANE AT ALL TILE FLOORS.

10. INSTALL NEW ROLLER WINDOW SHADE AT ALL EXTERIOR WINDOWS. 11. INSTALL CORNER GUARDS AT ALL GYPSUM WALLBOARD OUTSIDE CORNERS.

FINISH ABBREVIATIONS AND CODES

FINISH
ACOUSTIC PANEL CEILING CARPET TILE HIGH PRESSURE LAMINATE MARKERBOARD

WOOD

EPOXY). USE AT:

RESILIENT BASE RESILIENT FLOORING ROLLER WINDOW SHADE SEALED CONCRETE SCONC SSM SOLID SURFACE MATERIAL

WD





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STRUCTURAL ENGINEER

WALTER P. MOORE 201 E KENNEDY BLVD #700 TAMPA FL 33602 813.221.2424

SEAL AND SIGNATURE

ISSUE DATE: 50% CONSTRUCTION DOCUMENTS 07/23/2024 DATE DESCRIPTION


FSU BIO UNIT ONE TEACHING LABS


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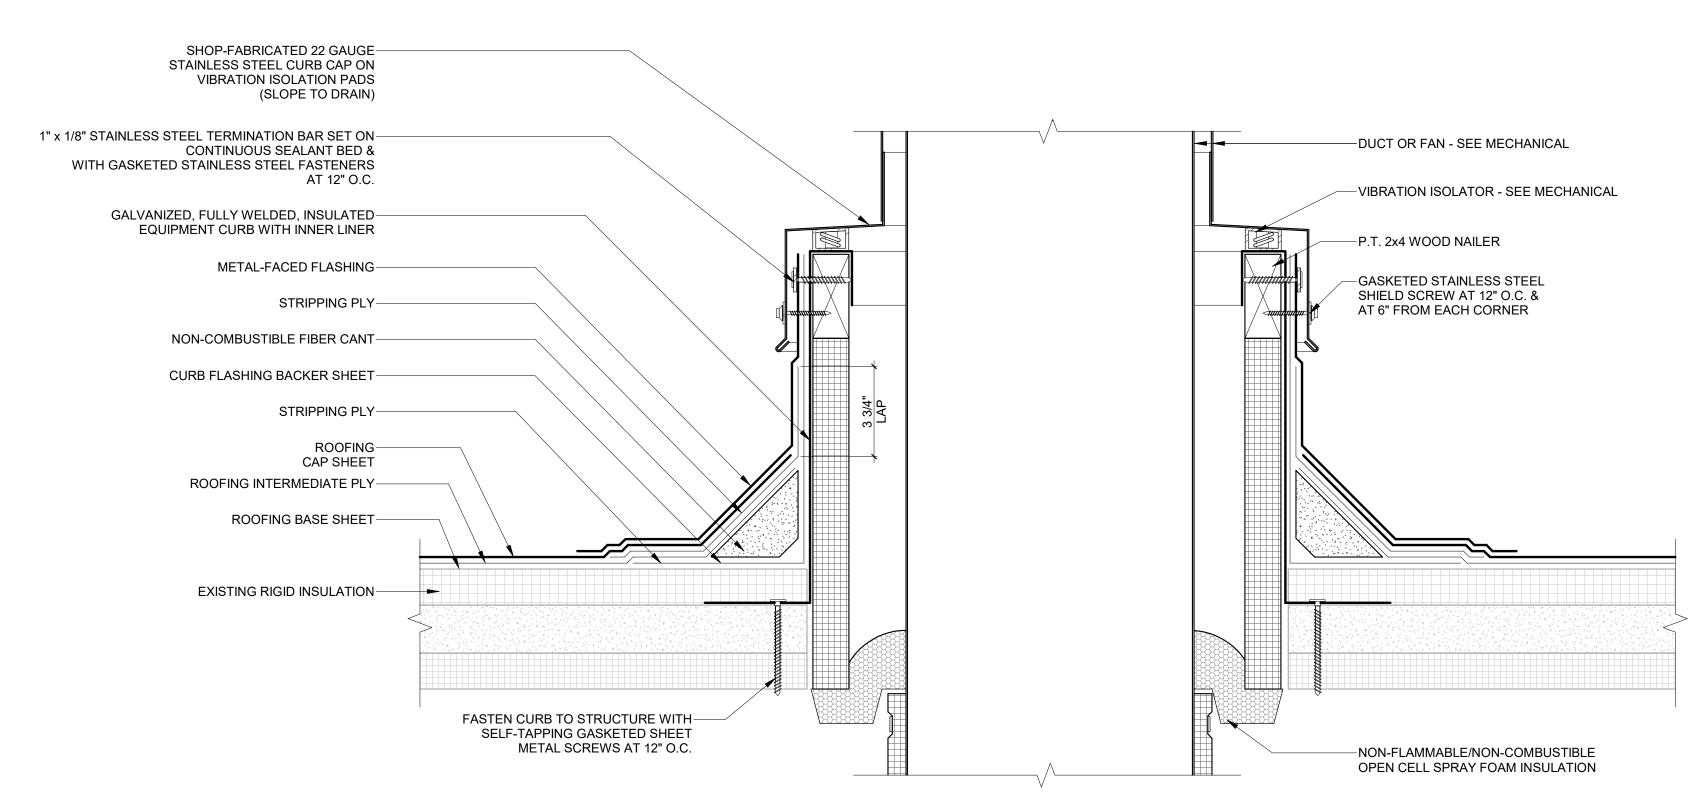


LEVEL 2 FINISH PLAN


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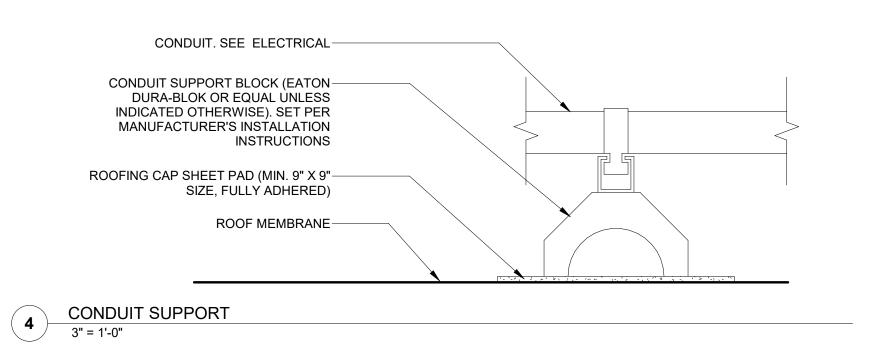




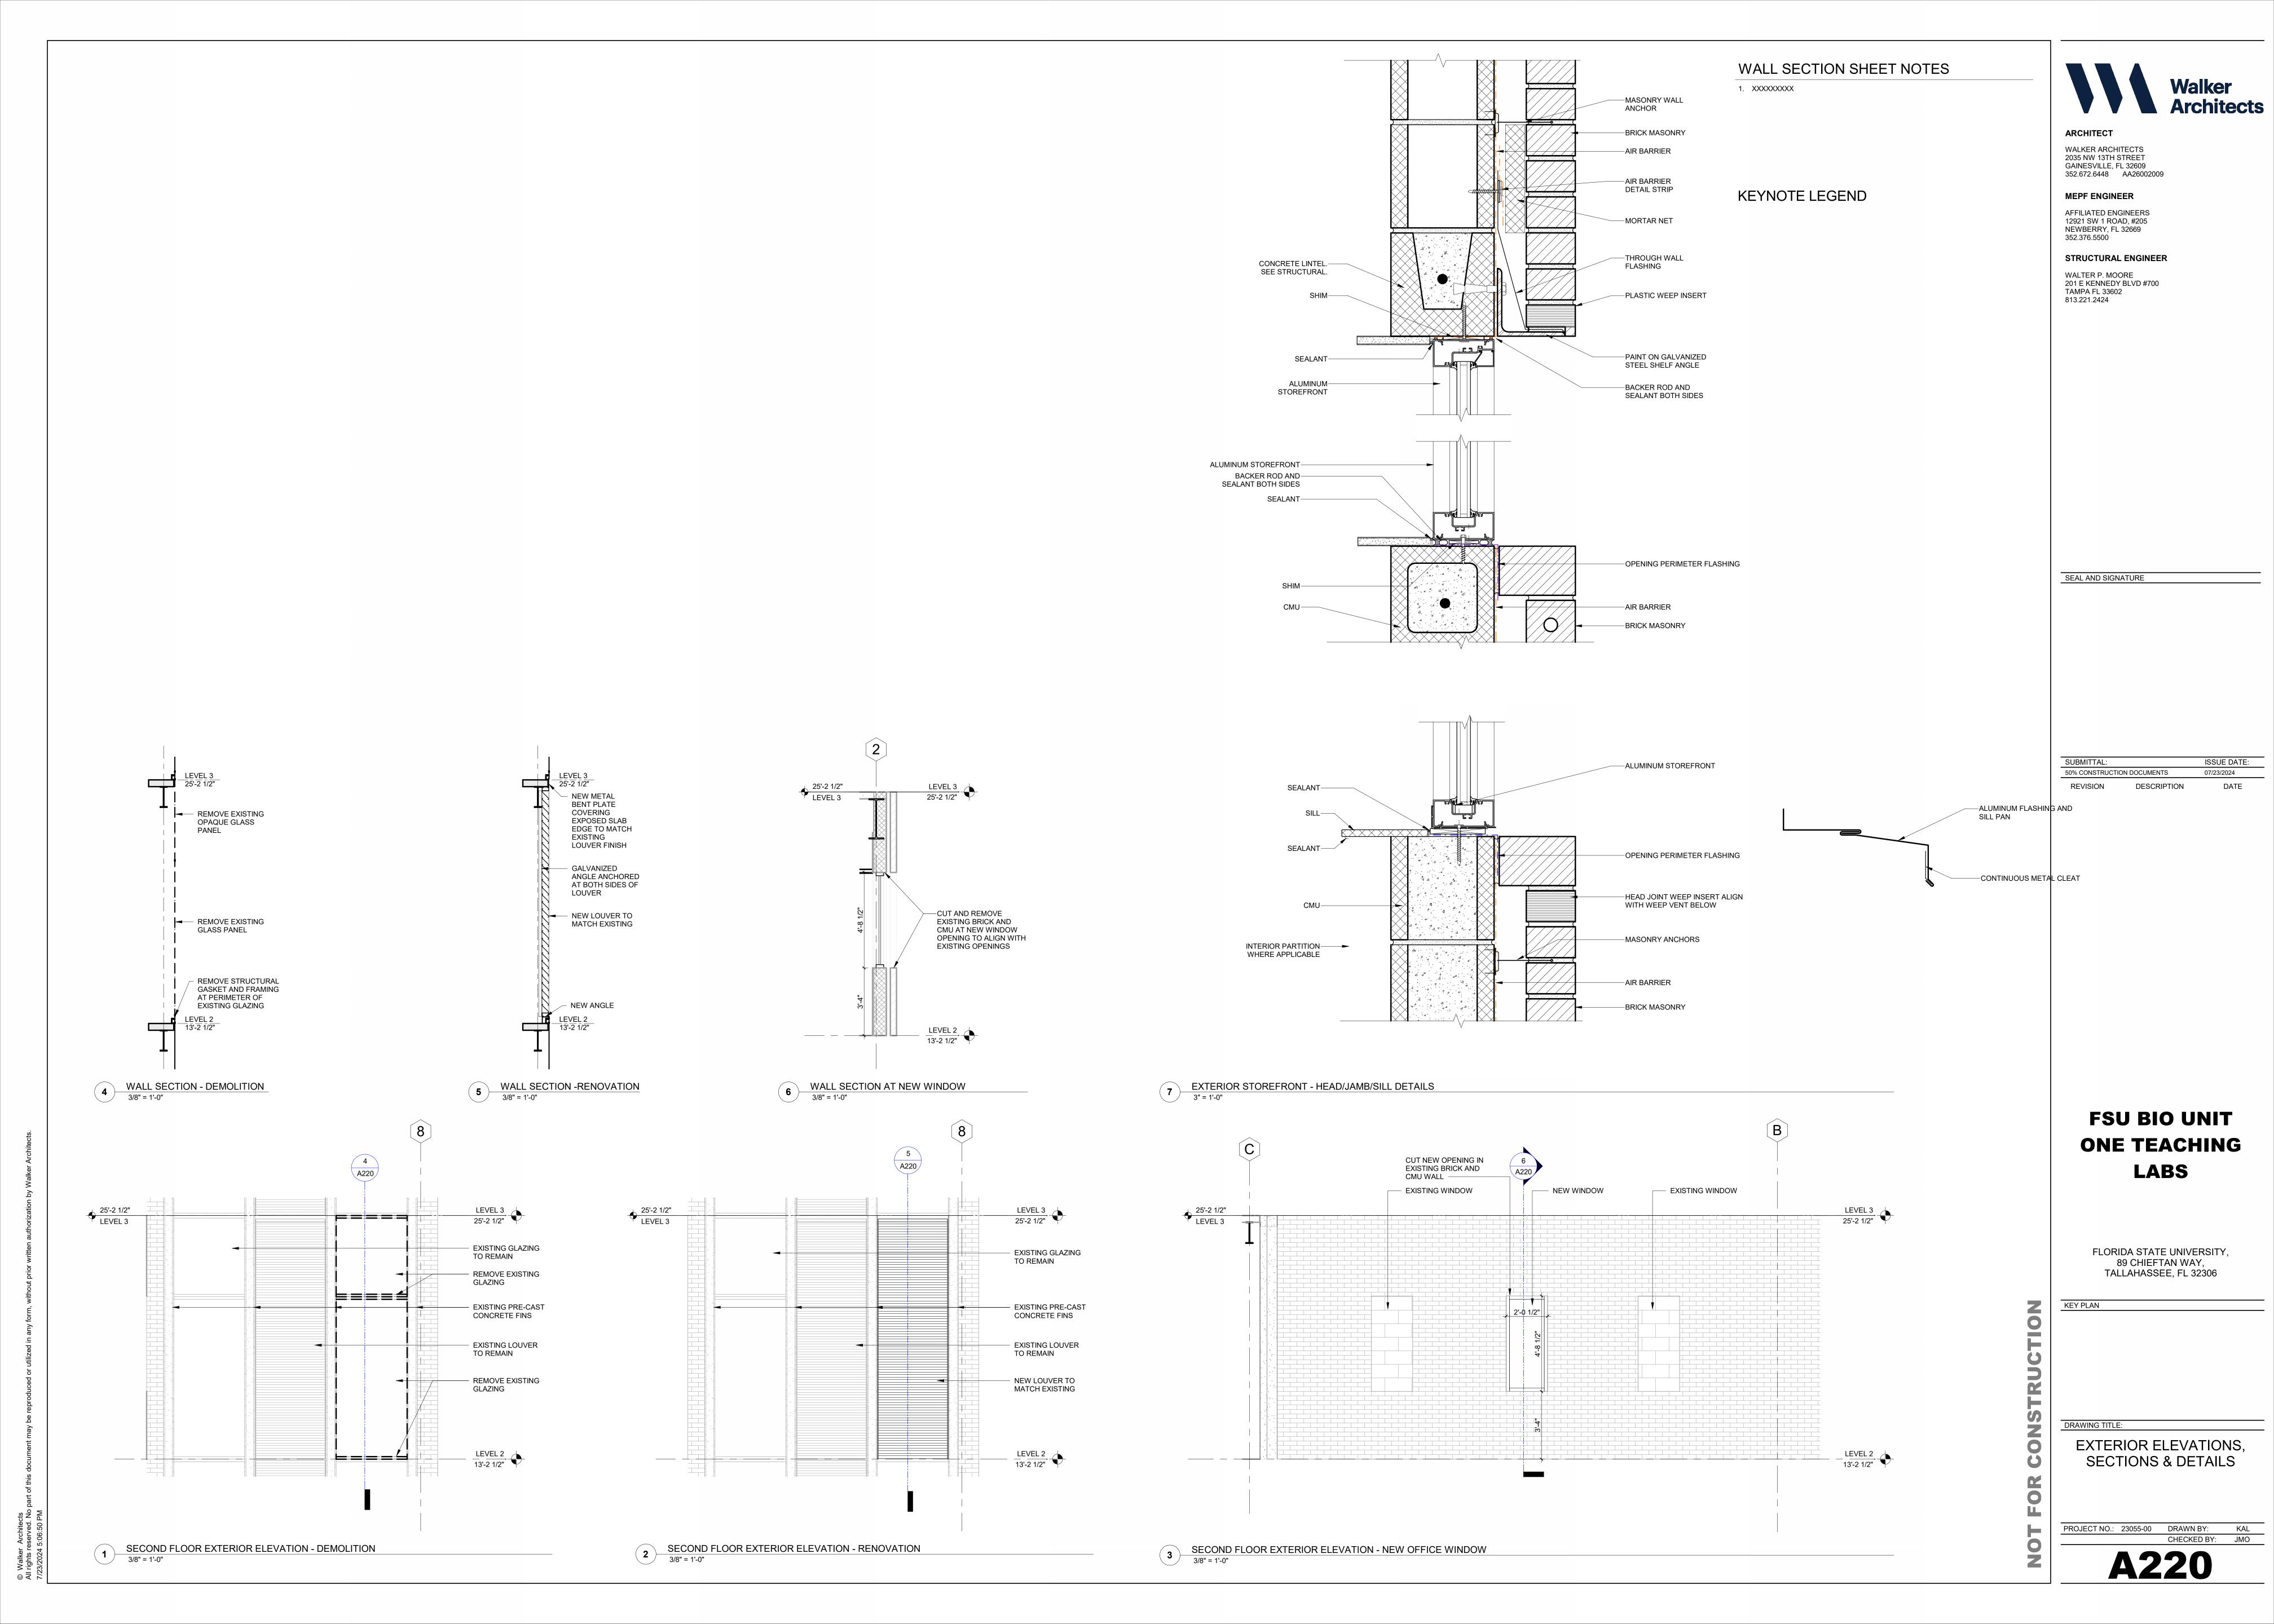

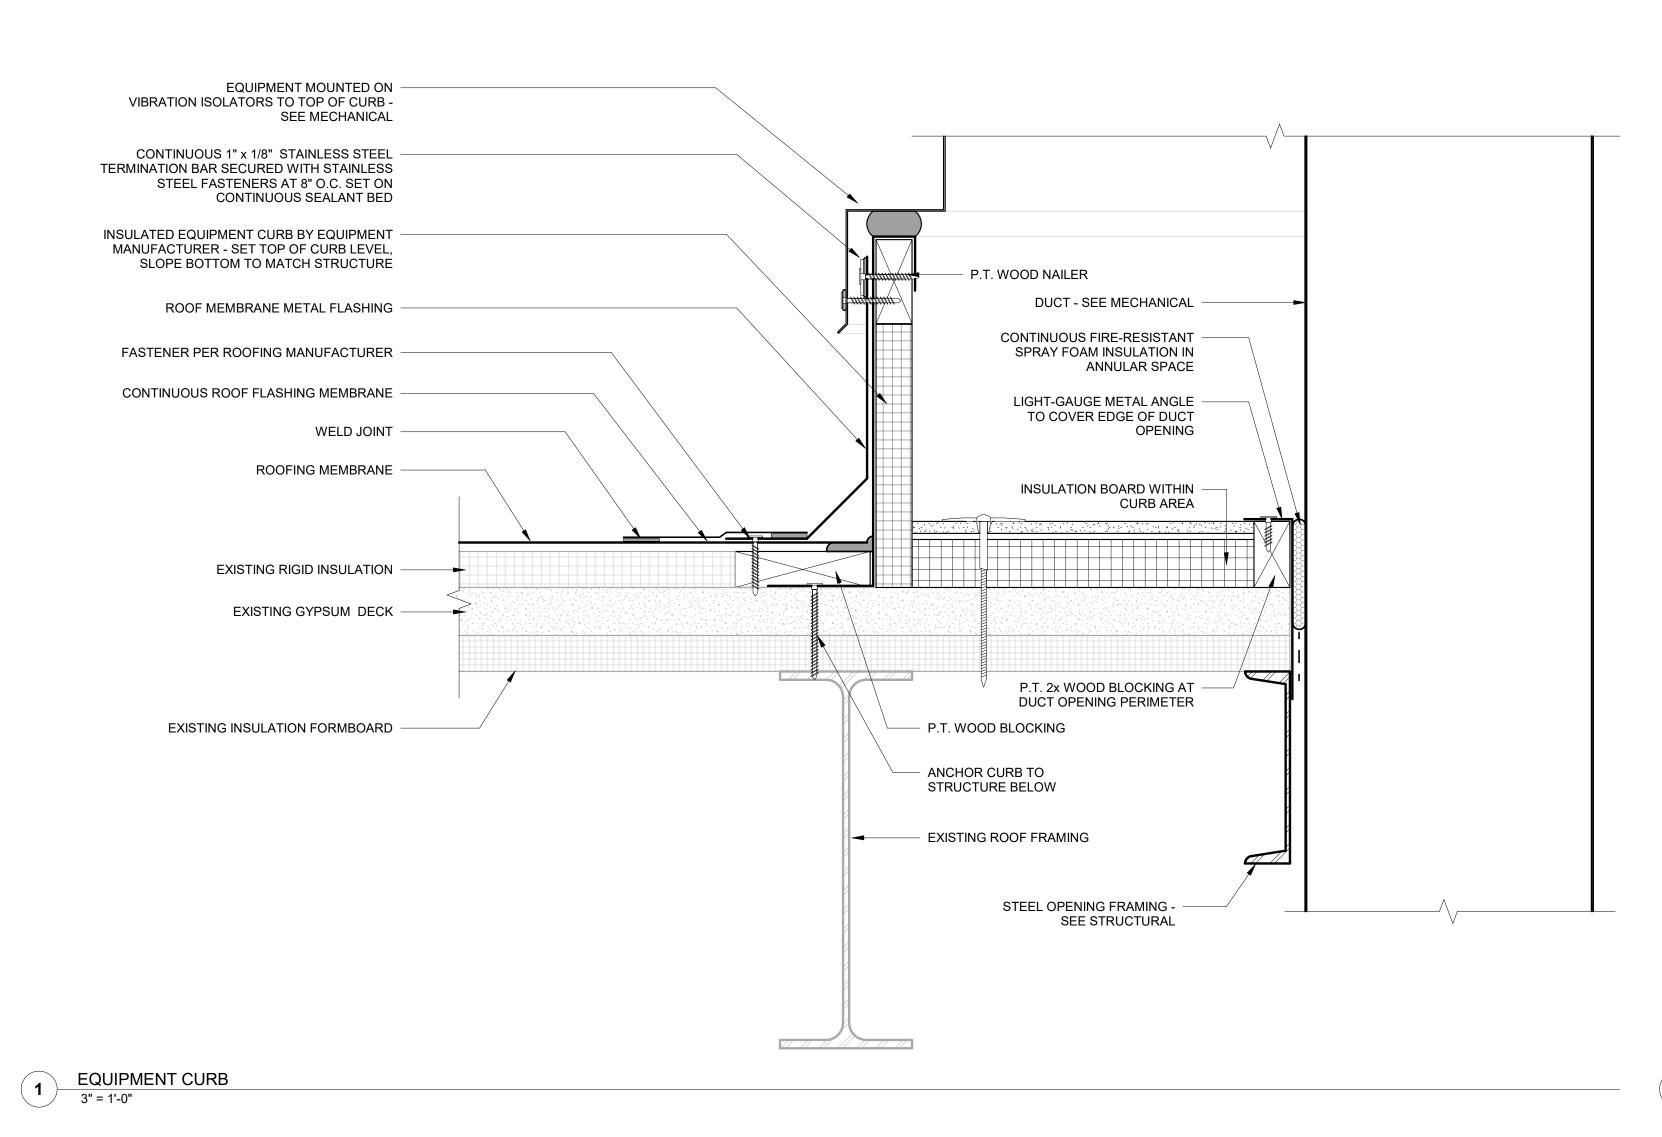DUCT PENETRATION
3" = 1'-0"



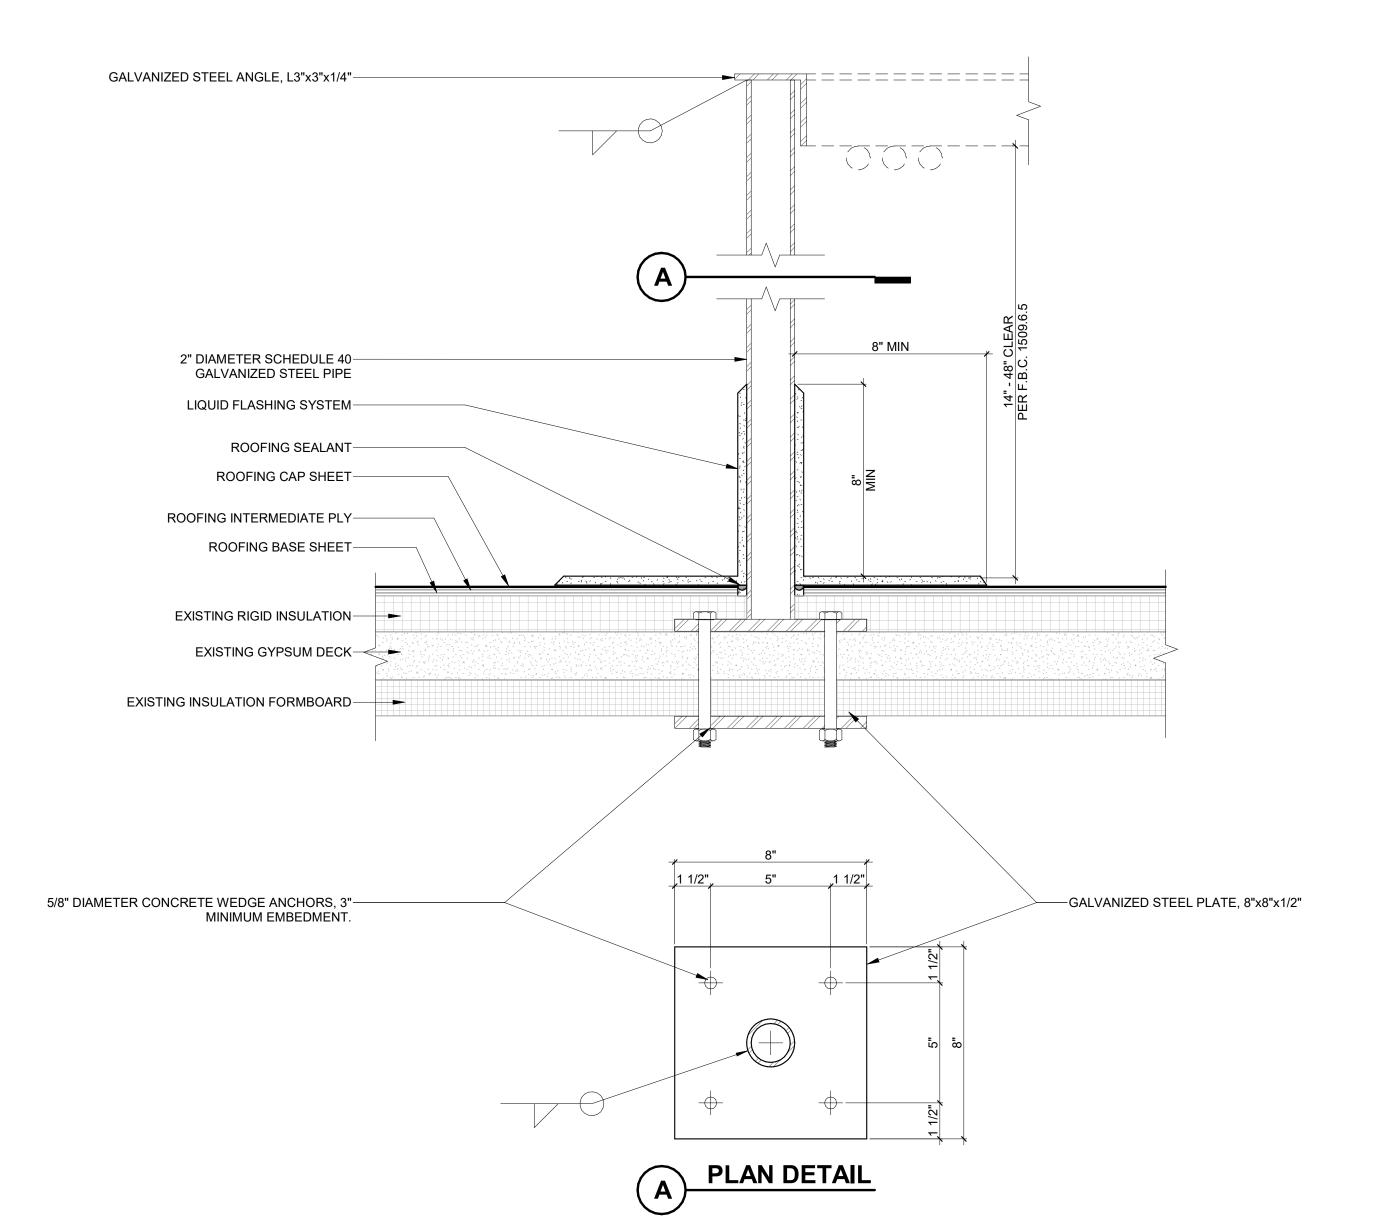

RIGID INSULATION

800F INFILL
3" = 1'-0"

Walker Architects

ARCHITECT

WALKER ARCHITECTS
2035 NW 13TH STREET
GAINESVILLE, FL 32609
352.672.6448 AA26002009

MEPF ENGINEER

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352.376.5500

WALTER P. MOORE 201 E KENNEDY BLVD #700 TAMPA FL 33602

813.221.2424

SEAL AND SIGNATURE

SUBMITTAL: ISSUE DATE:
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REVISION DESCRIPTION DATE

FSU BIO UNIT ONE TEACHING LABS

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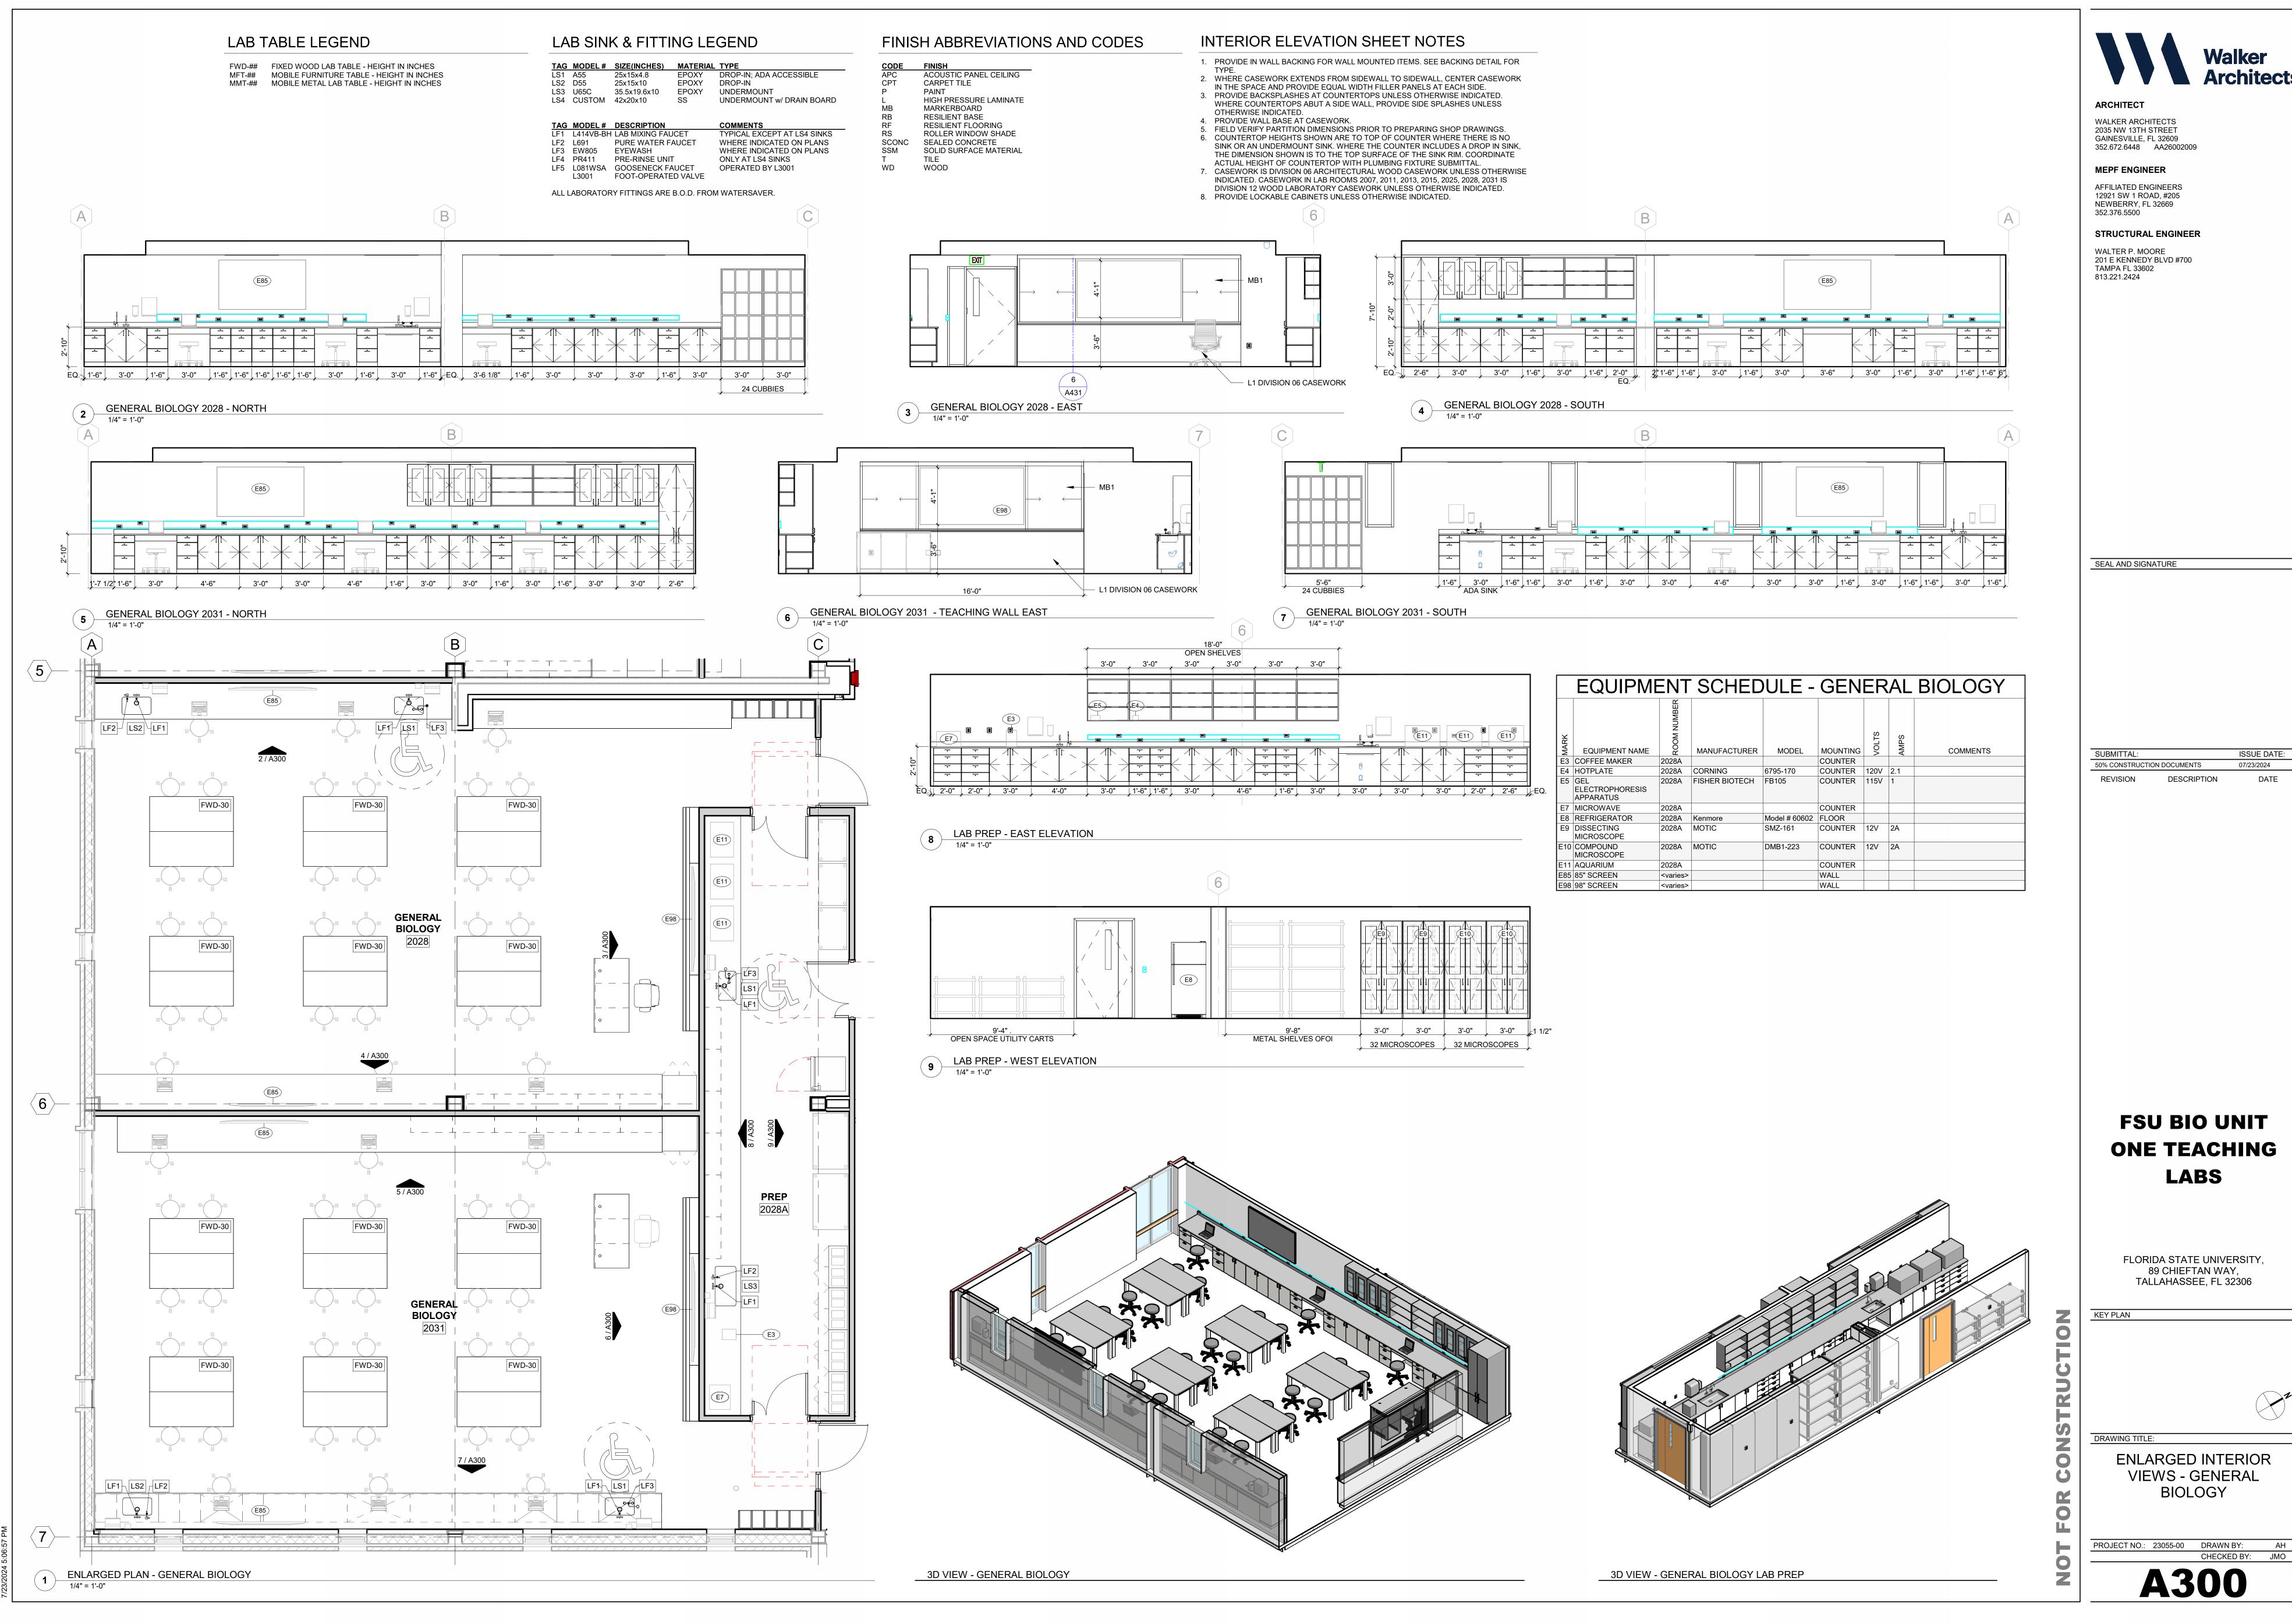
KEY PLAN

ROOF DETAILS

PROJECT NO.: 23055-00 DRAWN BY: KAL

A240

3 DUCT SUPPORT
3" = 1'-0"



MFT-## MOBILE FURNITURE TABLE - HEIGHT IN INCHES

MMT-## MOBILE METAL LAB TABLE - HEIGHT IN INCHES

LAB SINK & FITTING LEGEND

LS3 U65C 35.5x19.6x10 EPOXY UNDERMOUNT

TAGMODEL #SIZE(INCHES)MATERIALTYPELS1A5525x15x4.8EPOXYDROP-IN; ADA ACCESSIBLELS2D5525x15x10EPOXYDROP-IN

SS

UNDERMOUNT w/ DRAIN BOARD

OPERATED BY L3001

TAG MODEL# DESCRIPTION
LF1 L414VB-BH LAB MIXING FAUCET COMMENTS
TYPICAL EXCEPT AT LS4 SINKS LF2 L691 PURE WATER FAUCET WHERE INDICATED ON PLANS WHERE INDICATED ON PLANS LF3 EW805 EYEWASH LF4 PR411 PRE-RINSE UNIT ONLY AT LS4 SINKS

LF5 L081WSA GOOSENECK FAUCET

L3001 FOOT-OPERATED VALVE

LS4 CUSTOM 42x20x10

ALL LABORATORY FITTINGS ARE B.O.D. FROM WATERSAVER.

FINISH ABBREVIATIONS AND CODES

ACOUSTIC PANEL CEILING

CARPET TILE PAINT HIGH PRESSURE LAMINATE MARKERBOARD RESILIENT BASE


RESILIENT FLOORING ROLLER WINDOW SHADE SCONC SEALED CONCRETE SOLID SURFACE MATERIAL SSM TILE WD

WOOD

INTERIOR ELEVATION SHEET NOTES

- 1. PROVIDE IN WALL BACKING FOR WALL MOUNTED ITEMS. SEE BACKING DETAIL FOR
- 2. WHERE CASEWORK EXTENDS FROM SIDEWALL TO SIDEWALL, CENTER CASEWORK IN THE SPACE AND PROVIDE EQUAL WIDTH FILLER PANELS AT EACH SIDE. 3. PROVIDE BACKSPLASHES AT COUNTERTOPS UNLESS OTHERWISE INDICATED. WHERE COUNTERTOPS ABUT A SIDE WALL, PROVIDE SIDE SPLASHES UNLESS
- OTHERWISE INDICATED. 4. PROVIDE WALL BASE AT CASEWORK. 5. FIELD VERIFY PARTITION DIMENSIONS PRIOR TO PREPARING SHOP DRAWINGS.
- 6. COUNTERTOP HEIGHTS SHOWN ARE TO TOP OF COUNTER WHERE THERE IS NO SINK OR AN UNDERMOUNT SINK. WHERE THE COUNTER INCLUDES A DROP IN SINK, THE DIMENSION SHOWN IS TO THE TOP SURFACE OF THE SINK RIM. COORDINATE ACTUAL HEIGHT OF COUNTERTOP WITH PLUMBING FIXTURE SUBMITTAL. 7. CASEWORK IS DIVISION 06 ARCHITECTURAL WOOD CASEWORK UNLESS OTHERWISE INDICATED. CASEWORK IN LAB ROOMS 2007, 2011, 2013, 2015, 2025, 2028, 2031 IS

DIVISION 12 WOOD LABORATORY CASEWORK UNLESS OTHERWISE INDICATED. 8. PROVIDE LOCKABLE CABINETS UNLESS OTHERWISE INDICATED.

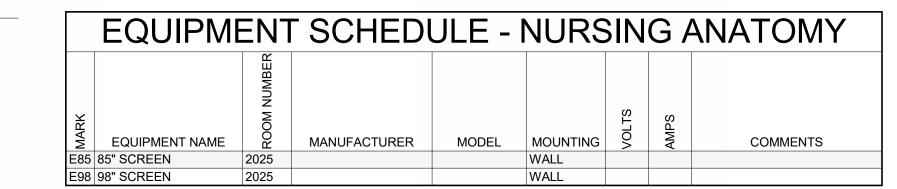



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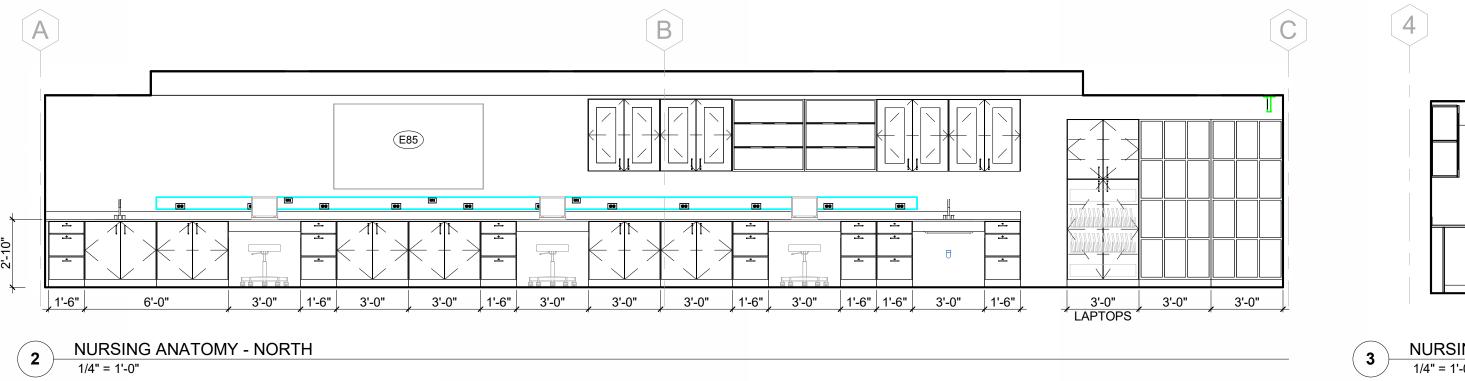
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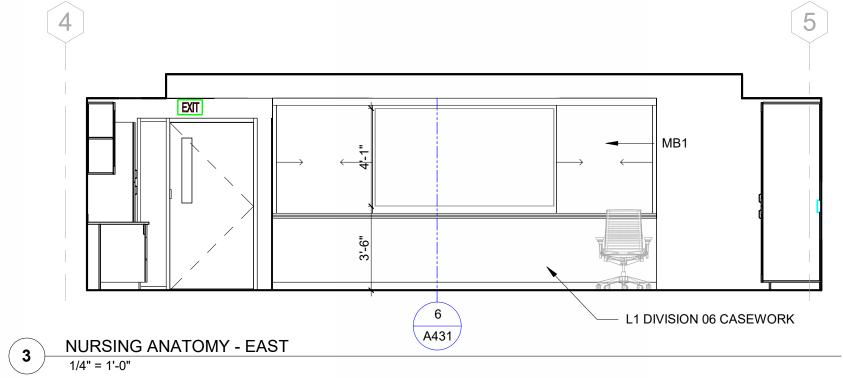
STRUCTURAL ENGINEER WALTER P. MOORE 201 E KENNEDY BLVD #700 TAMPA FL 33602


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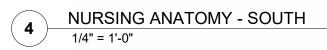
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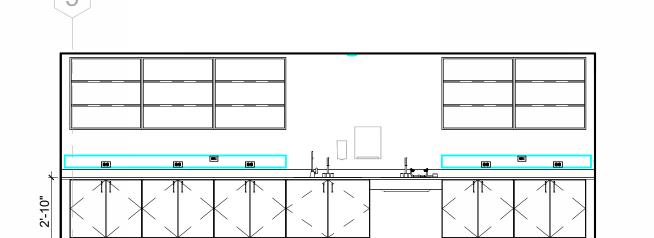
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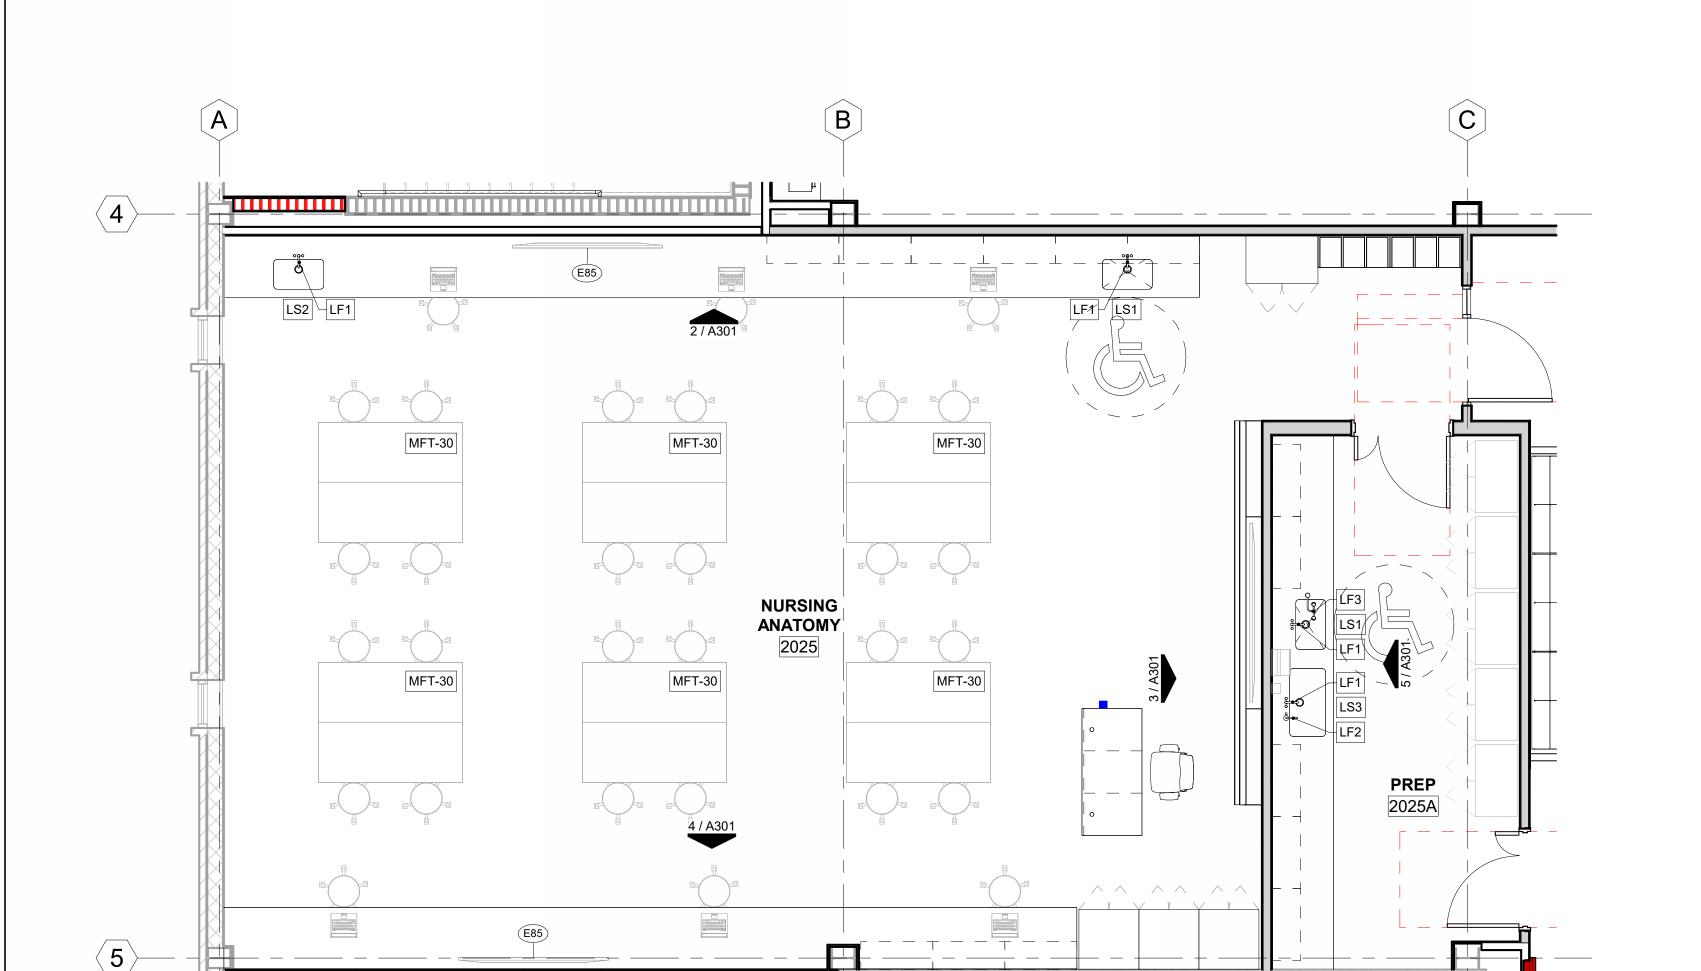







EQ. 3'-0" 3'-0" 3'-0" 3'-0" 3'-0" 3'-0" EQ.

5 LAB PREP / STORAGE - WEST 1/4" = 1'-0"

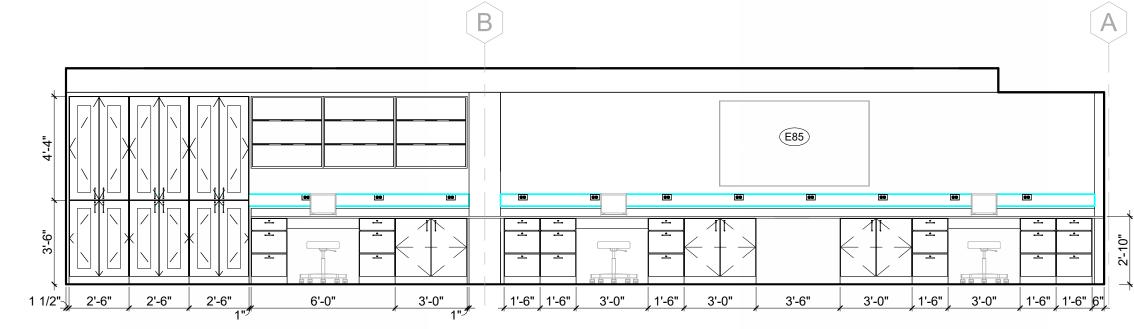

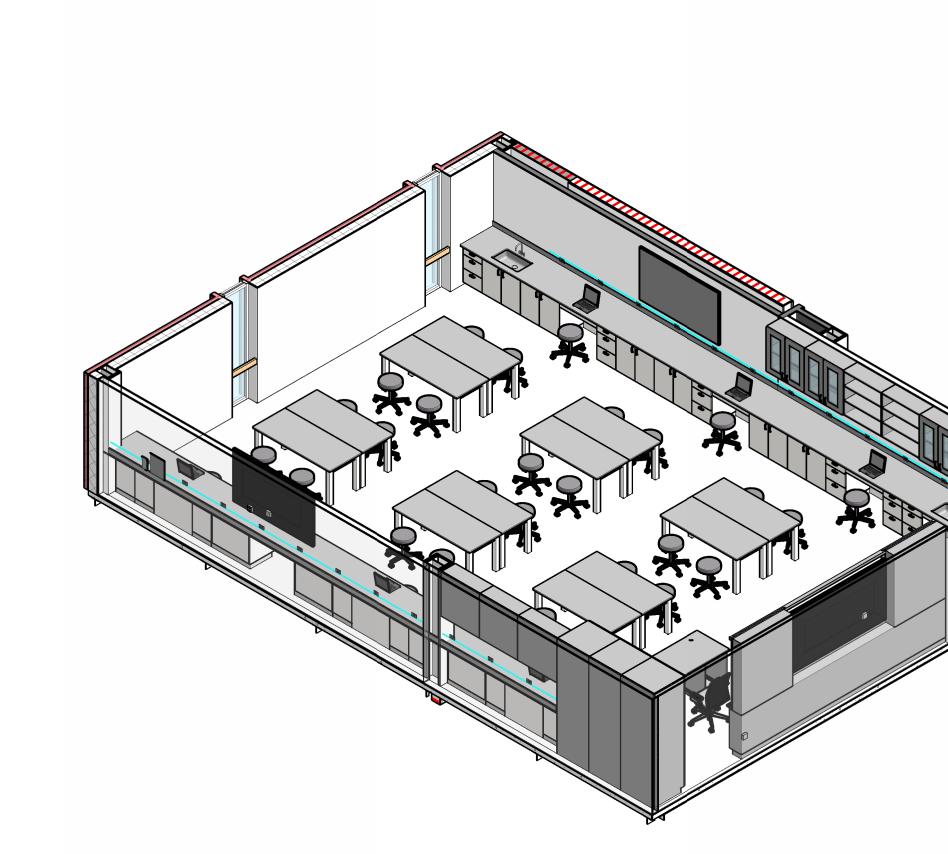

3D VIEW - LAB PREP / STORAGE

FSU BIO UNIT ONE TEACHING **LABS**

FLORIDA STATE UNIVERSITY

ENLARGED INTERIOR

VIEWS - NURSING ANATOMY

PROJECT NO.: 23055-00 DRAWN BY: AH

1 ENLARGED PLAN - NURSING ANATOMY
1/4" = 1'-0" 3D VIEW - NURSING ANATOMY

LAB TABLE LEGEND LAB SINK & FITTING LEGEND FINISH ABBREVIATIONS AND CODES INTERIOR ELEVATION SHEET NOTES 1. PROVIDE IN WALL BACKING FOR WALL MOUNTED ITEMS. SEE BACKING DETAIL FOR TAG MODEL # SIZE(INCHES) MATERIAL TYPE FWD-## FIXED WOOD LAB TABLE - HEIGHT IN INCHES EPOXY DROP-IN; ADA ACCESSIBLE ACOUSTIC PANEL CEILING MFT-## MOBILE FURNITURE TABLE - HEIGHT IN INCHES 25x15x4.8 2. WHERE CASEWORK EXTENDS FROM SIDEWALL TO SIDEWALL, CENTER CASEWORK MMT-## MOBILE METAL LAB TABLE - HEIGHT IN INCHES LS2 D55 EPOXY DROP-IN CARPET TILE 25x15x10 IN THE SPACE AND PROVIDE EQUAL WIDTH FILLER PANELS AT EACH SIDE. LS3 U65C 35.5x19.6x10 EPOXY UNDERMOUNT PAINT 3. PROVIDE BACKSPLASHES AT COUNTERTOPS UNLESS OTHERWISE INDICATED. UNDERMOUNT w/ DRAIN BOARD LS4 CUSTOM 42x20x10 SS HIGH PRESSURE LAMINATE WHERE COUNTERTOPS ABUT A SIDE WALL, PROVIDE SIDE SPLASHES UNLESS MARKERBOARD OTHERWISE INDICATED. RESILIENT BASE 4. PROVIDE WALL BASE AT CASEWORK. EQUIPMENT NAME TAG MODEL# DESCRIPTION
LF1 L414VB-BH LAB MIXING FAUCET RESILIENT FLOORING 5. FIELD VERIFY PARTITION DIMENSIONS PRIOR TO PREPARING SHOP DRAWINGS. TYPICAL EXCEPT AT LS4 SINKS ROLLER WINDOW SHADE E20 MICROSCOPE 2015 OMAX 6. COUNTERTOP HEIGHTS SHOWN ARE TO TOP OF COUNTER WHERE THERE IS NO LF2 L691 PURE WATER FAUCET WHERE INDICATED ON PLANS SCONC SEALED CONCRETE E21 INCUBATOR 2015A FORMA SCIENTIFIC SINK OR AN UNDERMOUNT SINK. WHERE THE COUNTER INCLUDES A DROP IN SINK, WHERE INDICATED ON PLANS LF3 EW805 EYEWASH SSM SOLID SURFACE MATERIAL THE DIMENSION SHOWN IS TO THE TOP SURFACE OF THE SINK RIM. COORDINATE E22 REFRIGERATOR / 2015A GE LF4 PR411 PRE-RINSE UNIT ONLY AT LS4 SINKS TILE ACTUAL HEIGHT OF COUNTERTOP WITH PLUMBING FIXTURE SUBMITTAL. FREEZER WD LF5 L081WSA GOOSENECK FAUCET OPERATED BY L3001 WOOD 7. CASEWORK IS DIVISION 06 ARCHITECTURAL WOOD CASEWORK UNLESS OTHERWISE E23 SLIDE WARMER L3001 FOOT-OPERATED VALVE INDICATED. CASEWORK IN LAB ROOMS 2007, 2011, 2013, 2015, 2025, 2028, 2031 IS DIVISION 12 WOOD LABORATORY CASEWORK UNLESS OTHERWISE INDICATED. ALL LABORATORY FITTINGS ARE B.O.D. FROM WATERSAVER. E24 WATER BATH 2015 BELLCO 8. PROVIDE LOCKABLE CABINETS UNLESS OTHERWISE INDICATED. E25 WATER BATH 2015 NAPCO E26 WATER BATH E27 CENTRIFUGE 2015 BECKMAN COULTER E98 98" SCREEN 2015 (E20) L1 DIVISION 06 CASEWORK — 1 1/2" 3'-0" 3'-0" 3'-0" 3'-0" 3'-0" 3'-0" 3'-0" 3'-0" 1'-6" 3'-0" 1'-6" 3'-0" 1'-6" 3'-0" EQ 3'-0" 1'-6" 1'-6" 3'-0" 3'-0" 3'-0" 1'-6" 1'-6" 3'-0" 3'-A431 2 ANIMAL D 1/4" = 1'-0" ANIMAL DIVERSITY - SOUTH
1/4" = 1'-0" ANIMAL DIVERSITY - NORTH ANIMAL DIVERSITY - EAST 1/4" = 1'-0" **5** PREP 2015A - EAST ELEVATION
1/4" = 1'-0"

1 ENLARGED PLAN - ANIMAL DIVERSITY
1/4" = 1'-0"

EQUIPMENT SCHEDULE - ANIMAL DIVERSITY MANUFACTURER MODEL MOUNTING COMMENTS COUNTER 100-240V 0.1A 2015 FISHER SCIENTIFIC SW-200 COUNTER 115V SERIES COUNTER COUNTER COUNTER 120V COUNTER 110-120V 4A

WALL

ARCHITECT WALKER ARCHITECTS 2035 NW 13TH STREET GAINESVILLE, FL 32609 352.672.6448 AA26002009

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STRUCTURAL ENGINEER WALTER P. MOORE 201 E KENNEDY BLVD #700

TAMPA FL 33602 813.221.2424

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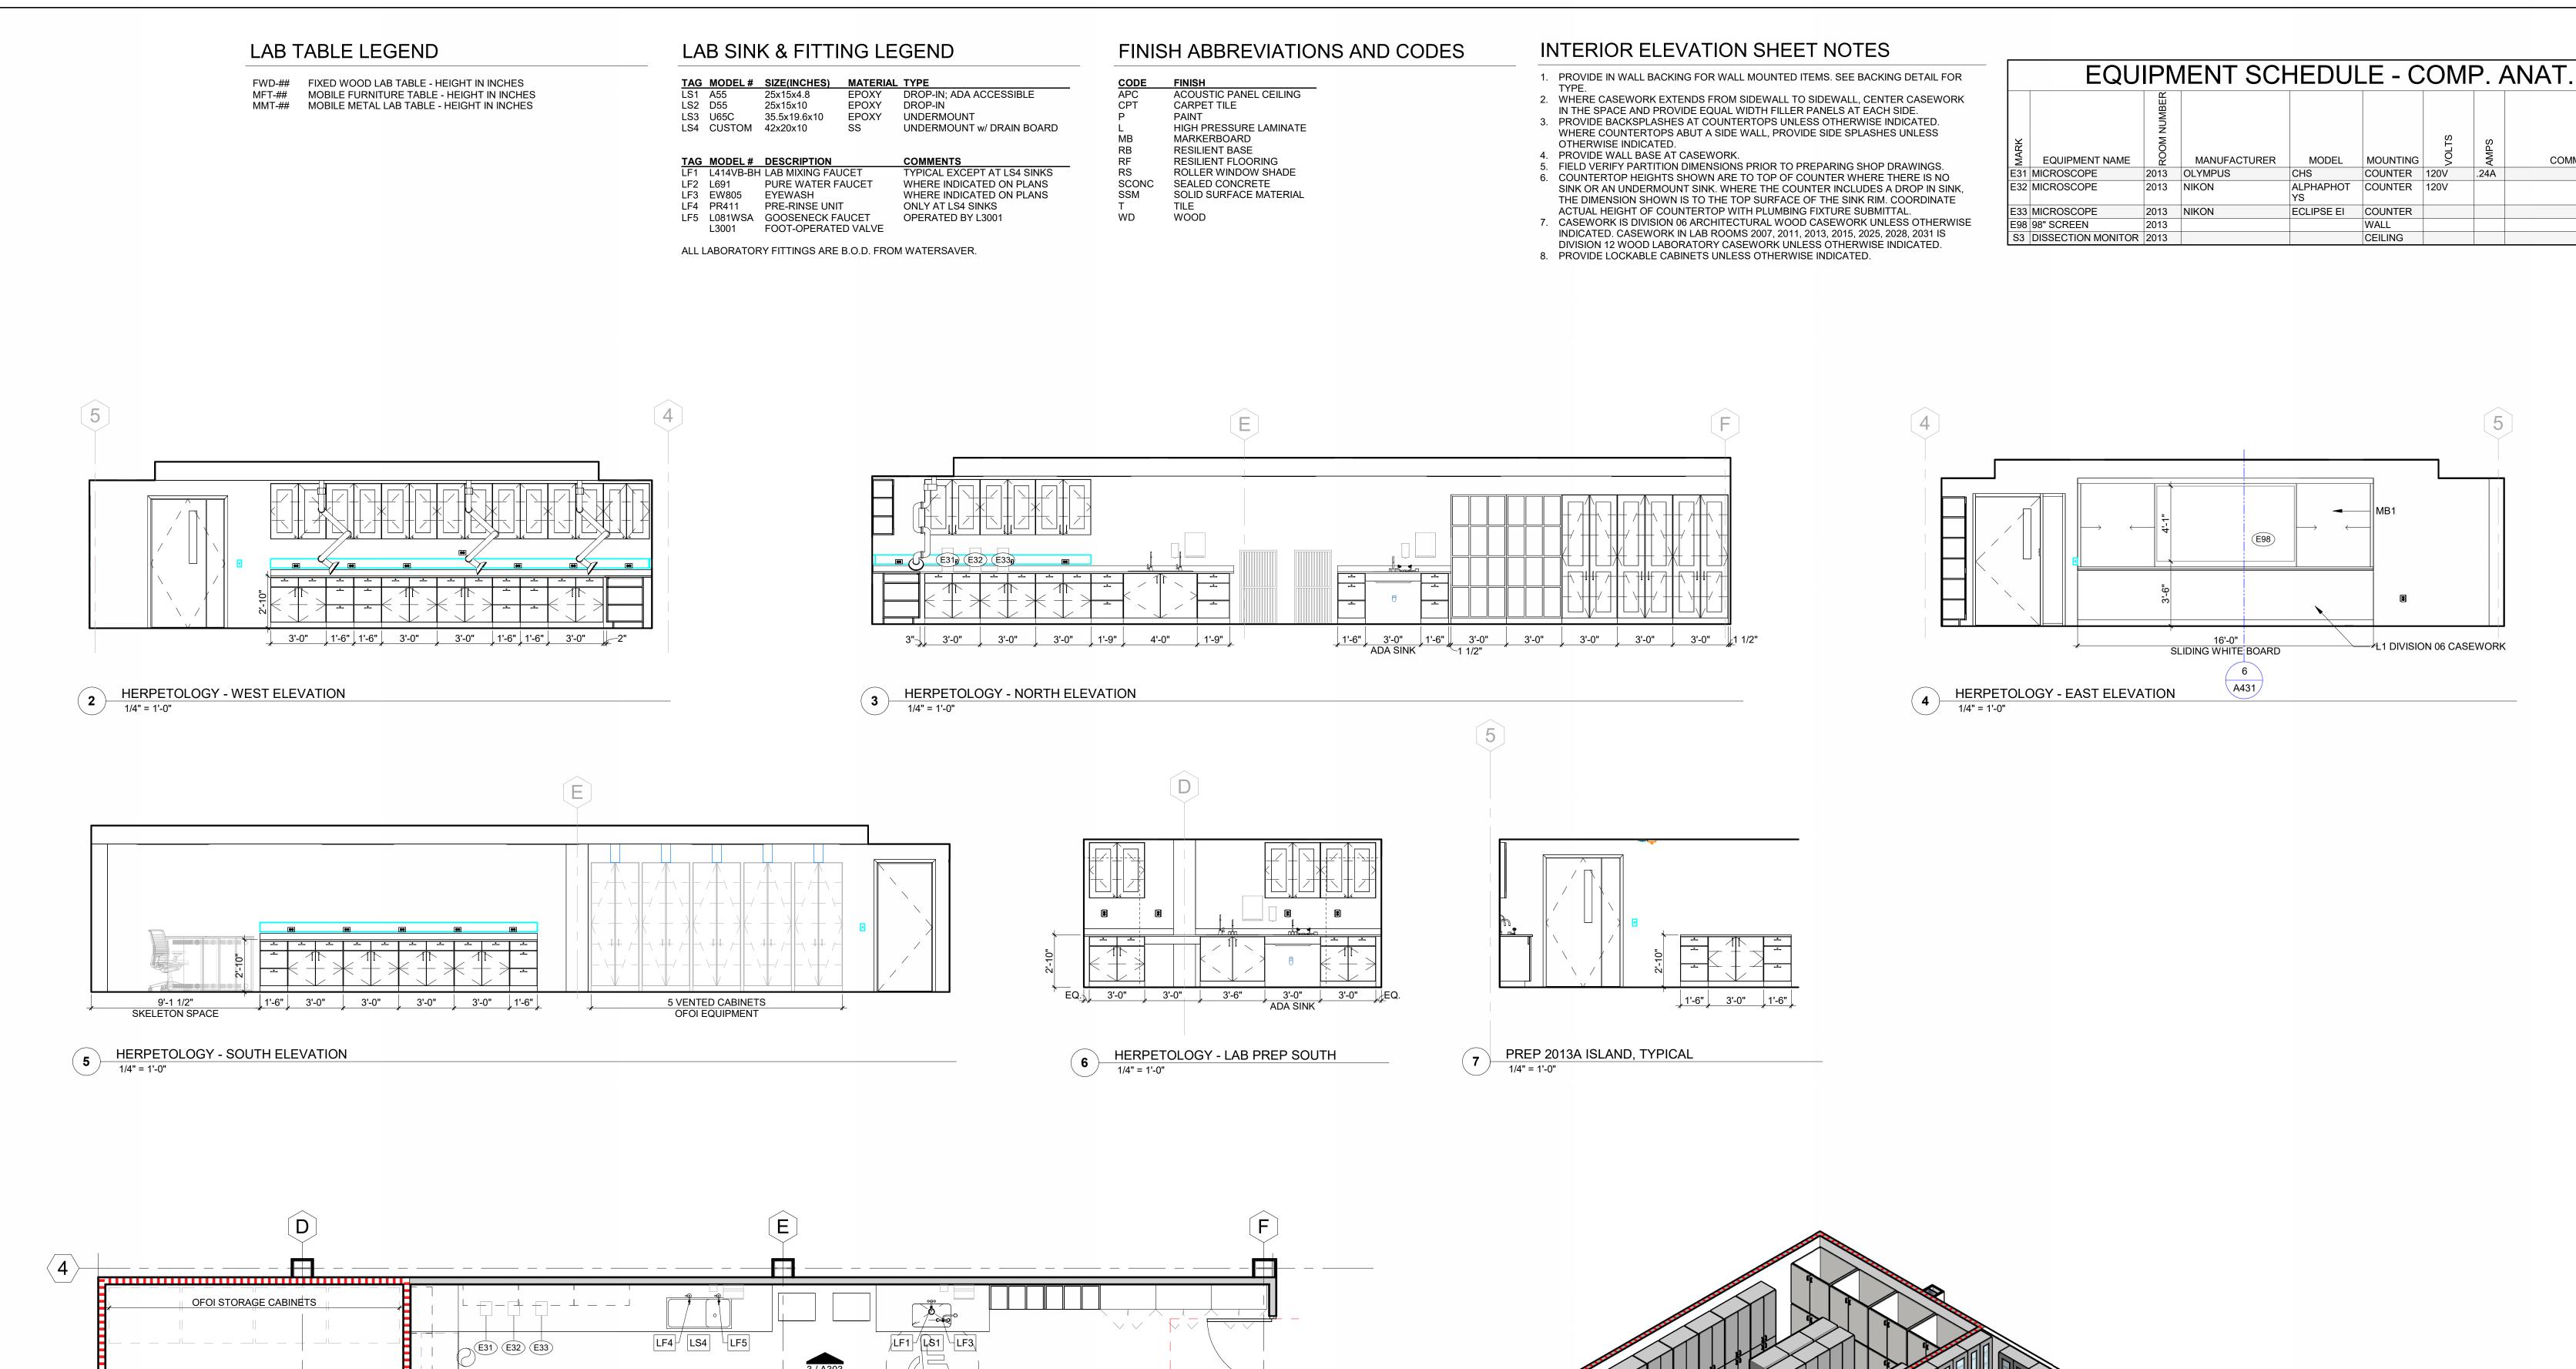
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ENLARGED INTERIOR VIEWS - ANIMAL DIVERSITY

PROJECT NO.: 23055-00 DRAWN BY:

3D VIEW - ANIMAL DIVERSITY




COMPARATIVE ANATOMY/

HERPETOLOGY

E34 - VENTED CABINET STORAGE

1 ENLARGED PLAN COMPARATIVE ANATOMY / HERPETOLOGY LAB
1/4" = 1'-0"

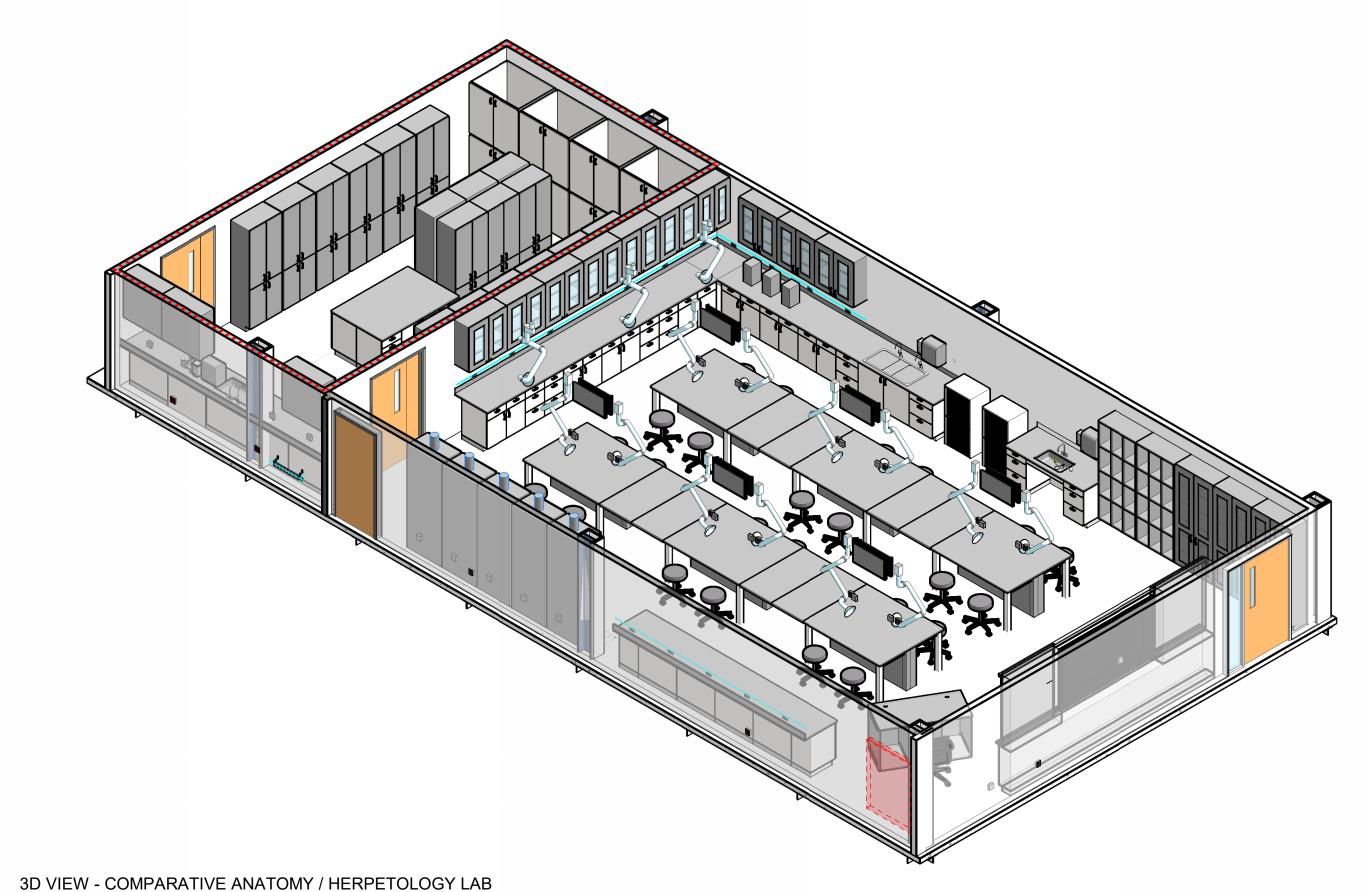



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COMMENTS

CEILING

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ENLARGED INTERIOR VIEWS - ANATOMY / HERPETOLOGY



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GAINESVILLE, FL 32609 352.672.6448 AA26002009 **MEPF ENGINEER**

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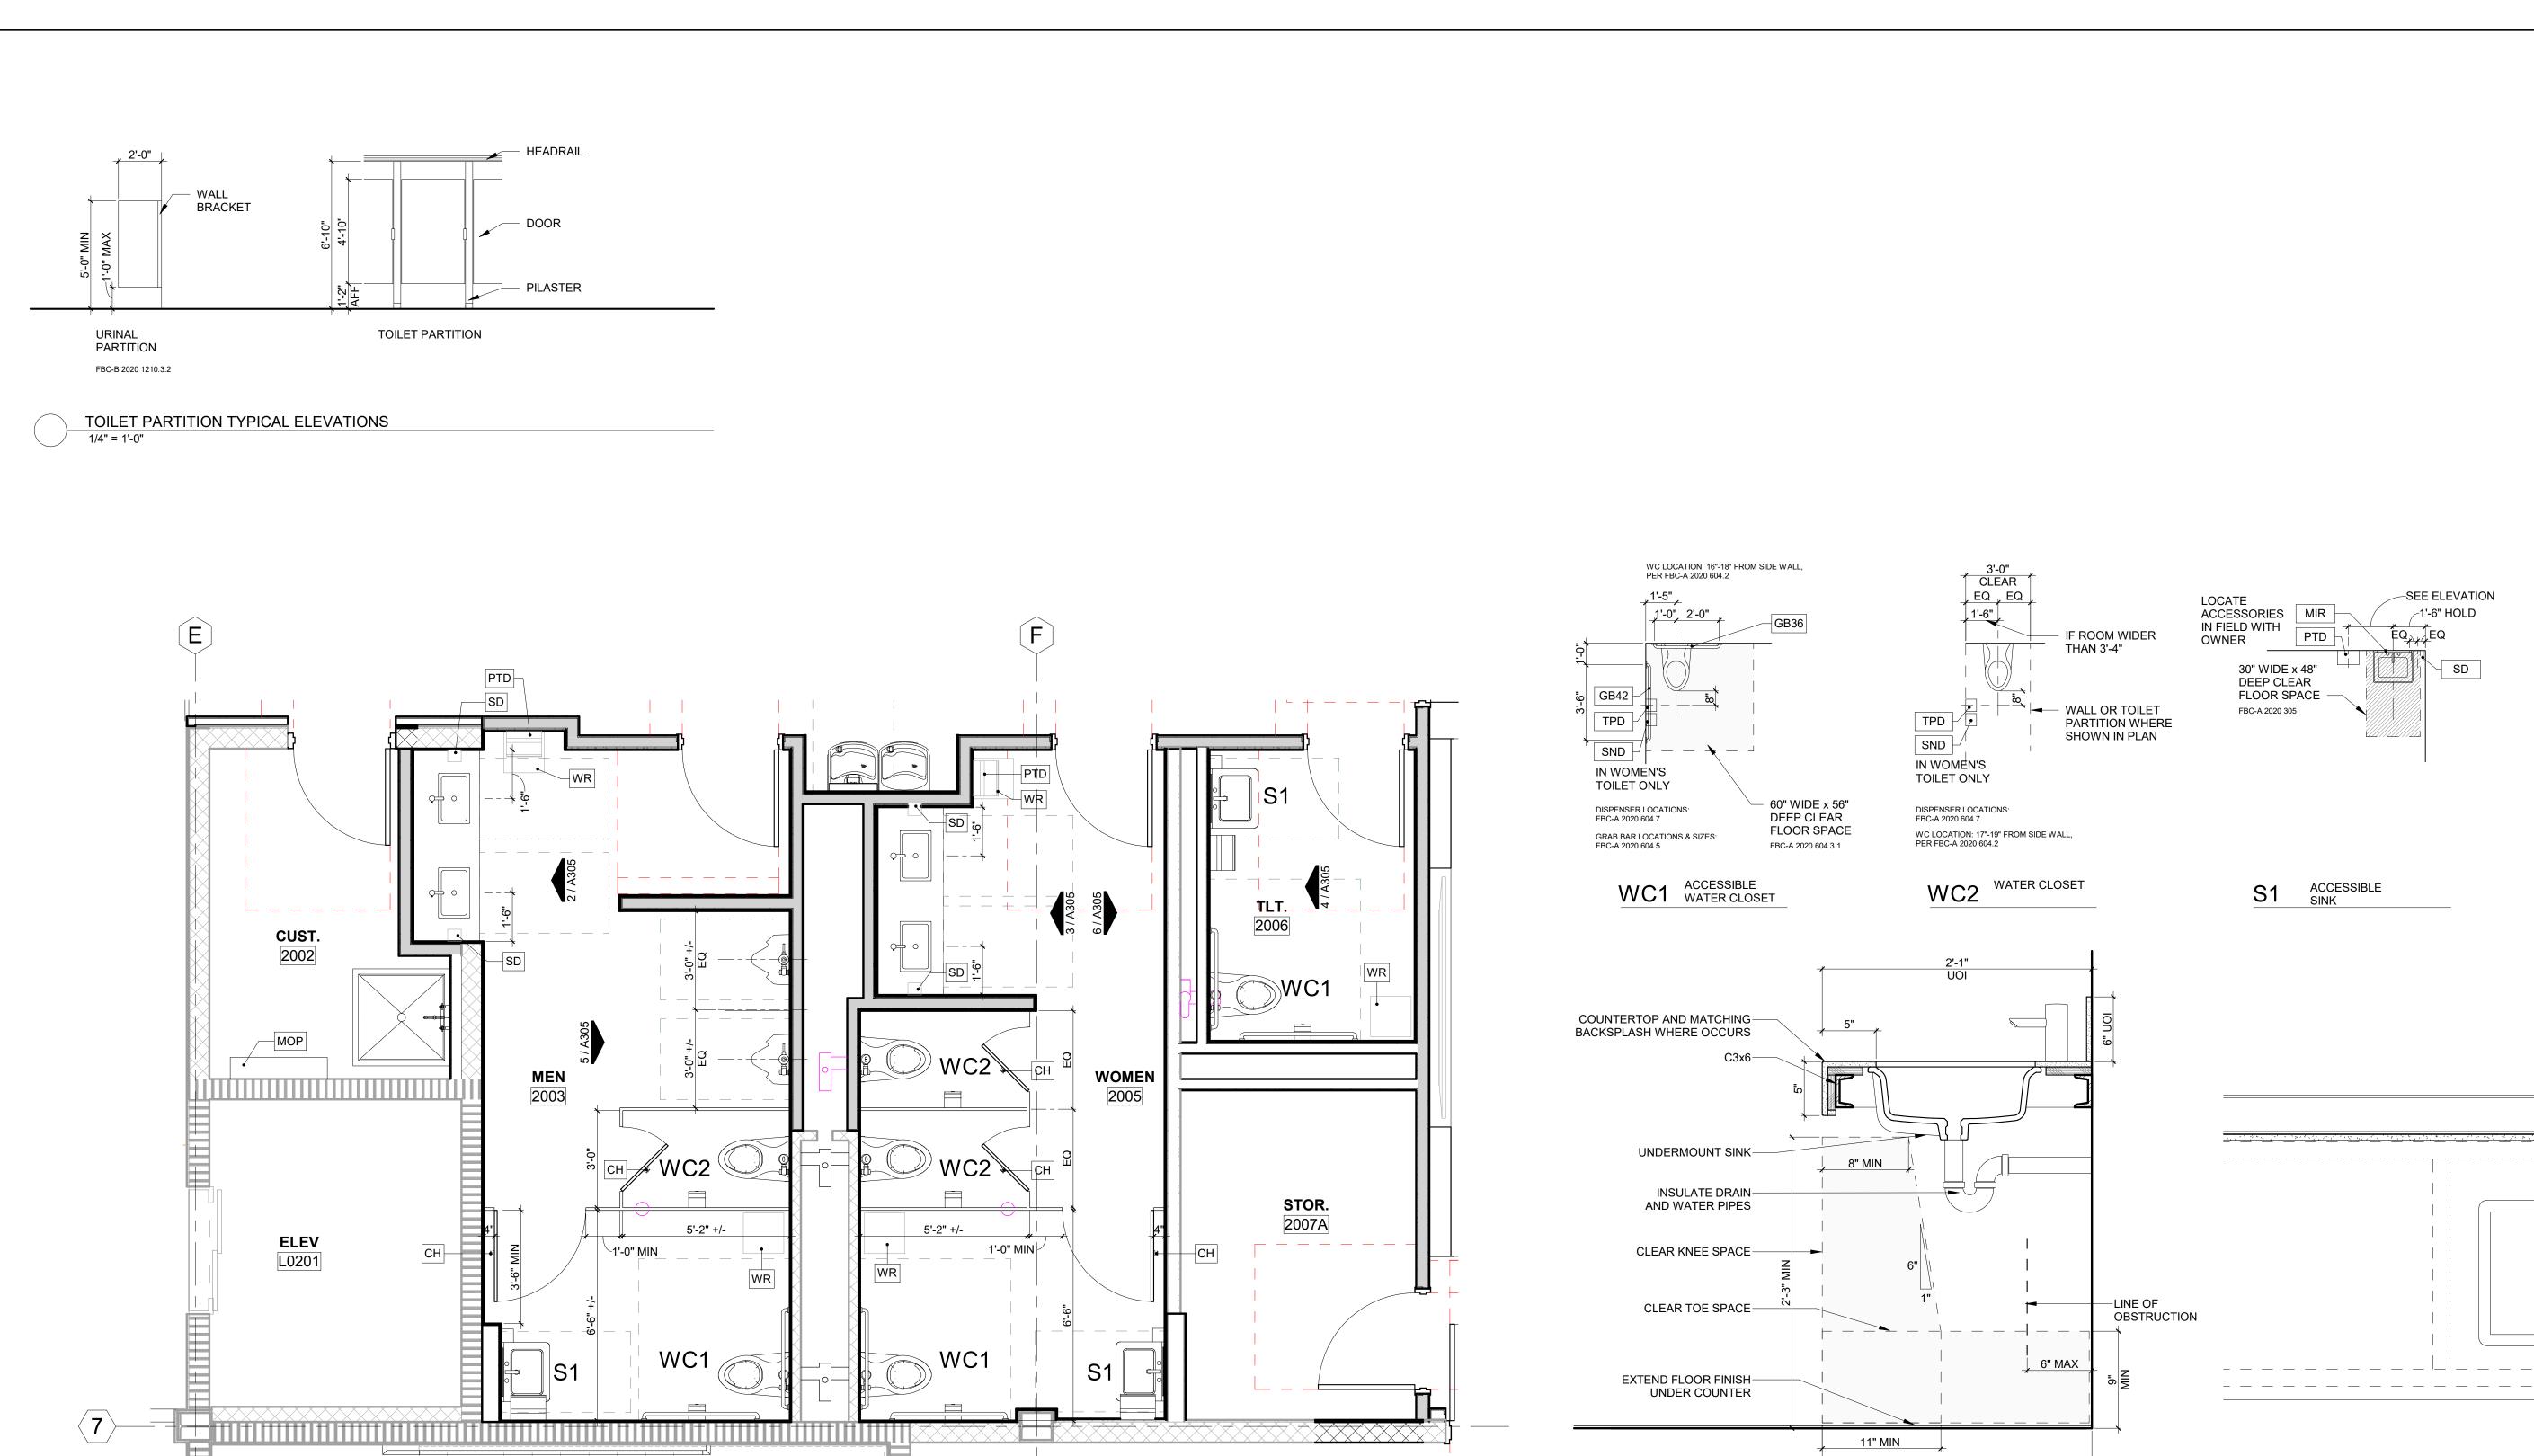
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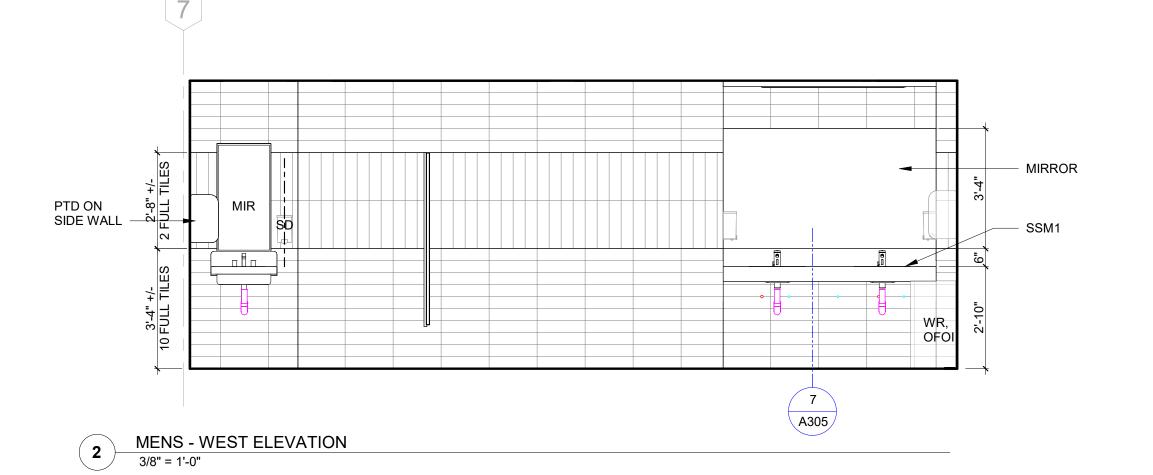
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ENLARGED INTERIOR VIEWS - TEACHING LABS





7 LAV COUNTER WITH STEEL FRAME SECTION
1 1/2" = 1'-0"


8 LAV COUNTER WITH STEEL FRAME PLAN
1 1/2" = 1'-0"




ENLARGED PLANS - RESTROOMS
3/8" = 1'-0"

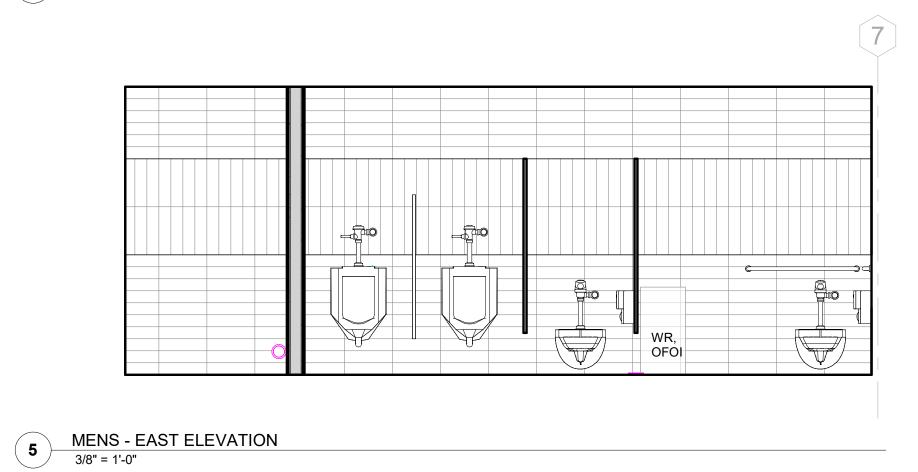

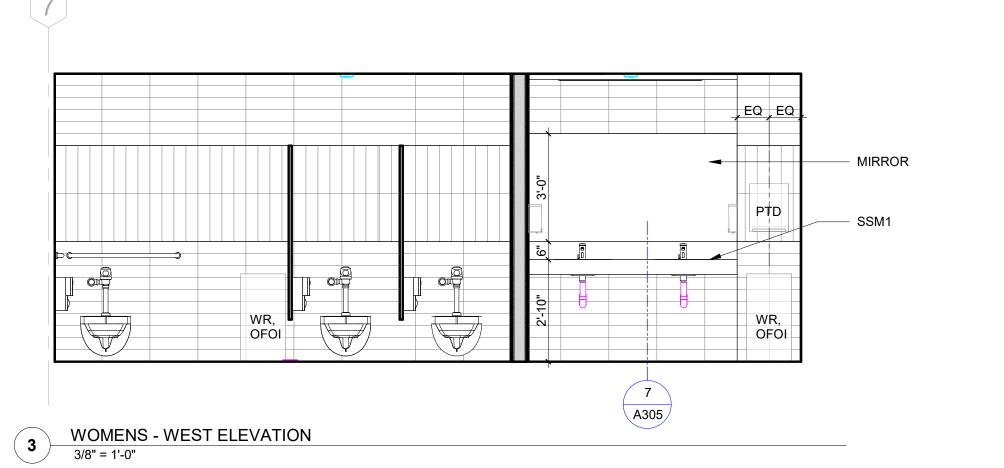

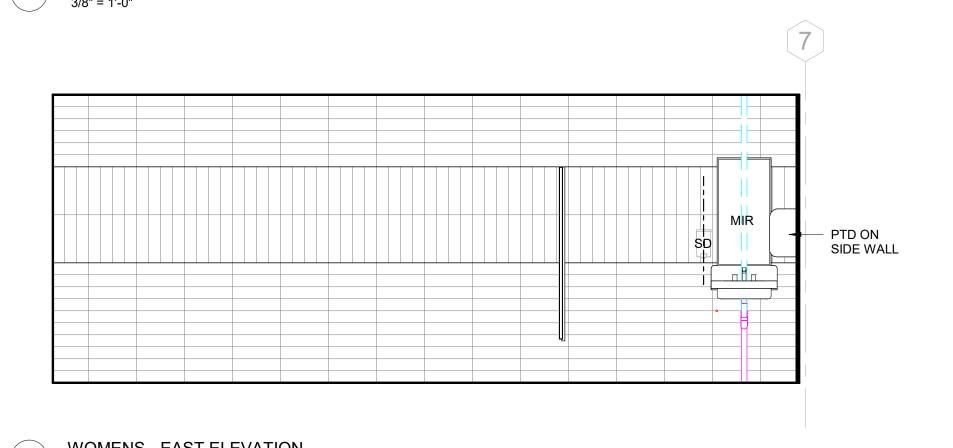

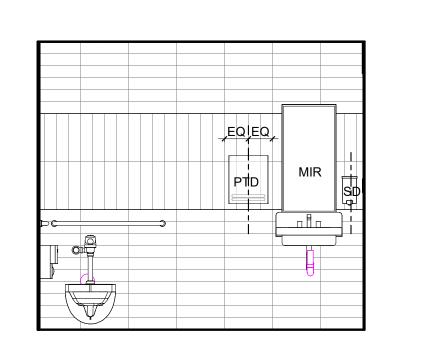

4 UNISEX - WEST ELEVATION
3/8" = 1'-0"

INTERIOR ELEVATION SHEET NOTES

- 1. PROVIDE IN WALL BACKING FOR WALL MOUNTED ITEMS. SEE BACKING DETAIL FOR
- 2. WHERE CASEWORK EXTENDS FROM SIDEWALL TO SIDEWALL, CENTER CASEWORK IN THE SPACE AND PROVIDE EQUAL WIDTH FILLER PANELS AT EACH SIDE. 3. PROVIDE BACKSPLASHES AT COUNTERTOPS UNLESS OTHERWISE INDICATED.
- WHERE COUNTERTOPS ABUT A SIDE WALL, PROVIDE SIDE SPLASHES UNLESS OTHERWISE INDICATED.
- 4. PROVIDE WALL BASE AT CASEWORK. 5. FIELD VERIFY PARTITION DIMENSIONS PRIOR TO PREPARING SHOP DRAWINGS. 6. COUNTERTOP HEIGHTS SHOWN ARE TO TOP OF COUNTER WHERE THERE IS NO
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- 8. PROVIDE LOCKABLE CABINETS UNLESS OTHERWISE INDICATED.

FINISH ABBREVIATIONS AND CODES

FINISH
ACOUSTIC PANEL CEILING CARPET TILE HIGH PRESSURE LAMINATE MARKERBOARD RESILIENT BASE RESILIENT FLOORING ROLLER WINDOW SHADE SCONC SEALED CONCRETE

SOLID SURFACE MATERIAL

TOILET ROOM AND ACCESSORY NOTES:

WOOD


SSM

WD

- 1. ENLARGED PLANS INDICATE DIMENSIONS, TOILET ACCESSORY LOCATIONS, AND REQUIRED CLEARANCES TO BE MAINTAINED. ENLARGED TOILET ROOM LAYOUTS (TLT1, TLT2, ETC) AND SINK TYPES (S1, S2, ETC) ARE KEYED ONTO ENLARGED FLOOR PLANS.
- REFER TO ENLARGED FLOOR PLAN SHEETS FOR EXACT TOILET ROOM AND/OR FIXTURE ORIENTATION, DOOR LOCATION(S), ADJACENT WALL CONSTRUCTION, AND ADDITIONAL EQUIPMENT ITEMS. DIMENSIONS INDICATED HERE ARE TYPICAL, UNLESS DIMENSIONED OTHERWISE ON FLOOR PLAN SHEETS OR INTERIOR ELEVATIONS.
- DIMENSIONS SHOWN FOR ACCESSORIES AND EQUIPMENT ITEMS AND CLEAR FLOOR SPACE ARE FROM FACE OF ROOM FINISH (SUCH AS TILE). NOTE THAT DOORS CANNOT INFRINGE UPON OR SWING INTO THE REQUIRED RECTANGULAR "CLEAR FLOOR SPACE" AREAS SHOWN ON ENLARGED PLANS.
- PLUMBING FIXTURES SHOWN HERE ARE GENERIC SEE PLUMBING DRAWINGS FOR ACTUAL SCHEDULED FIXTURES. ORIENT FLUSH LEVER AT TOILETS TO THE OPEN SIDE OF THE ROOM.

TOILET ACCESSORIES ABBREVIATIONS:

- CH COAT HOOK GBxx MIR GRAB BAR (xx INDICATES LENGTH) MIRROR MOP SHELF AND MOP HOLDER PAPER TOWEL DISPENSER PTD SCD SEAT COVER DISPENSER
- SOAP DISPENSER SND TPD SANITARY NAPKIN DISPOSAL TOILET PAPER DISPENSER WASTE RECEPTACLE (OFOI)

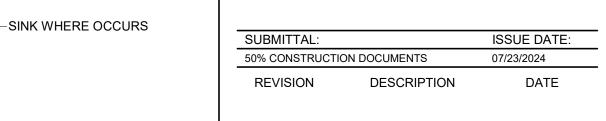

ARCHITECT

WALKER ARCHITECTS

2035 NW 13TH STREET

GAINESVILLE, FL 32609

MEPF ENGINEER

AFFILIATED ENGINEERS

12921 SW 1 ROAD, #205

STRUCTURAL ENGINEER

201 E KENNEDY BLVD #700

SEAL AND SIGNATURE

HSS 4X2 STRUCTURE TUBE

-C 3X6 CHANNEL SUPPORT BELOW, TYP

-HSS 4X2 STRUCTURE TUBE

NEWBERRY, FL 32669

WALTER P. MOORE

TAMPA FL 33602

813.221.2424

352.376.5500


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KEY PLAN

ENLARGED INTERIOR **VIEWS - RESTROOMS**





ARCHITECT
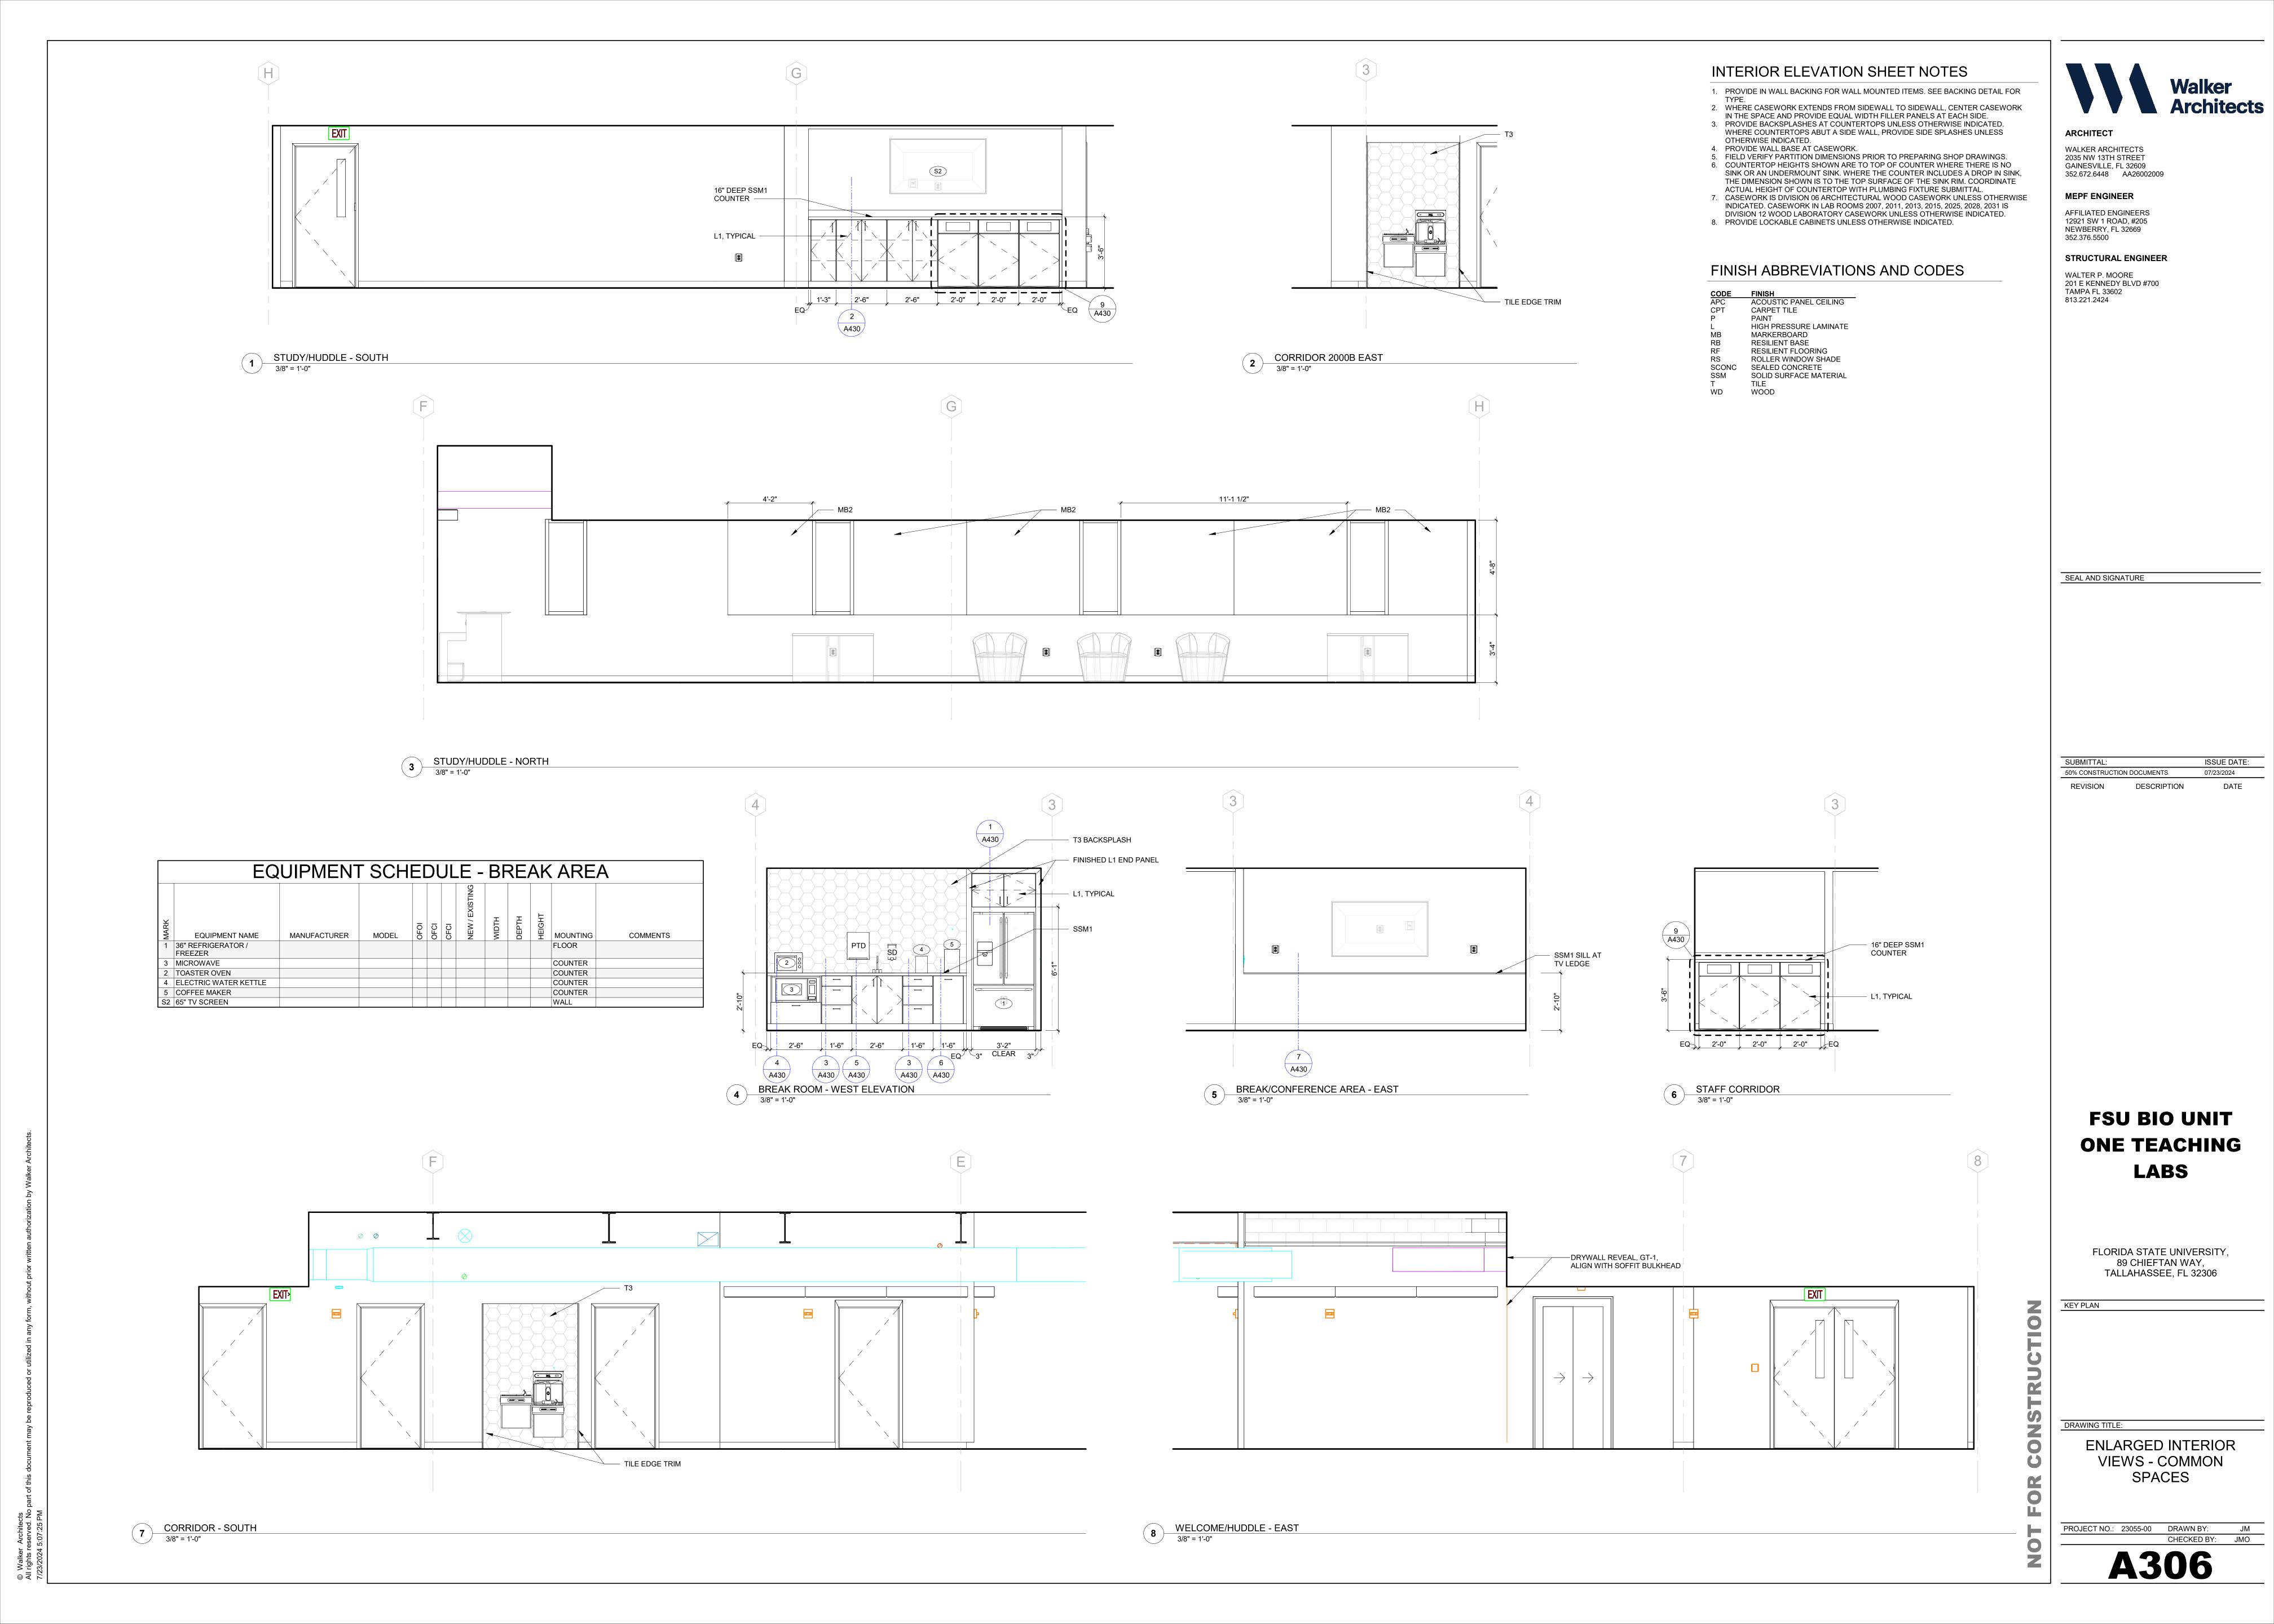
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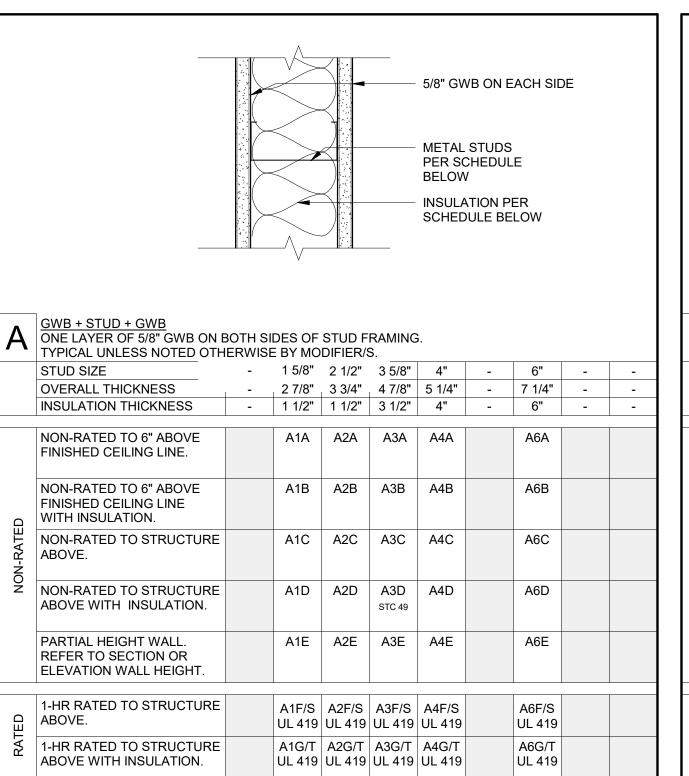
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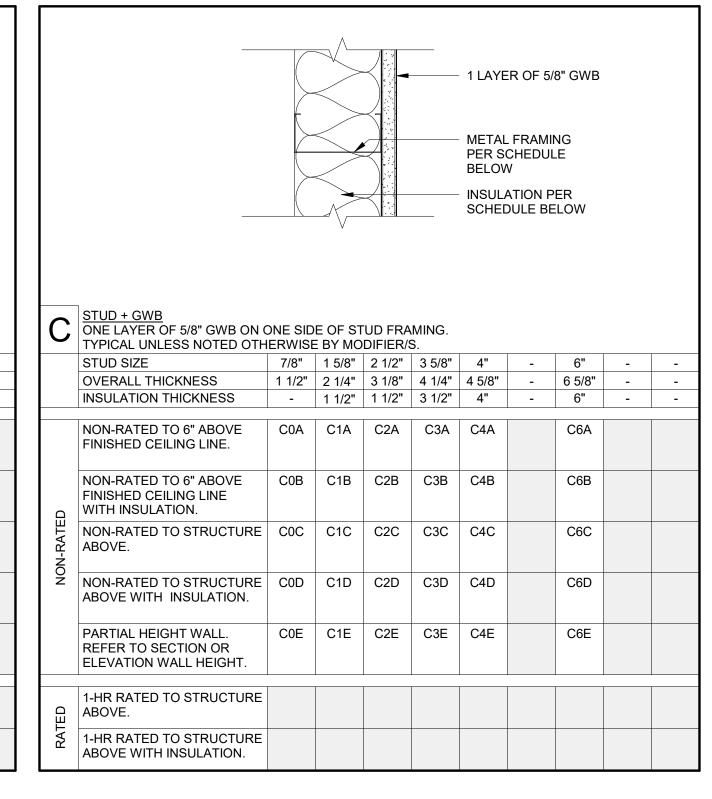
FSU BIO UNIT ONE TEACHING **LABS**

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KEY PLAN

ENLARGED INTERIOR VIEWS - COMMON SPACES





PARTITION TYPE NOTES

1. USE TYPE X GYPSUM BOARD UNLESS NOTED OTHERWISE.

2. USE GLASS MAT MOISTURE AND MOLD RESISTANT GYPSUM BOARD AT INTERIOR SURFACE OF EXTERIOR WALLS, HOUSEKEEPING CLOSETS, TOILET ROOMS WITHOUT SHOWERS, AND WALLS WITH PLUMBING FIXTURES (4' TO EITHER SIDE OF FIXTURE AND FROM FLOOR TO 6' HIGH).

3. USE CEMENTITIOUS BACKER BOARD AT WALLS WITH CERAMIC TILE.

4. REFER TO FLOOR PLANS FOR PARTITIONS IN PROJECT. NOT ALL PARTITION SUB-TYPES APPEARING IN EACH PARTITION MATRIX ARE NECESSARILY USED IN THE PROJECT.

5. RATED PARTITIONS EXTEND TO STRUCTURE ABOVE UNLESS NOTED OTHERWISE.

6. PARTITION TYPES DO NOT INCLUDE APPLIED FINISHES. REFER TO ROOM FINISH PLAN AND INTERIOR ELEVATIONS FOR FINISHES OR MATERIALS APPLIED TO THE PARTITION ASSEMBLY.

7. MAINTAIN CONTINUITY OF HIGHER PRIORITY PARTITIONS (RATED PARTITIONS) THROUGH LOWER PRIORITY PARTITIONS (COLUMN ENCLOSURES AND NON-RATED PARTITIONS).

8. EXTEND GYPSUM BOARD 6 INCHES MINIMUM ABOVE CEILING AT PARTITIONS NOT EXTENDING TO STRUCTURE ABOVE.

9. COORDINATE LOCATIONS AND TYPES OF BACKING PLATES FOR MOUNTED FURNISHINGS, EQUIPMENT AND HANDRAILS.

10. PROVIDE UL OR EQUIVALENT FIRE RESISTANCE RATED JOINT ASSEMBLIES AT HEAD, SILL, AND END JOINTS AT RATED PARTITIONS. PROVIDE UL OR EQUIVALENT FIRE RESISTANCE RATED THROUGH PENETRATION FIRESTOPPING AT RATED PARTITIONS.

11. PARTITIONS INDICATED TO HAVE INSULATION ARE ACOUSTIC PARTITIONS THAT PROVIDE SOUND BLOCKING BETWEEN ADJACENT SPACES. PROVIDE ACOUSTIC BATT INSULATION, FULL DEPTH OF STUD CAVITY. PROVIDE ACOUSTICAL SEALANT (NON-HARDENING) AT HEAD, SILL, TERMINATIONS AND PENETRATIONS. PROVIDE ACOUSTIC

PUTTY PADS AROUND ELECTRICAL BOXES. 12. FRAMING OF FULL HEIGHT PARTITIONS TO STRUCTURE ABOVE TO ACCOMMODATE MINIMUM 1/2" DEFLECTION AT HEAD TRACK. SEE PARTITION

FRAMING DRAWINGS.

13. PARTITION TYPE DRAWINGS ARE SHOWN AS PLAN SECTIONS. 14. PROVIDE INSULATION PER UNDERWRITER'S LABORATORY FIRE RESISTANCE

15. UNLESS NOTED OTHERWISE, ALL LIMITING PARTITION HEIGHTS ARE BASED ON A 5 psf INTERMITTENT AIR PRESSURE LOAD AND A DEFLECTION CRITERIA OF L/240.

FOR SMOOTH SURFACE. 17. PROVIDE THERMAL INSULATION AT PARTITIONS ABUTTING EXTERIOR WALLS.

16. WHERE DISSIMILAR PARTITIONS ABUT, ALIGN FINISH FACES AT EXPOSED SIDE

PROVIDE ACOUSTICAL INSULATION AT OTHER PARTITIONS SCHEDULED TO RECEIVE INSULATION.

PARTITION - IDENTIFYING SYMBOL

THIS DIGIT DENOTES THE ASSEMBLY TYPES AS FOLLOWS:

A = FRAME PARTITION w/ SINGLE LAYER GYPSUM BOARD EACH SIDE

B = FRAME PARTITION w/ DOUBLE LAYER GYPSUM BOARD EACH SIDE C = FRAME PARTITION w/ SINGLE LAYER GYPSUM BOARD ONE SIDE (CHASE PARTITION)

D = FRAME PARTITION w/ SINGLE LAYER GYPSUM BOARD ON ONE SIDE, TWO LAYERS ON THE OTHER

J,K = SHAFT WALL (C-H STUD)

M.N = MASONRY Q,R = RADIATION PROTECTION (LEAD LINED) PARTITION S = ENHANCED ACOUSTIC PARTITION, RESILIENT CHANNELS

Z = ZEE FURRING PARTITION w/ SINGLE LAYER GWB ONE SIDE

REFER TO PARTITION SCHEDULE FOR DETAILS OF EACH ASSEMBLY

THIS DIGIT DENOTES ADDITIONAL COMPONENTS OR ENHANCEMENTS TO THE BASIC PARTITIONS AS FOLLOWS:

A = NON-RATED TO 6" ABOVE FINISHED CEILING LINE

B = NON-RATED TO 6" ABOVE FINISHED CEILING LINE WITH INSULATION C = NON-RATED TO STRUCTURE ABOVE

D = NON-RATED TO STRUCTURE ABOVE WITH INSULATION E = PARTIAL HEIGHT WALL

F = FIRE RATED TO STRUCTURE ABOVE

A A A

PROVIDE UL LISTED PARTITION AND JOINTS TO ADJACENT CONSTRUCTION PARTITION AS SHOWN, TOP UL HW-D-0154 OR EQUAL, BOT. UL BW-S-0001 OR EQUAL G = FIRE RATED TO STRUCTURE ABOVE WITH INSULATION

PROVIDE UL LISTED PARTITION AND JOINTS TO ADJACENT CONSTRUCTION PARTITION AS SHOWN, TOP UL HW-D-0154 OR EQUAL, BOT. UL BW-S-0001 OR EQUAL


S = FIRE AND SMOKE RATED TO STRUCTURE ABOVE PROVIDE UL LISTED PARTITION AND JOINTS TO ADJACENT CONSTRUCTION PARTITION AS SHOWN, TOP UL HW-D-0154 OR EQUAL, BOT. UL BW-S-0001 OR EQUAL


T = FIRE AND SMOKE RATED TO STRUCTURE ABOVE WITH INSULATION PROVIDE UL LISTED PARTITION AND JOINTS TO ADJACENT CONSTRUCTION PARTITION AS SHOWN, TOP UL HW-D-0154 OR EQUAL, BOT. UL BW-S-0001 OR EQUAL


- THIS DIGIT DENOTES STUD/BLOCK SIZE:


6 = 600 (6") STUDS

 = 162 (1 5/8") STUDS = 4" BLOCK = 250 (2 1/2") STUDS **6** = 6" BLOCK = 362 (3 5/8") STUDS 8 = 8" BLOCK = 400 (4") STUDS = 12" BLOCK

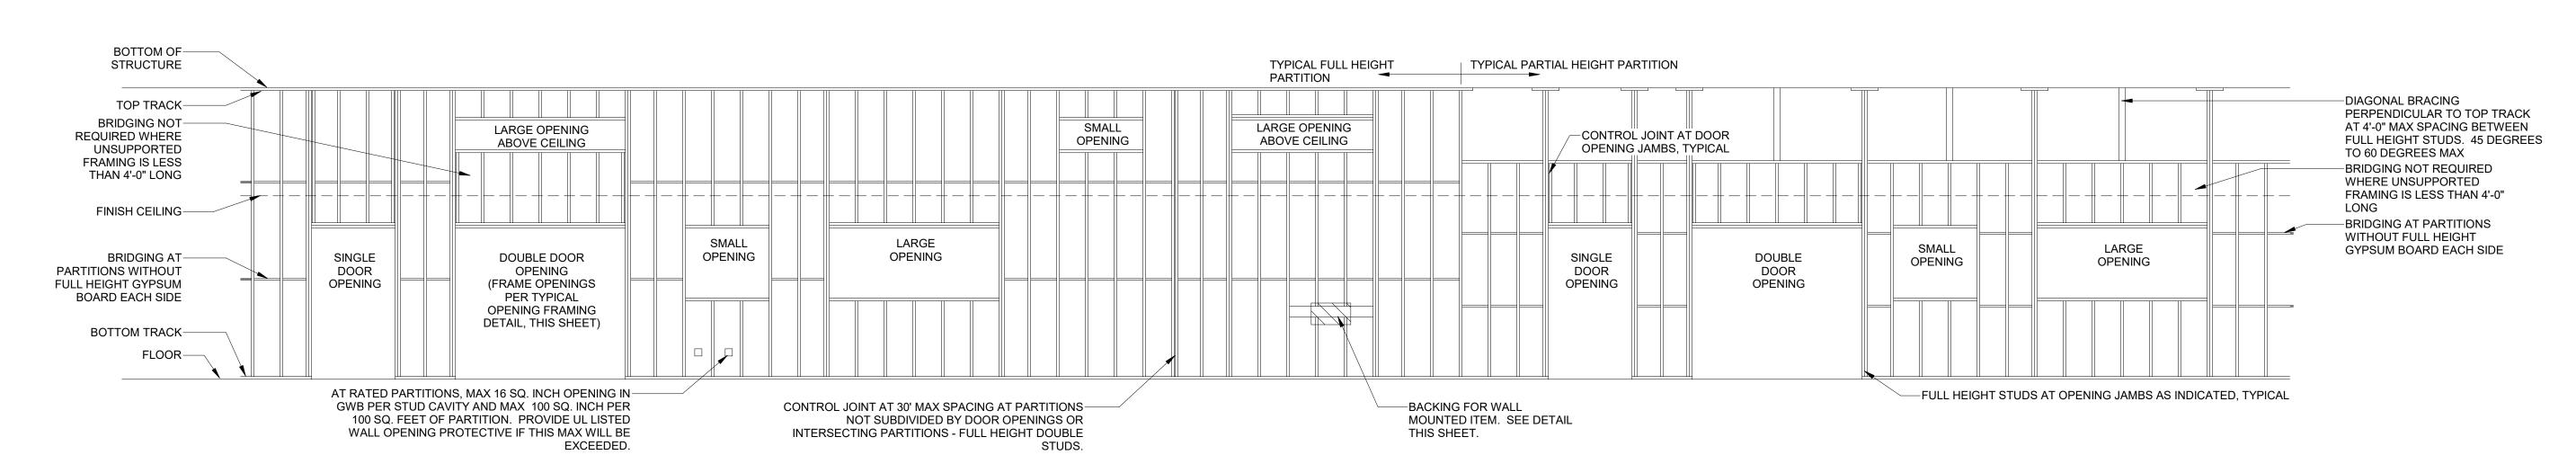

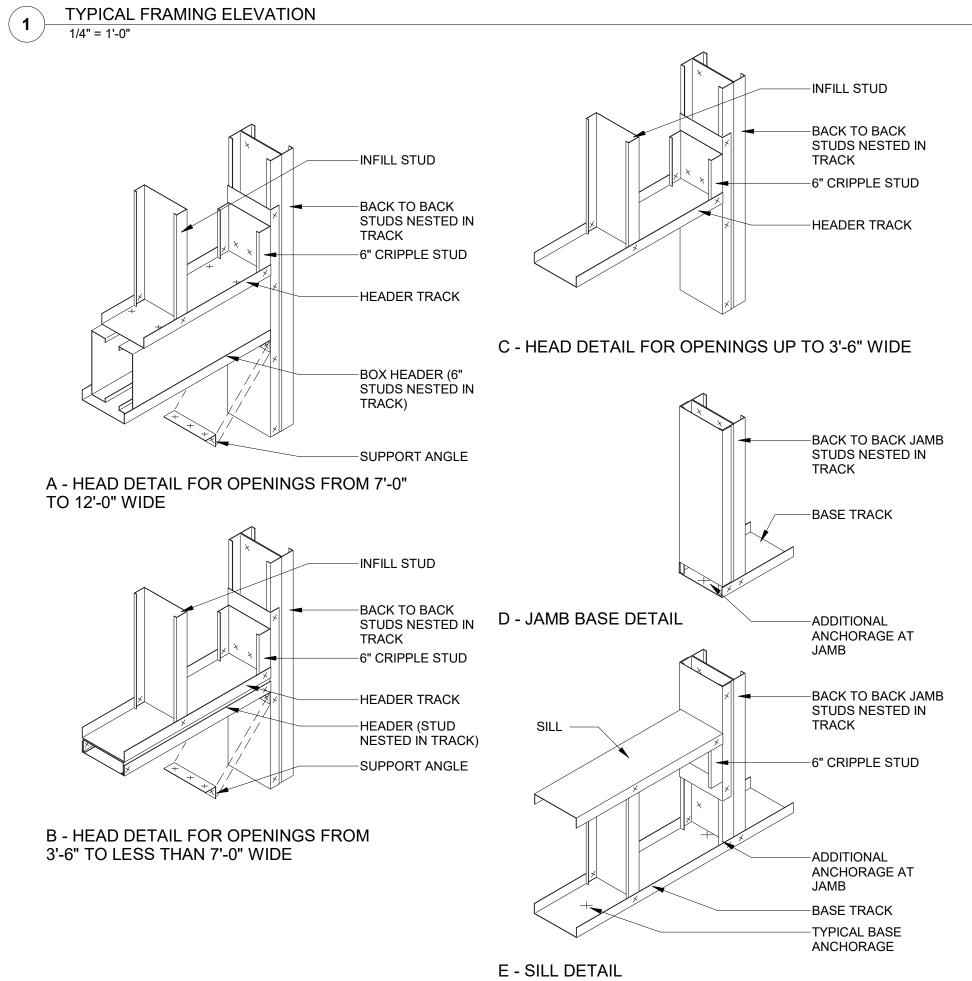

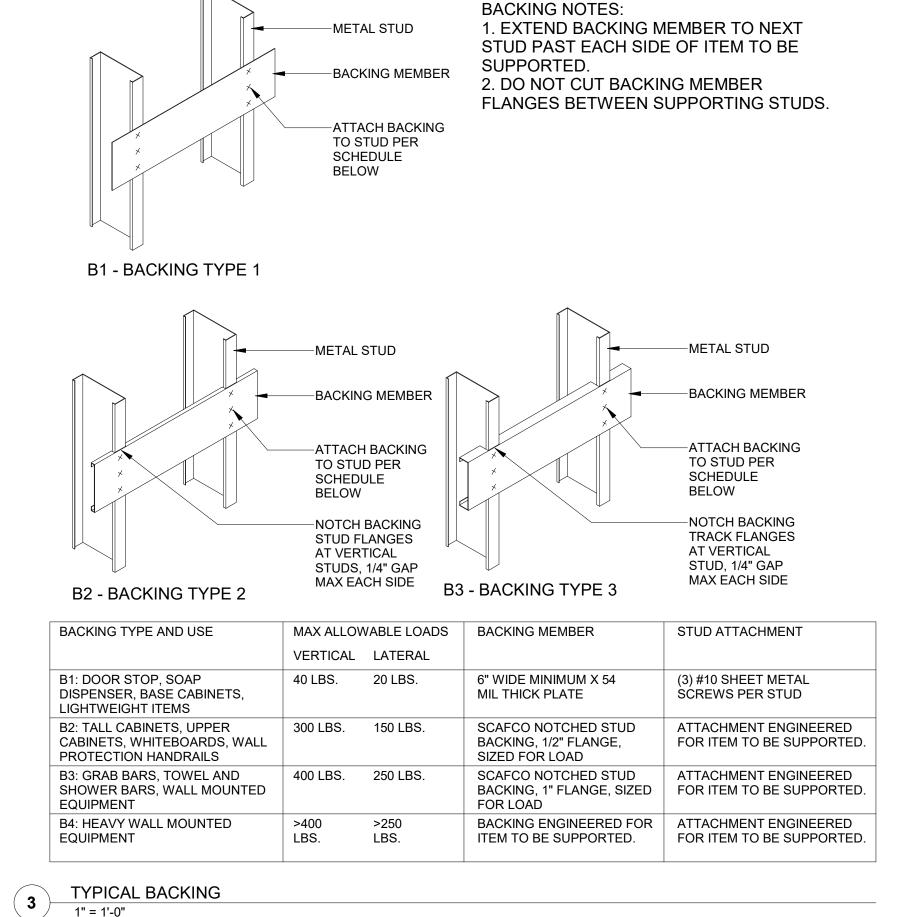

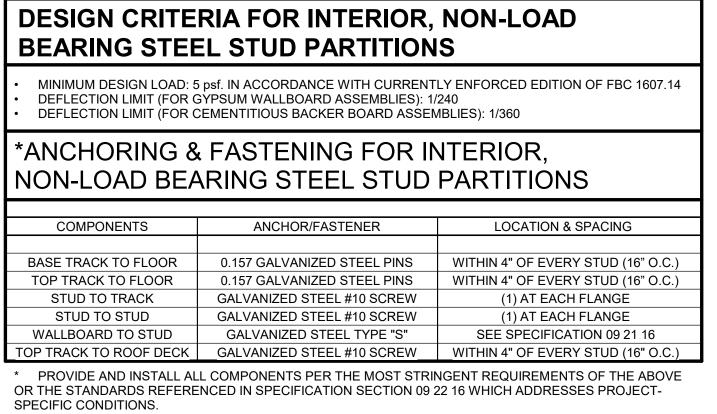

-CONTROL JOINT DOOR/STOREFRONT ABOVE OPENING FRAME BELOW--CRIPPLE STUD ABOVE OPENING -SAFING INSULATION PACKED STUDS-TIGHTLY, CONT. FULL HEIGHT

FRAMING DETAIL CONTROL JOINT

PARTITION FRAMING SHEET NOTES

- 1. PROVIDE AND CONSTRUCT INTERIOR FRAMED PARTITION ASSEMBLIES IN CONFORMANCE TO REQUIREMENTS OF SPECIFICATION SECTIONS 09 2216. . PROVIDE AND CONSTRUCT INTERIOR FRAMED PARTITIONS IN CONFORMANCE TO THE REQUIREMENTS OF THE CURRENTLY ENFORCED EDITIONS OF THE FLORIDA BUILDING CODE INCLUDING, BUT NOT LIMITED TO
- SECTION 2211, AND TO APPLICABLE SECTIONS OF AISI S200. 3. PROVIDE FOR AND CONSTRUCT FIRE RATED INTERIOR FRAMED PARTITIONS PER RATED DETAILS SHOWN IN G-SERIES SHEETS. 4. SEE TAGGED FLOOR PLANS FOR PARTITION TYPE LOCATIONS. SEE A410
- SERIES SHEETS FOR INFORMATION RELATED TO SPECIFIC ASSEMBLY REQUIREMENTS. 5. FULLY SEPARATE ALL DISSIMILAR METALS BY USING CONTINUOUS SELF-
- ADHERING WATERPROOFING MEMBRANE OR BRUSHED-ON MASTIC

6. USE STAINLESS STEEL FASTENERS WHERE CONNECTING COMPONENTS MADE OF DISSIMILAR METALS.

FSU BIO UNIT ONE TEACHING LABS

FLORIDA STATE UNIVERSITY 89 CHIEFTAN WAY, TALLAHASSEE, FL 32306

KEY PLAN

ARCHITECT

WALKER ARCHITECTS

2035 NW 13TH STREET

MEPF ENGINEER

WALTER P. MOORE

TAMPA FL 33602

813.221.2424

352.376.5500

AFFILIATED ENGINEERS

12921 SW 1 ROAD, #205 NEWBERRY, FL 32669

STRUCTURAL ENGINEER

201 E KENNEDY BLVD #700

SEAL AND SIGNATURE

SUBMITTAL:

REVISION

50% CONSTRUCTION DOCUMENTS

DESCRIPTION

ISSUE DATE:

DATE

07/23/2024

GAINESVILLE, FL 32609


352.672.6448 AA26002009

DRAWING TITLE: PARTITION TYPES AND **DETAILS**

PROJECT NO.: 23055-00 DRAWN BY: AH CHECKED BY: JMO

1" = 1'-0"

TYPICAL OPENING

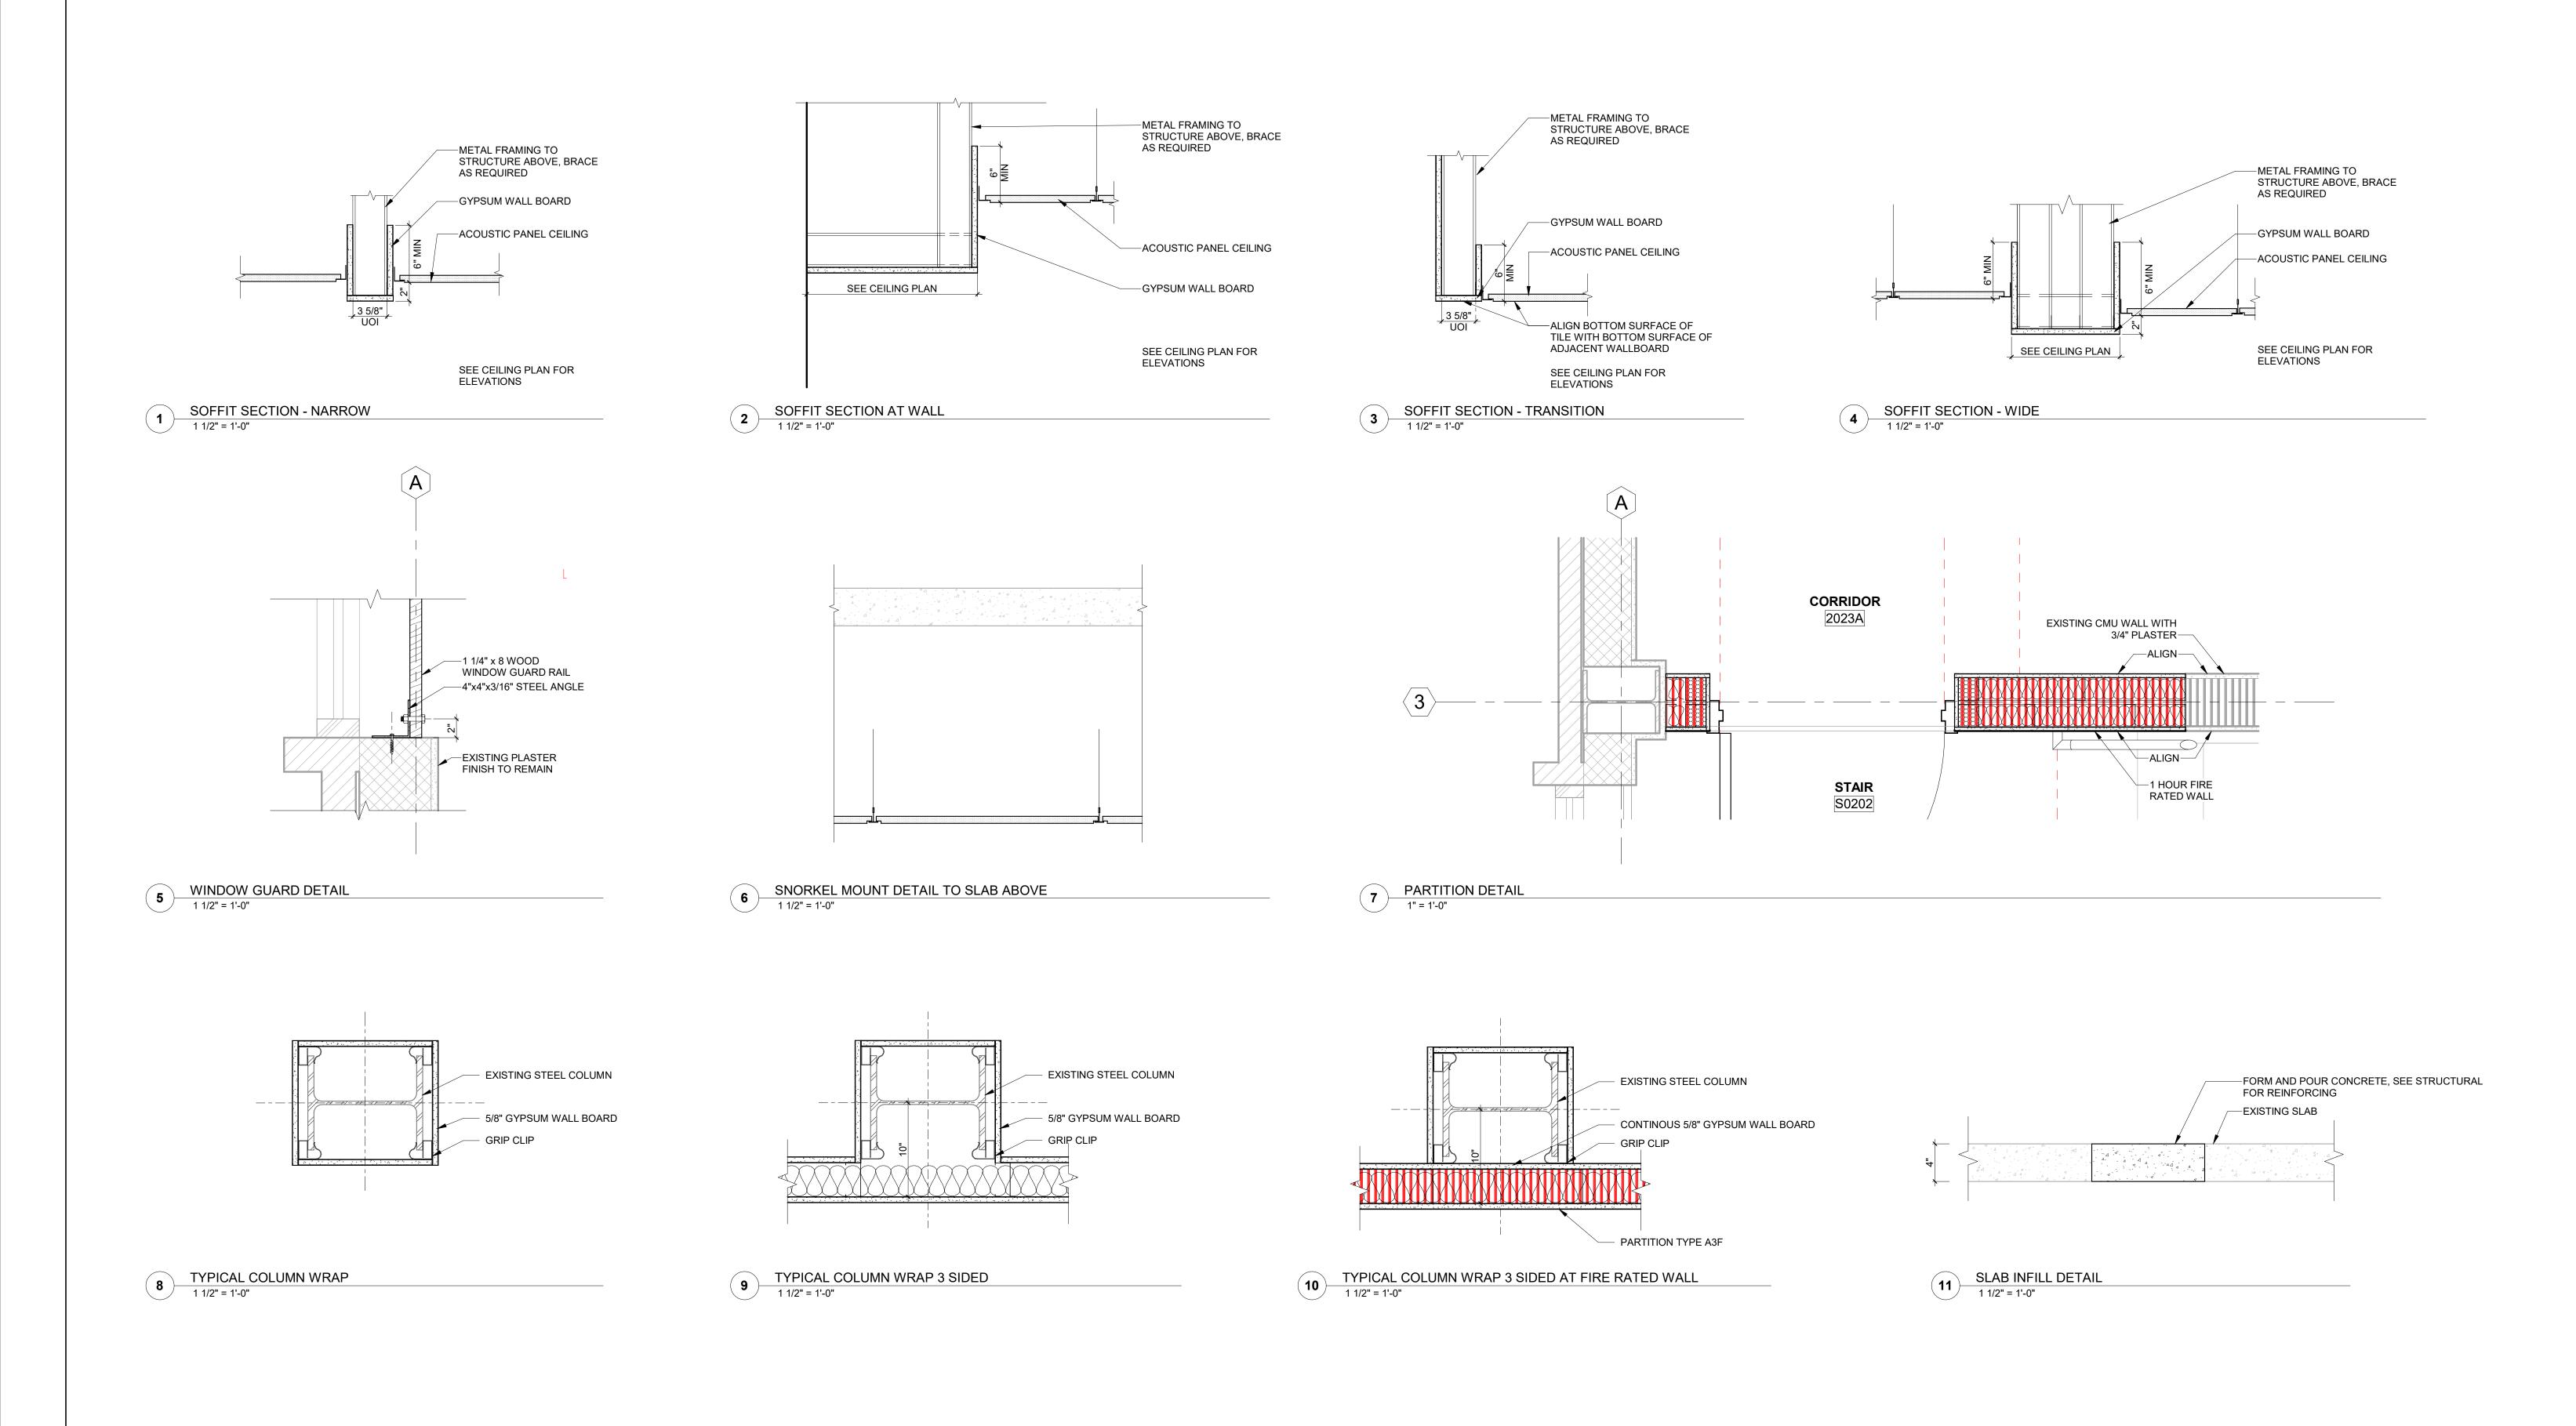



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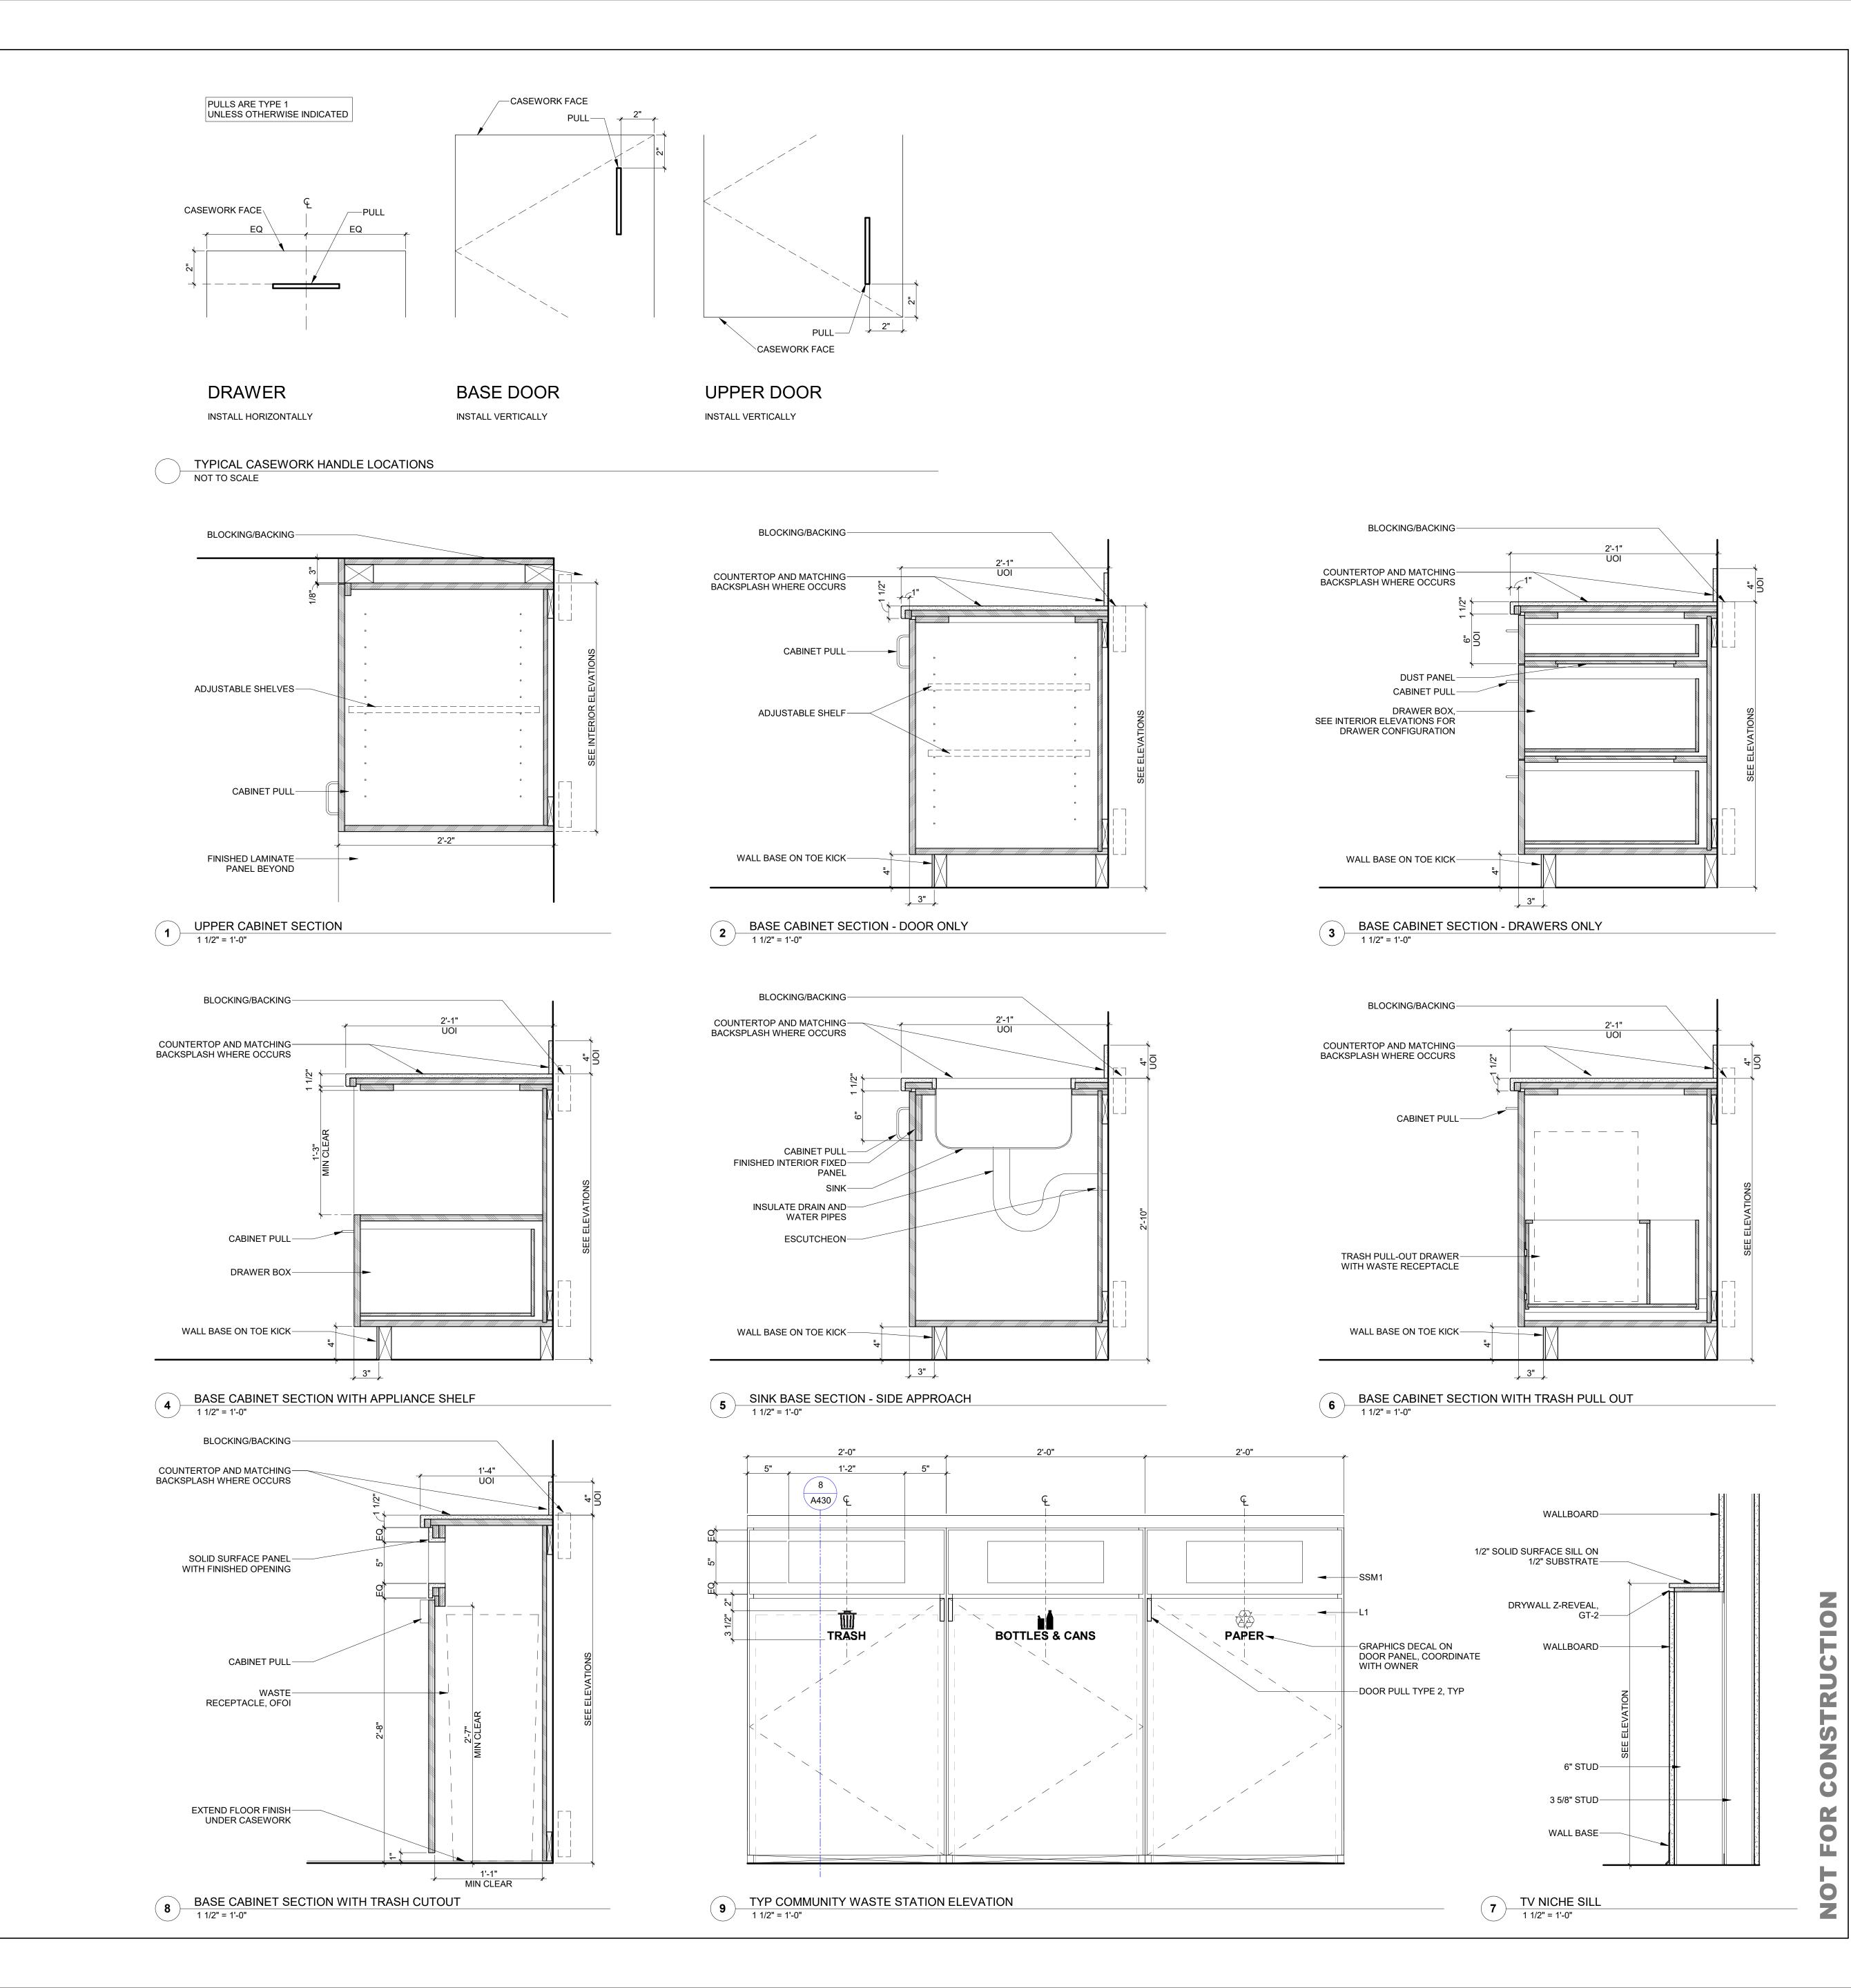
ISSUE DATE: 50% CONSTRUCTION DOCUMENTS 07/23/2024 DESCRIPTION DATE REVISION

> **FSU BIO UNIT ONE TEACHING LABS**

FLORIDA STATE UNIVERSITY, 89 CHIEFTAN WAY, TALLAHASSEE, FL 32306

KEY PLAN

INTERIOR DETAILS



Walker Architects

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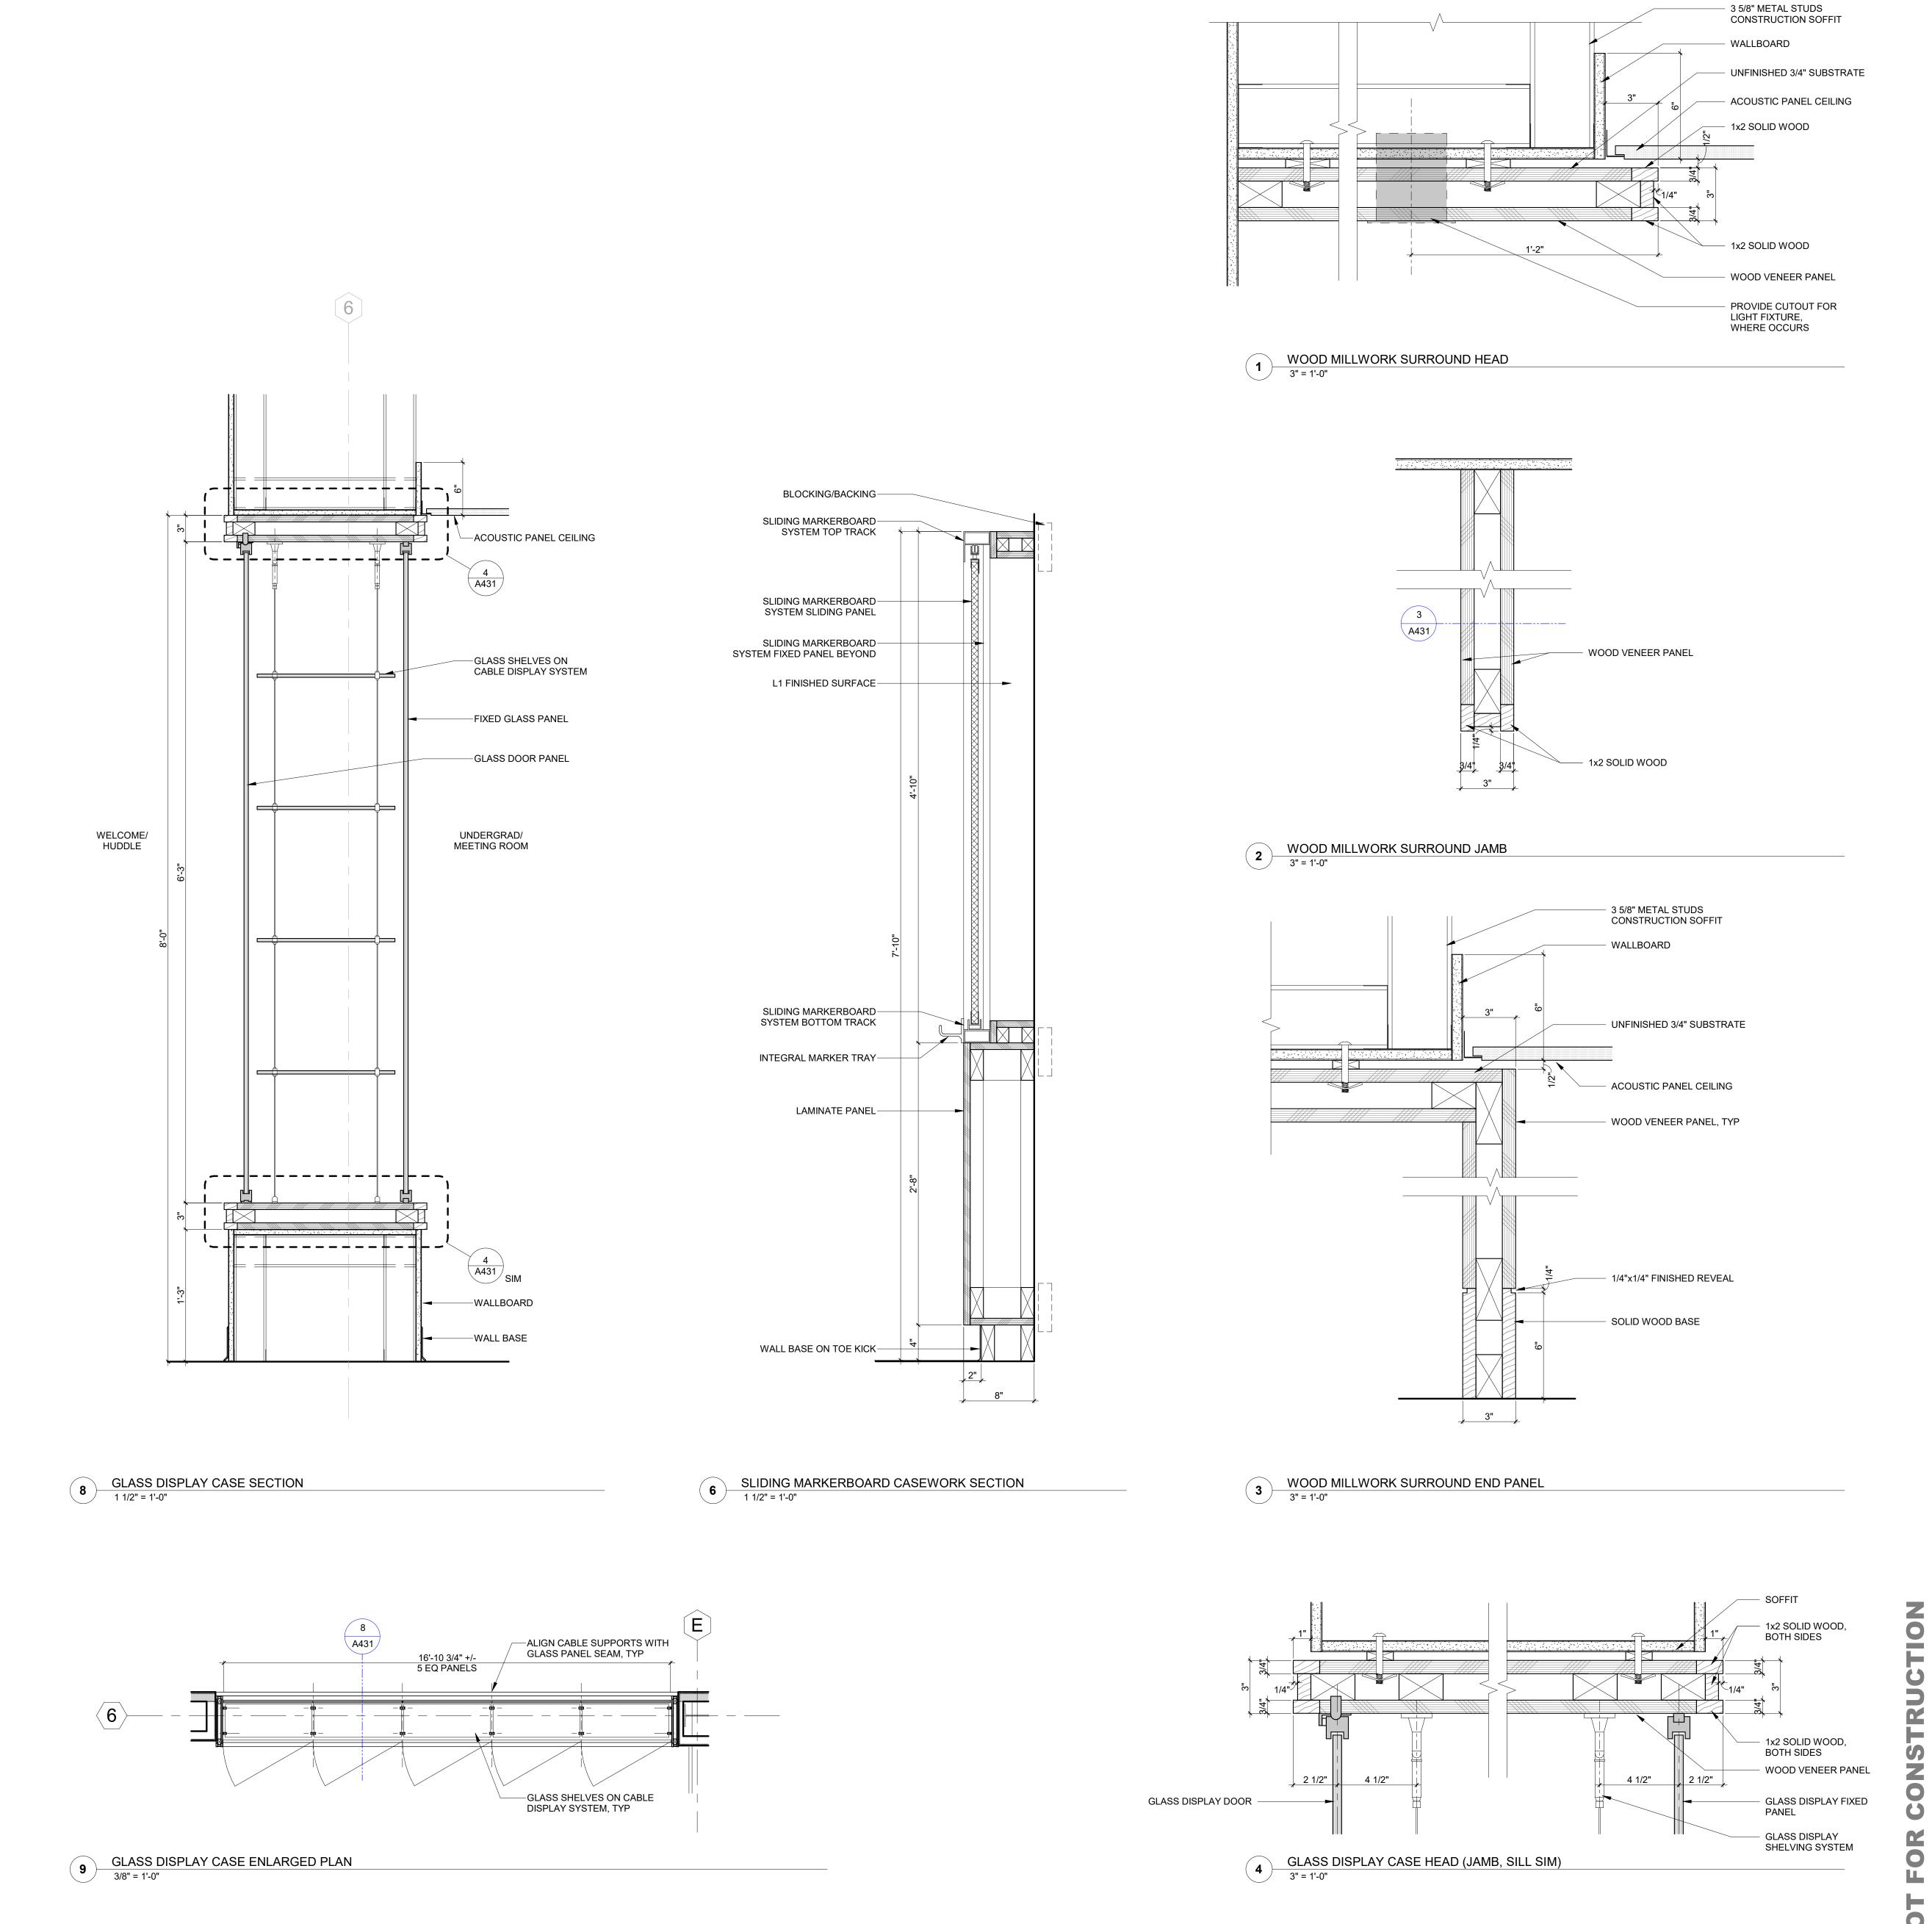
KEY PLAN

AWING TITLE:

INTERIOR CASEWORK

DETAILS

A430



Walker Architects

ARCHITECT

WALKER ARCHITECTS
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FSU BIO UNIT
ONE TEACHING
LABS

FLORIDA STATE UNIVERSITY, 89 CHIEFTAN WAY, TALLAHASSEE, FL 32306

KEY PLAN

DRAWING TITLE:

INTERIOR CASEWORK

DETAILS

PROJECT NO.: 23055-00 DRAWN BY:
CHECKED BY:

OPENING SCHEDULE SHEET NOTES

1. SEE SHEET A500 FOR DETAIL REFERENCES UNLESS INDICATED OTHERWISE.

DOOR AND FRAME ABBREVIATIONS:

AL ALUMINUM HM HOLLOW METAL

P PAINT . WD WOOD WD# WOOD FINISH TYPE

GLASS ABBREVIATIONS: IG# INSULATED GLASS TYPE G# MONOLITHIC GLASS TYPE

COMMENTS ABBREVIATIONS: CR CARD / CREDENTIAL READER DPS DOOR POSITION SWITCH

RX REQUEST TO EXIT

OPENING ELEVATION SHEET NOTES

1. DIMENSIONING RULES:

A. OUTSIDE DIMENSIONS a. OUTSIDE DIMENSIONS SHOWN ARE TO THE ROUGH OPENING (OR FRAME EDGE AT OUTSIDE CORNERS). ADJUST FRAME DIMENSIONS INWARD TO ACCOMMODATE SHIM/SEALANT SPACE

B. DOOR DIMENSIONS A. DIMENSIONS SHOWN ARE TO EDGE OF FRAMING. HOLD CLEAR OPENING FOR NOMINAL DOOR SIZE INDICATED.


C. EQUALITY A. EQ INDICATES INTENT IS FOR EQUAL DAYLIGHT OPENINGS ACROSS PANEL RUNS. ADJUST FRAME POSITIONS TO ACCOMMODATE SHIM/SEALANT SPACE AND END MULLION WIDTHS IN ORDER TO PROVIDE EQUAL DAYLIGHT OPENINGS.


GLAZING: A. EXTERIOR


a. IG1 - TYPICAL UNLESS INDICATED OTHERWISE

a. G1 - TYPICAL UNLESS INDICATED OTHERWISE 3. DECORATIVE WINDOW FILM

A. INTERIOR a. F1 - TYPICAL AS INDICATED

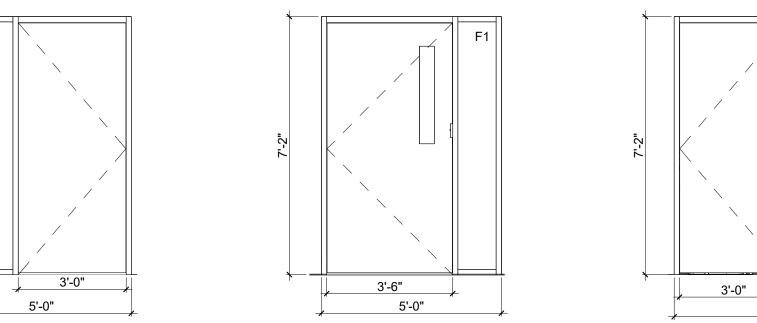

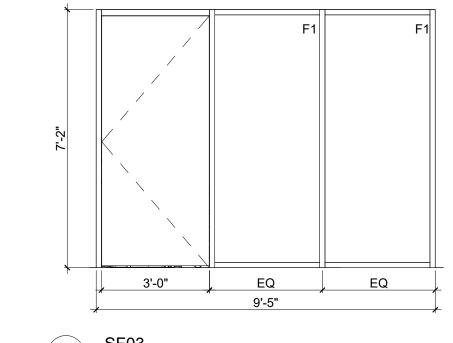

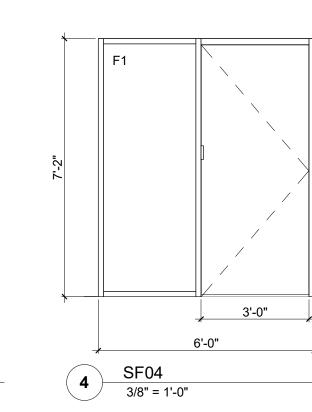

ARCHITECT

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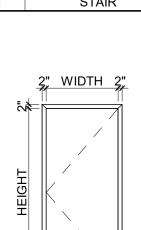
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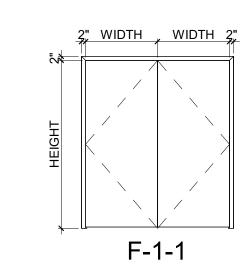
GAINESVILLE, FL 32609


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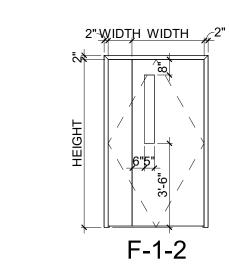



F-1


OPENING TYPES






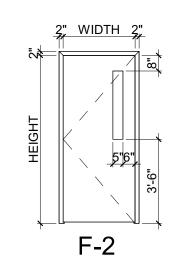

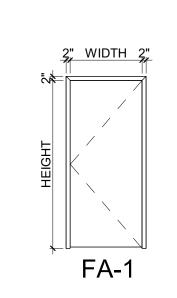

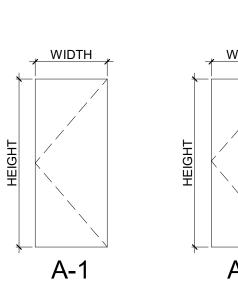


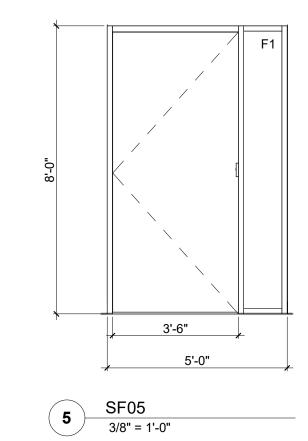



5'-0"


OPENING DETAIL SHEET NOTES


1. REFER TO PARTITION PLAN FOR PARTITION TYPE 2. PROVIDE SPRAY APPLIED FOAM INSULATION AT HEAD AND JAMB OF OPENINGS IN PARTITIONS INDICATED TO RECEIVE ACOUSTIC

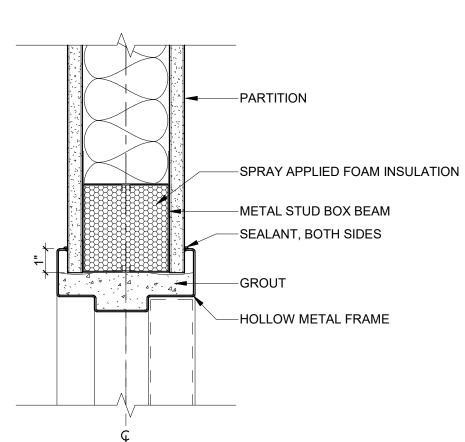

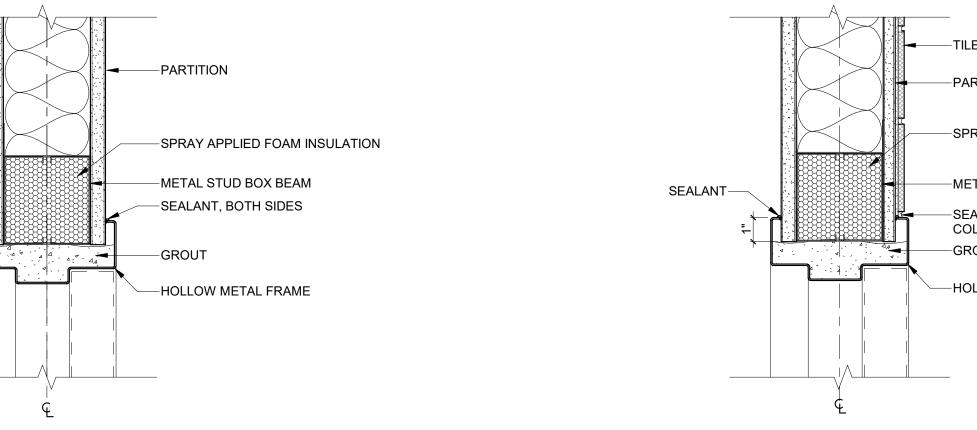


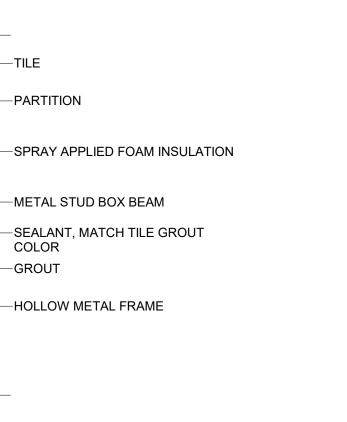

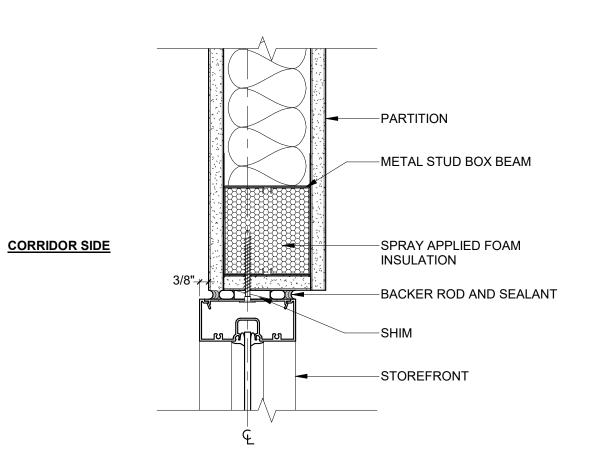


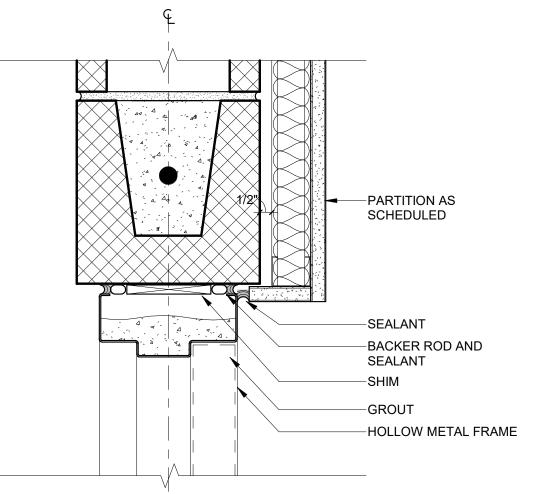




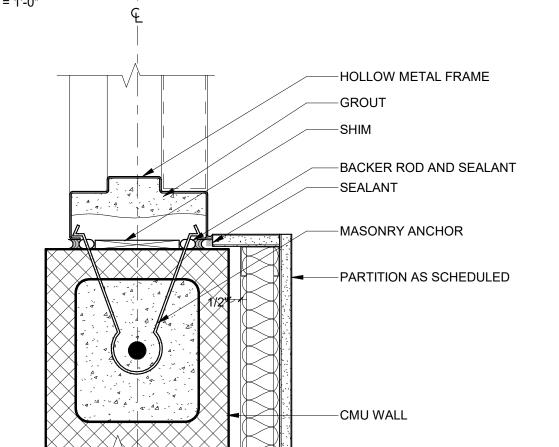



D2 HOLLOW METAL DOOR JAMB DETAIL - CMU
3" = 1'-0"

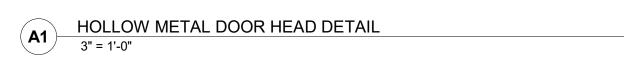

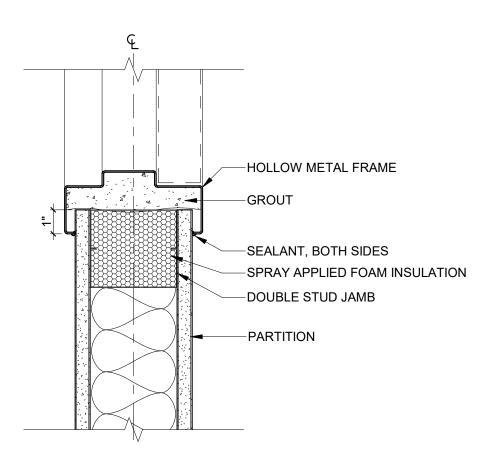



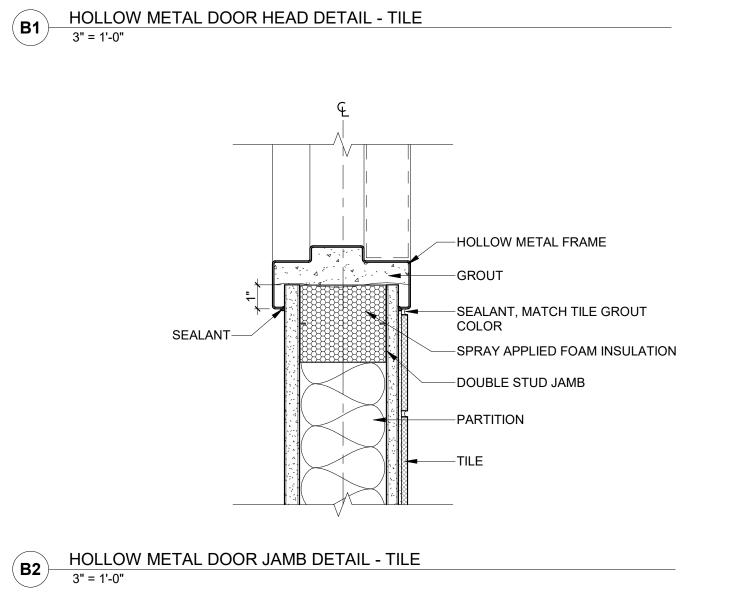

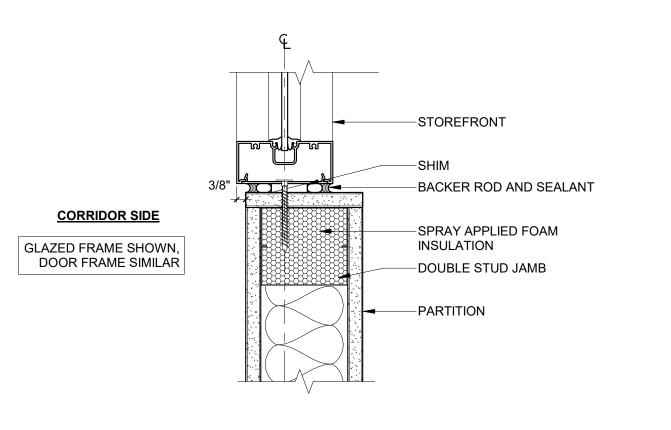

C2 INTERIOR STOREFRONT JAMB DETAIL
3" = 1'-0"

C1 INTERIOR STOREFRONT HEAD DETAIL
3" = 1'-0"

KEY PLAN

OPENING TYPES, SCHEDULE, AND DETAILS

