
#### PIPING SYMBOLS AND ABBREVIATIONS

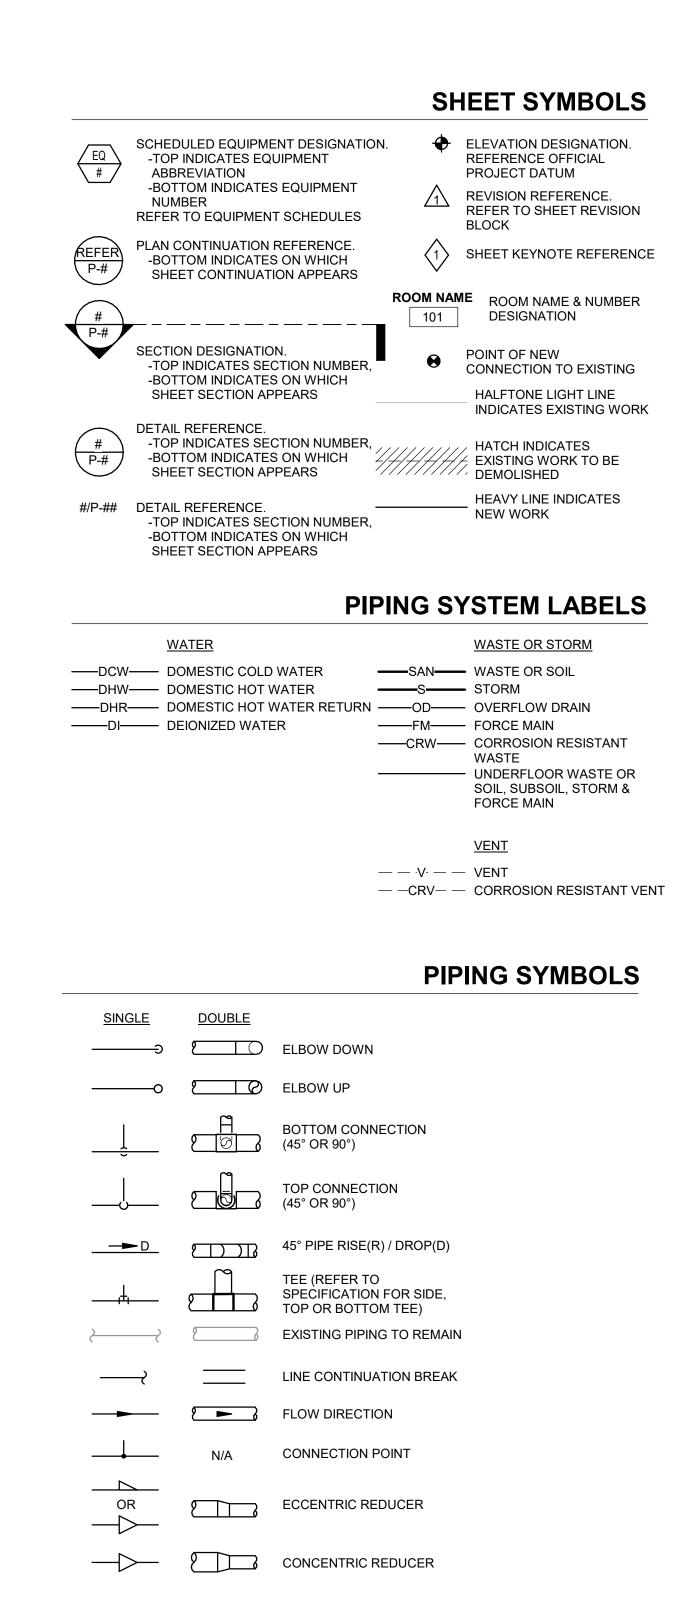

#### PIPE FITTINGS, VALVES, & SPECIALTIES ——Ū—— PLUG VALVE EXPANSION JOINT — GATE VALVE ———— PIPE FLEXIBLE CONNECTION — ✓ DIAPHRAGM VALVE DIRECTION OF PITCH (DOWN) —IÒI— BALL VALVE GENERAL PIPELINE STRAINER WITHOUT DRAIN ——— BUTTERFLY VALVE ——||—— FLANGE CHECK VALVE ——||—— UNION ————] PIPE CAP — ├── PRESSURE REDUCING VALVE ──────── THERMOSTATIC MIXING VALVE THERMOMETER PRESSURE GAUGE PRESSURE RELIEF VALVE (WITH GAUGE VALVE) \_\_\_\_\_\_ WATER HAMMER ARRESTOR ——⊃≯ VALVE IN VERTICAL → HOSE BIBB → WALL HYDRANT → OUTLET **DRAINS AND CLEANOUTS** ☐ Ø FLOOR DRAIN/FLOOR SINK ○── FIXTURE WASTE TRAP O—lı CLEANOUT ROOF DRAIN HUB DRAIN FLOOR CLEANOUT

#### **ABBREVIATIONS**

			ABBREVIATIONS
A AAP ACC ACFM ADB	<ul> <li>AIR</li> <li>AREA ALARM PANEL</li> <li>ACCESS</li> <li>ACTUAL CUBIC FEET PER MINUTE</li> <li>ACID DILUTION BASIN</li> </ul>	L LA LAV LBS LTG	<ul><li>LENGTH</li><li>LABORATORY COMPRESSED A</li><li>LAVATORY</li><li>POUNDS</li><li>LIGHTING</li></ul>
ADJ AFF ALT AMPS	- ADJUSTABLE - ABOVE FINISHED FLOOR - ALTERNATE	LWT MAP MAX	<ul><li>LEAVING WATER TEMPERATURE</li><li>MASTER ALARM PANEL</li></ul>
AP	<ul> <li>AMPERES</li> <li>ACCESS PANEL</li> <li>APPROXIMATE</li> <li>ARCHITECTURAL</li> <li>AMERICAN SOCIETY OF MECHANICAL ENGINEERS</li> <li>ASSEMBLY</li> </ul>	MB MBH MC MEZZ MFR MH	- MECHANICAL CONTRACTOR - MEZZANINE - MANUFACTURER - MANHOLF
BHP BLDG BOP BOT	<ul><li>BRAKE HORSEPOWER</li><li>BUILDING</li><li>BOTTOM OF PIPE ELEVATION</li><li>BOTTOM</li></ul>	MIN MISC MTD MTG	- MISCELLANEOUS
BT BTU BTUH BTWN	- BOTTOM - BATHTUB - BRITISH THERMAL UNIT - BRITISH THERMAL UNITS PER HOUR - BETWEEN	NC NIC NO NOM NPSH NPT	
CA CFCI	- COMPRESSED AIR - CONTRACTOR FURNISHED CONTRACTOR INSTALLED - CUIT DE FEET PER MINUTE	NTS OC OD	<ul><li>NOT TO SCALE</li><li>ON CENTER</li><li>OUTSIDE DIAMETER /</li></ul>
CLG CM CMU CO CO2 CONN	<ul> <li>CEILING</li> <li>COFFEE MAKER</li> <li>CONCRETE MASONRY UNIT</li> <li>CLEANOUT</li> <li>CARBON DIOXIDE</li> <li>CONNECTION / CONNECT</li> </ul>	OFCI OFOI	OVERFLOW DRAIN  OWNER FURNISHED, CONTRACTOR INSTALLED  OWNER FURNISHED, OWNER INSTALLED
CONTR CORR CS CTR CU CRVTR CWW D	- CONTRACTOR - CORRIDOR - CLINICAL SINK / COLD SOFT WATER / CUP SINK - CENTER - COPPER - CORROSIVE VENT THROUGH ROOF - CLEARWATER WASTE - DEPTH / DRAIN LINE - DOMESTIC COLD WATER	P PC PH PIV PLBG PRESS PRV PSF PSI PSIG	<ul><li>PLUMBING</li><li>PRESSURE</li><li>PRESSURE REDUCING VALVE</li><li>POUNDS PER SQUARE FOOT</li></ul>
DET DFU DHR DHW DIA DIM DISCH DN DS DW DWG	- DETAIL - DRAINAGE FIXTURE UNIT - DOMESTIC HOT WATER RETURN - DOMESTIC HOT WATER - DIAMETER - DIMENSION - DISCHARGE - DOWN / DOWNSPOUT NOZZLE - DOWNSPOUT - DISHWASHER - DRAWING	R RAD RD REC RECPT REF	- RADIUS - REFRIGERATED AIR DRYER - ROOF DRAIN - RECESSED - RECEPTACLE - REFERENCE - REQUIRED
EA EEW EFF EJ ELEC ELEV EQUIP ET ETR ES EWC EWT	<ul> <li>EACH</li> <li>EMERGENCY EYEWASH</li> <li>EFFICIENCY</li> <li>EXPANSION JOINT</li> <li>ELECTRICAL</li> <li>ELEVATION</li> <li>EQUIPMENT</li> <li>EXPANSION TANK</li> <li>EXISTING TO REMAIN</li> <li>EMERGENCY SHOWER</li> <li>ELECTRIC WATER COOLER</li> <li>ENTERING WATER TEMPERATURE</li> <li>EXPANSION</li> <li>EXTERIOR</li> </ul>	S SAN SCH SCFM SD SF SH SHT SPEC SQ SR S/S STD STRU SUCT	- STANDARD CUBIC FEET PER MINUTE - SUBSOIL DRAIN - SQUARE FEET - SHOWER - SHEET - SPECIFICATION - SQUARE - SERVICE RECEPTOR - STAINLESS STEEL - STRUCTURAL / STRUCTURE
FLR FM FP FPM FS FSEC	<ul> <li>FAHRENHEIT</li> <li>FLOOR CLEANOUT</li> <li>FLOOR DRAIN</li> <li>FULL LOAD AMPERES</li> <li>FLOOR</li> <li>FORCE MAIN</li> <li>FIREPROOF</li> <li>FEET PER MINUTE</li> <li>FLOOR SINK</li> <li>FOOD SERVICE EQUIPMENT CONTRACTOR</li> <li>FEET</li> <li>FEET</li> <li>FEET HEAD</li> </ul>	TD TDH	- TRENCH DRAIN - TOTAL DYNAMIC HEAD - TEMPERATURE - THERMOSTATIC MIXING VALVE - TOP OF BEAM - TOP OF DECK - TOP OF JOIST - TOP OF SLAB / TOP OF STEEL - TRAP FILLER
FTG  G GA GAL GALV GC GPH GPM	<ul> <li>FOOTING</li> <li>GAS</li> <li>GAUGE</li> <li>GALLON</li> <li>GALVANIZED</li> <li>GENERAL CONTRACTOR</li> <li>GALLONS PER HOUR</li> <li>GALLONS PER MINUTE</li> </ul>	UR V VAC VEL VFD VOL VTR	<ul><li>VELOCITY</li><li>VARIABLE FREQUENCY DRIVE</li><li>VOLUME</li></ul>
HB HD	- HOSE BIBB - HUB DRAIN - HORSEPOWER - HOSE REEL - HEAT TRACE HOT WATER - HEATER - HEATING, VENTILATING, & AIR CONDITIONING - HERTZ	W W/ W/O WAGD WB WC WCO WGE WH	<ul> <li>WASTE ANESTHETIC</li> <li>GAS DISPOSAL</li> <li>WALL BOX</li> <li>WATER CLOSET</li> <li>WALL CLEANOUT</li> <li>WASTE GAS EXHAUST</li> <li>WALL HYDRANT</li> </ul>
IE IM	<ul> <li>INSIDE DIAMETER</li> <li>INVERT ELEVATION</li> <li>ICE MAKER</li> <li>INCHES</li> <li>INCHES WATER COLUMN</li> </ul>	WHA WHTR WSFU X	<ul><li>WATER HAMMER ARRESTOR</li><li>WATER HEATER</li></ul>
IW JS	- INCHES WATER COLOMIN - INDIRECT WASTE - JANITOR'S SINK	YCO ZVB	- YARD CLEANOUT - ZONE VALVE BOX
KW	- KII OWATT		

KW - KILOWATT

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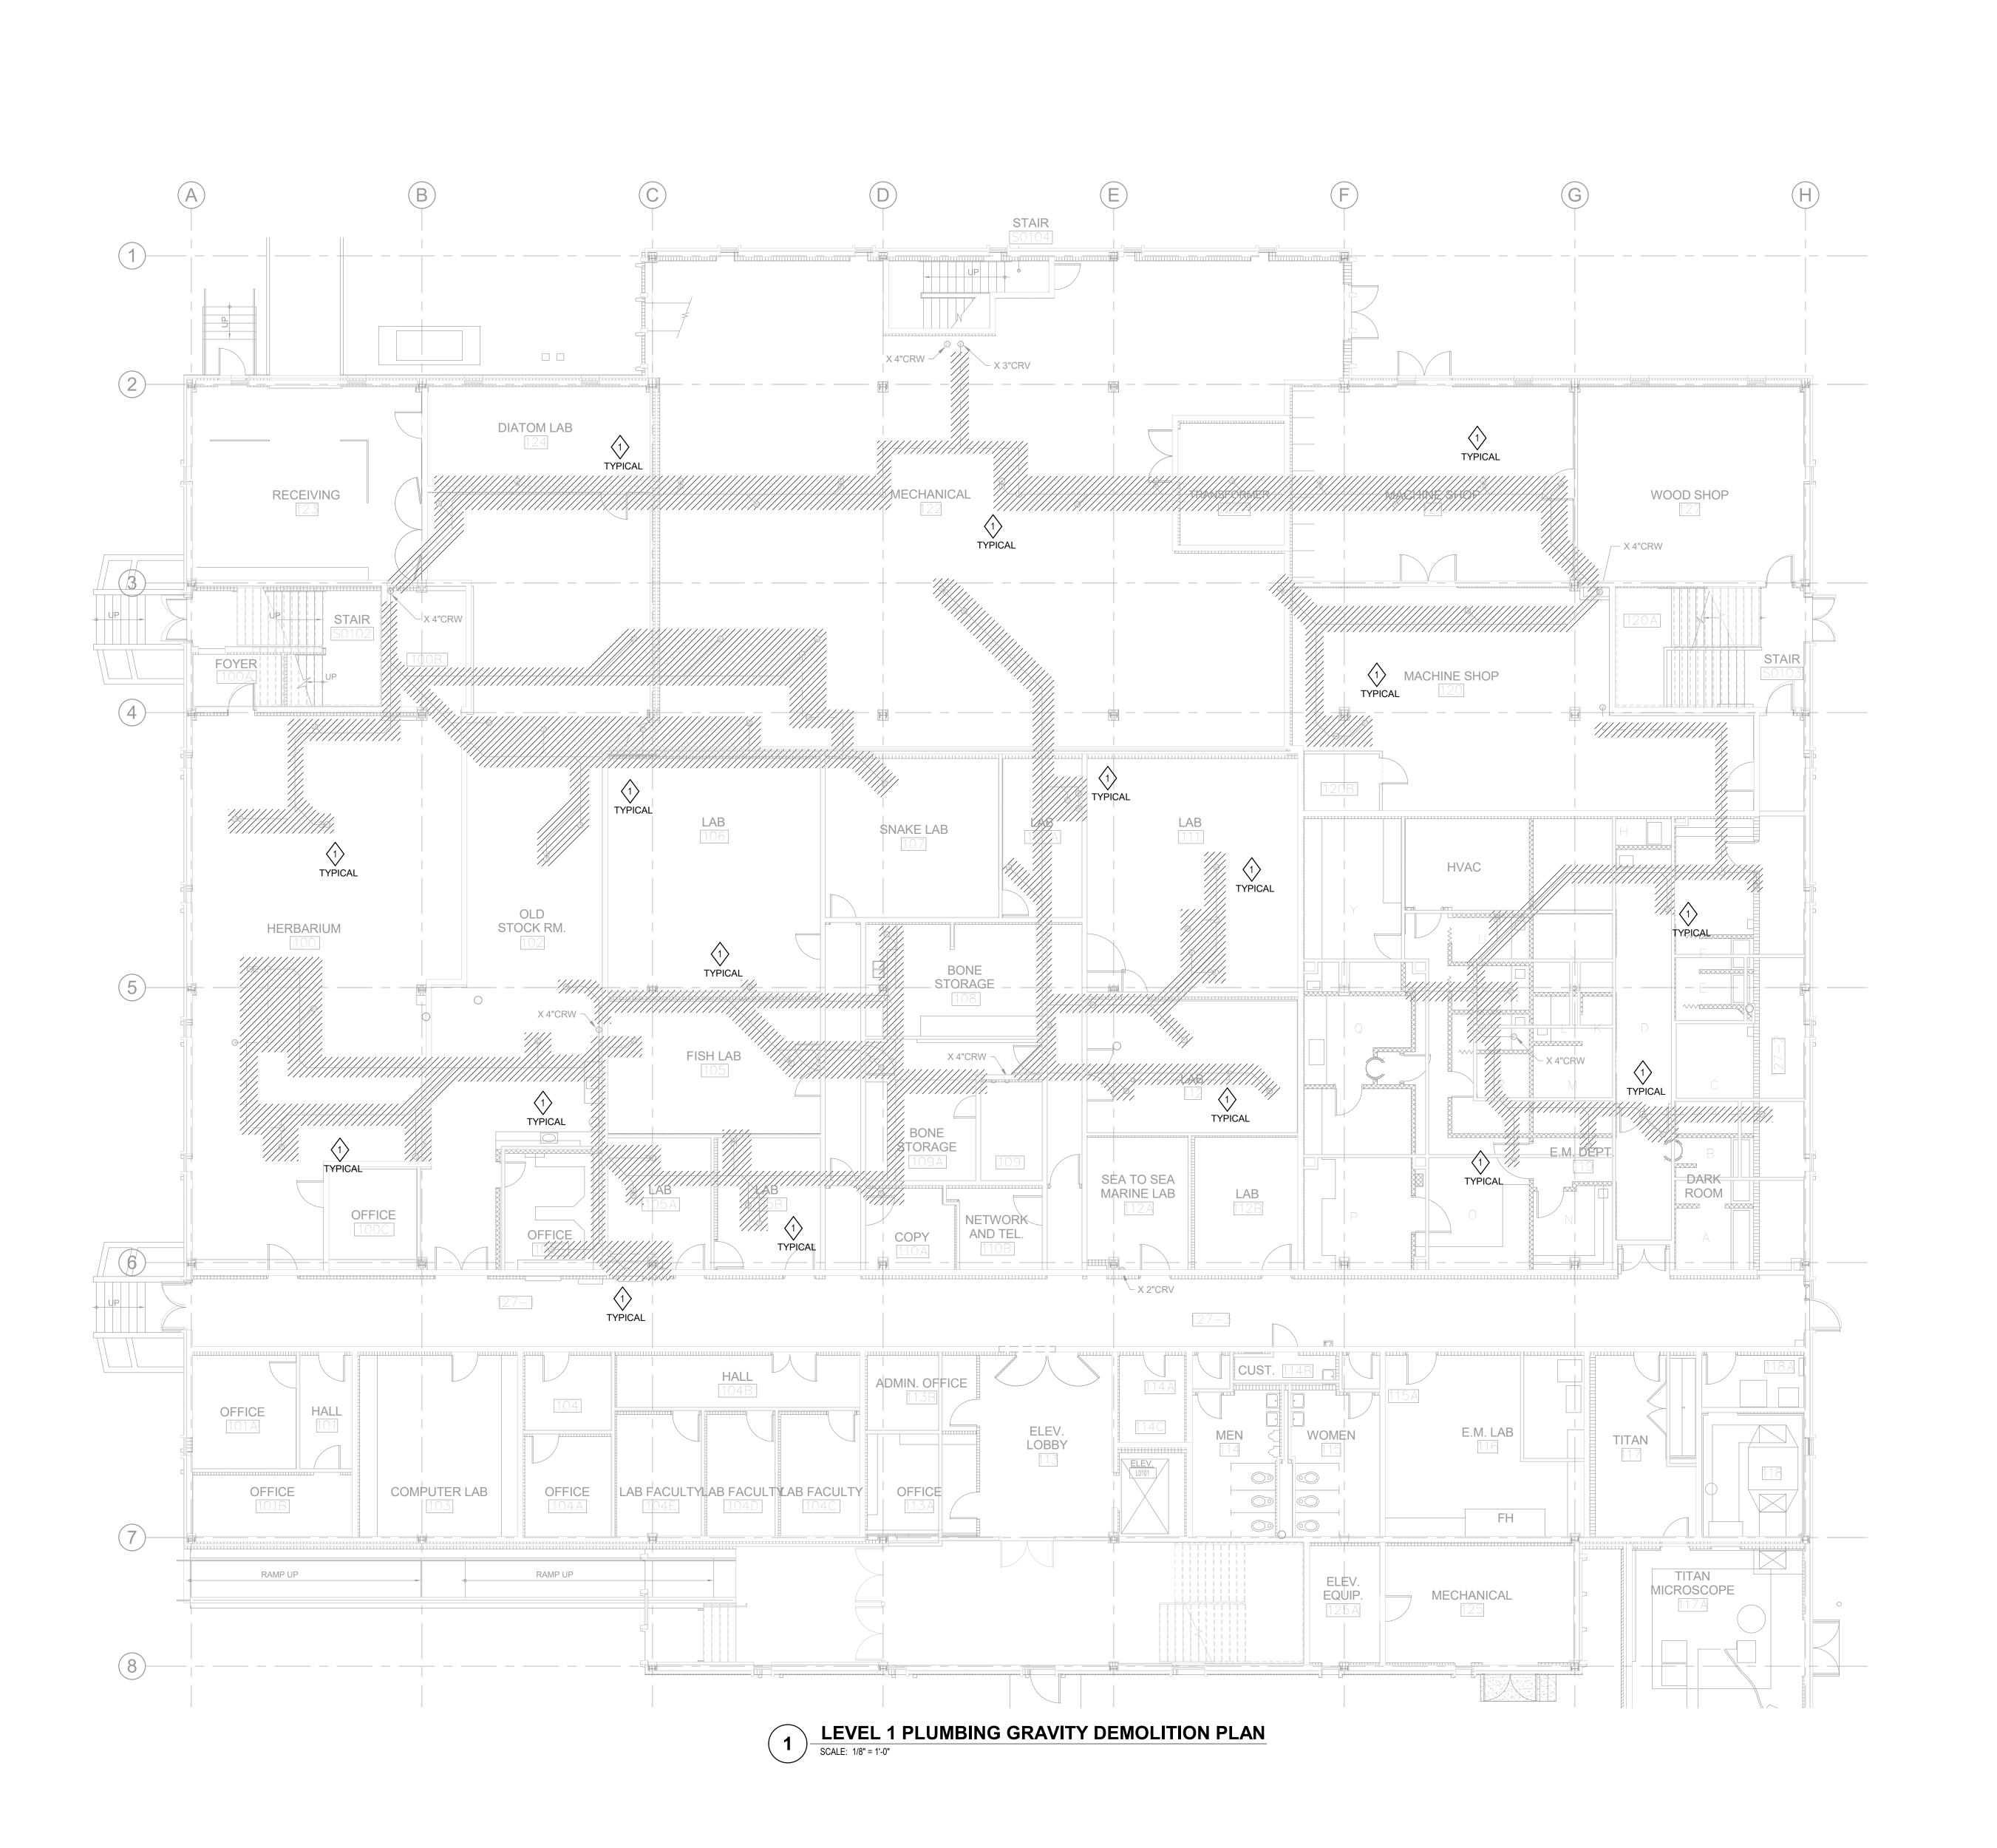
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KEY PLAN

DRAWING TITLE

PLUMBING SYMBOLS AND ABBREIVATIONS

PROJECT NO.: 23055-00 DRAWN BY: RAN
CHECKED BY: KAW



- 1. EXISTING CONDITIONS ARE TAKEN FROM ORIGINAL AND "AS-BUILT" DRAWINGS AND ARE, IN PART, UNVERIFIED. VERIFY ALL FIELD CONDITIONS PRIOR TO FABRICATION AND INSTALLATION OF NEW
- 2. DEMOLISH ALL WASTE AND VENT PIPING WITHIN HATCHED AREAS, UNLESS OTHERWISE NOTED.
- 3. EXISTING BUILDING ELEMENTS AND DISTRIBUTION, INCLUDING BUT NOT LIMITED TO WALLS, CEILINGS, LIGHTS, CONDUIT, DUCTS, PIPING, INSULATION, OR OTHER SYSTEMS THAT ARE DAMAGED OR REMOVED DUE TO CONTRACTOR'S WORK SHALL BE PATCHED, REPAIRED, OR REPLACED BY THE CONTRACTOR TO THE SATISFACTION OF THE ENGINEER, THE OWNER, AND AUTHORITIES HAVING JURISDICTION.
- 4. ABANDON PIPING THAT IS CONCEALED BEHIND EXISTING FINISHED SURFACES (WALLS, CEILINGS, FLOOR SLAB) WHERE SURFACES ARE DESIGNATED TO REMAIN. WHERE ABANDONED PIPING PENETRATES EXISTING SURFACES, CAP PIPE BEHIND THESE SURFACES SO THE ABANDONED PIPING IS COMPLETELY CONCEALED. PATCH AS REQUIRED TO MATCH SURROUNDING EXISTING SURFACES.
- 5. DUE TO THE IMPORTANCE OF MAINTAINING
  OPERATIONS AT THIS FACILITY, CONTRACTOR
  SHALL COORDINATE WITH OWNER ALL WORK
  THAT REQUIRES THE SHUTDOWN OF EXISTING
  AND STARTUP OF NEW UTILITIES PRIOR TO START.
  WORK MAY BE REQUIRED TO BE PERFORMED AT
  NIGHT, ON WEEKENDS AND/OR OVER HOLIDAYS.
- 6. WHERE REQUIRED, PROVIDE ADDITIONAL DEMOLITION BEYOND THAT SHOWN TO FACILITATE INSTALLATION OF NEW WORK.
- FOLLOWING DEMOLITION, CAP ALL OPEN-ENDED PIPES AND RE-INSULATE OR REPAIR INSULATION WHERE REQUIRED.

#### **SHEET KEYNOTES**

 DEMOLISH ALL WASTE PIPING SERVING FIXTURES BEING DEMOLISHED ON SECOND FLOOR ABOVE. CAP PIPE AT RISER. PATCH AND REPAIR FLOOR PENETRATIONS TO MATCH EXISTING. Walker Archite

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KEY PLAN




DRAWING TITLE:

LEVEL 1 PLUMBING GRAVITY DEMOLITION PLAN

PROJECT NO.: 23055-00 DRAWN BY: RAN
CHECKED BY: KAW

**PD101** 

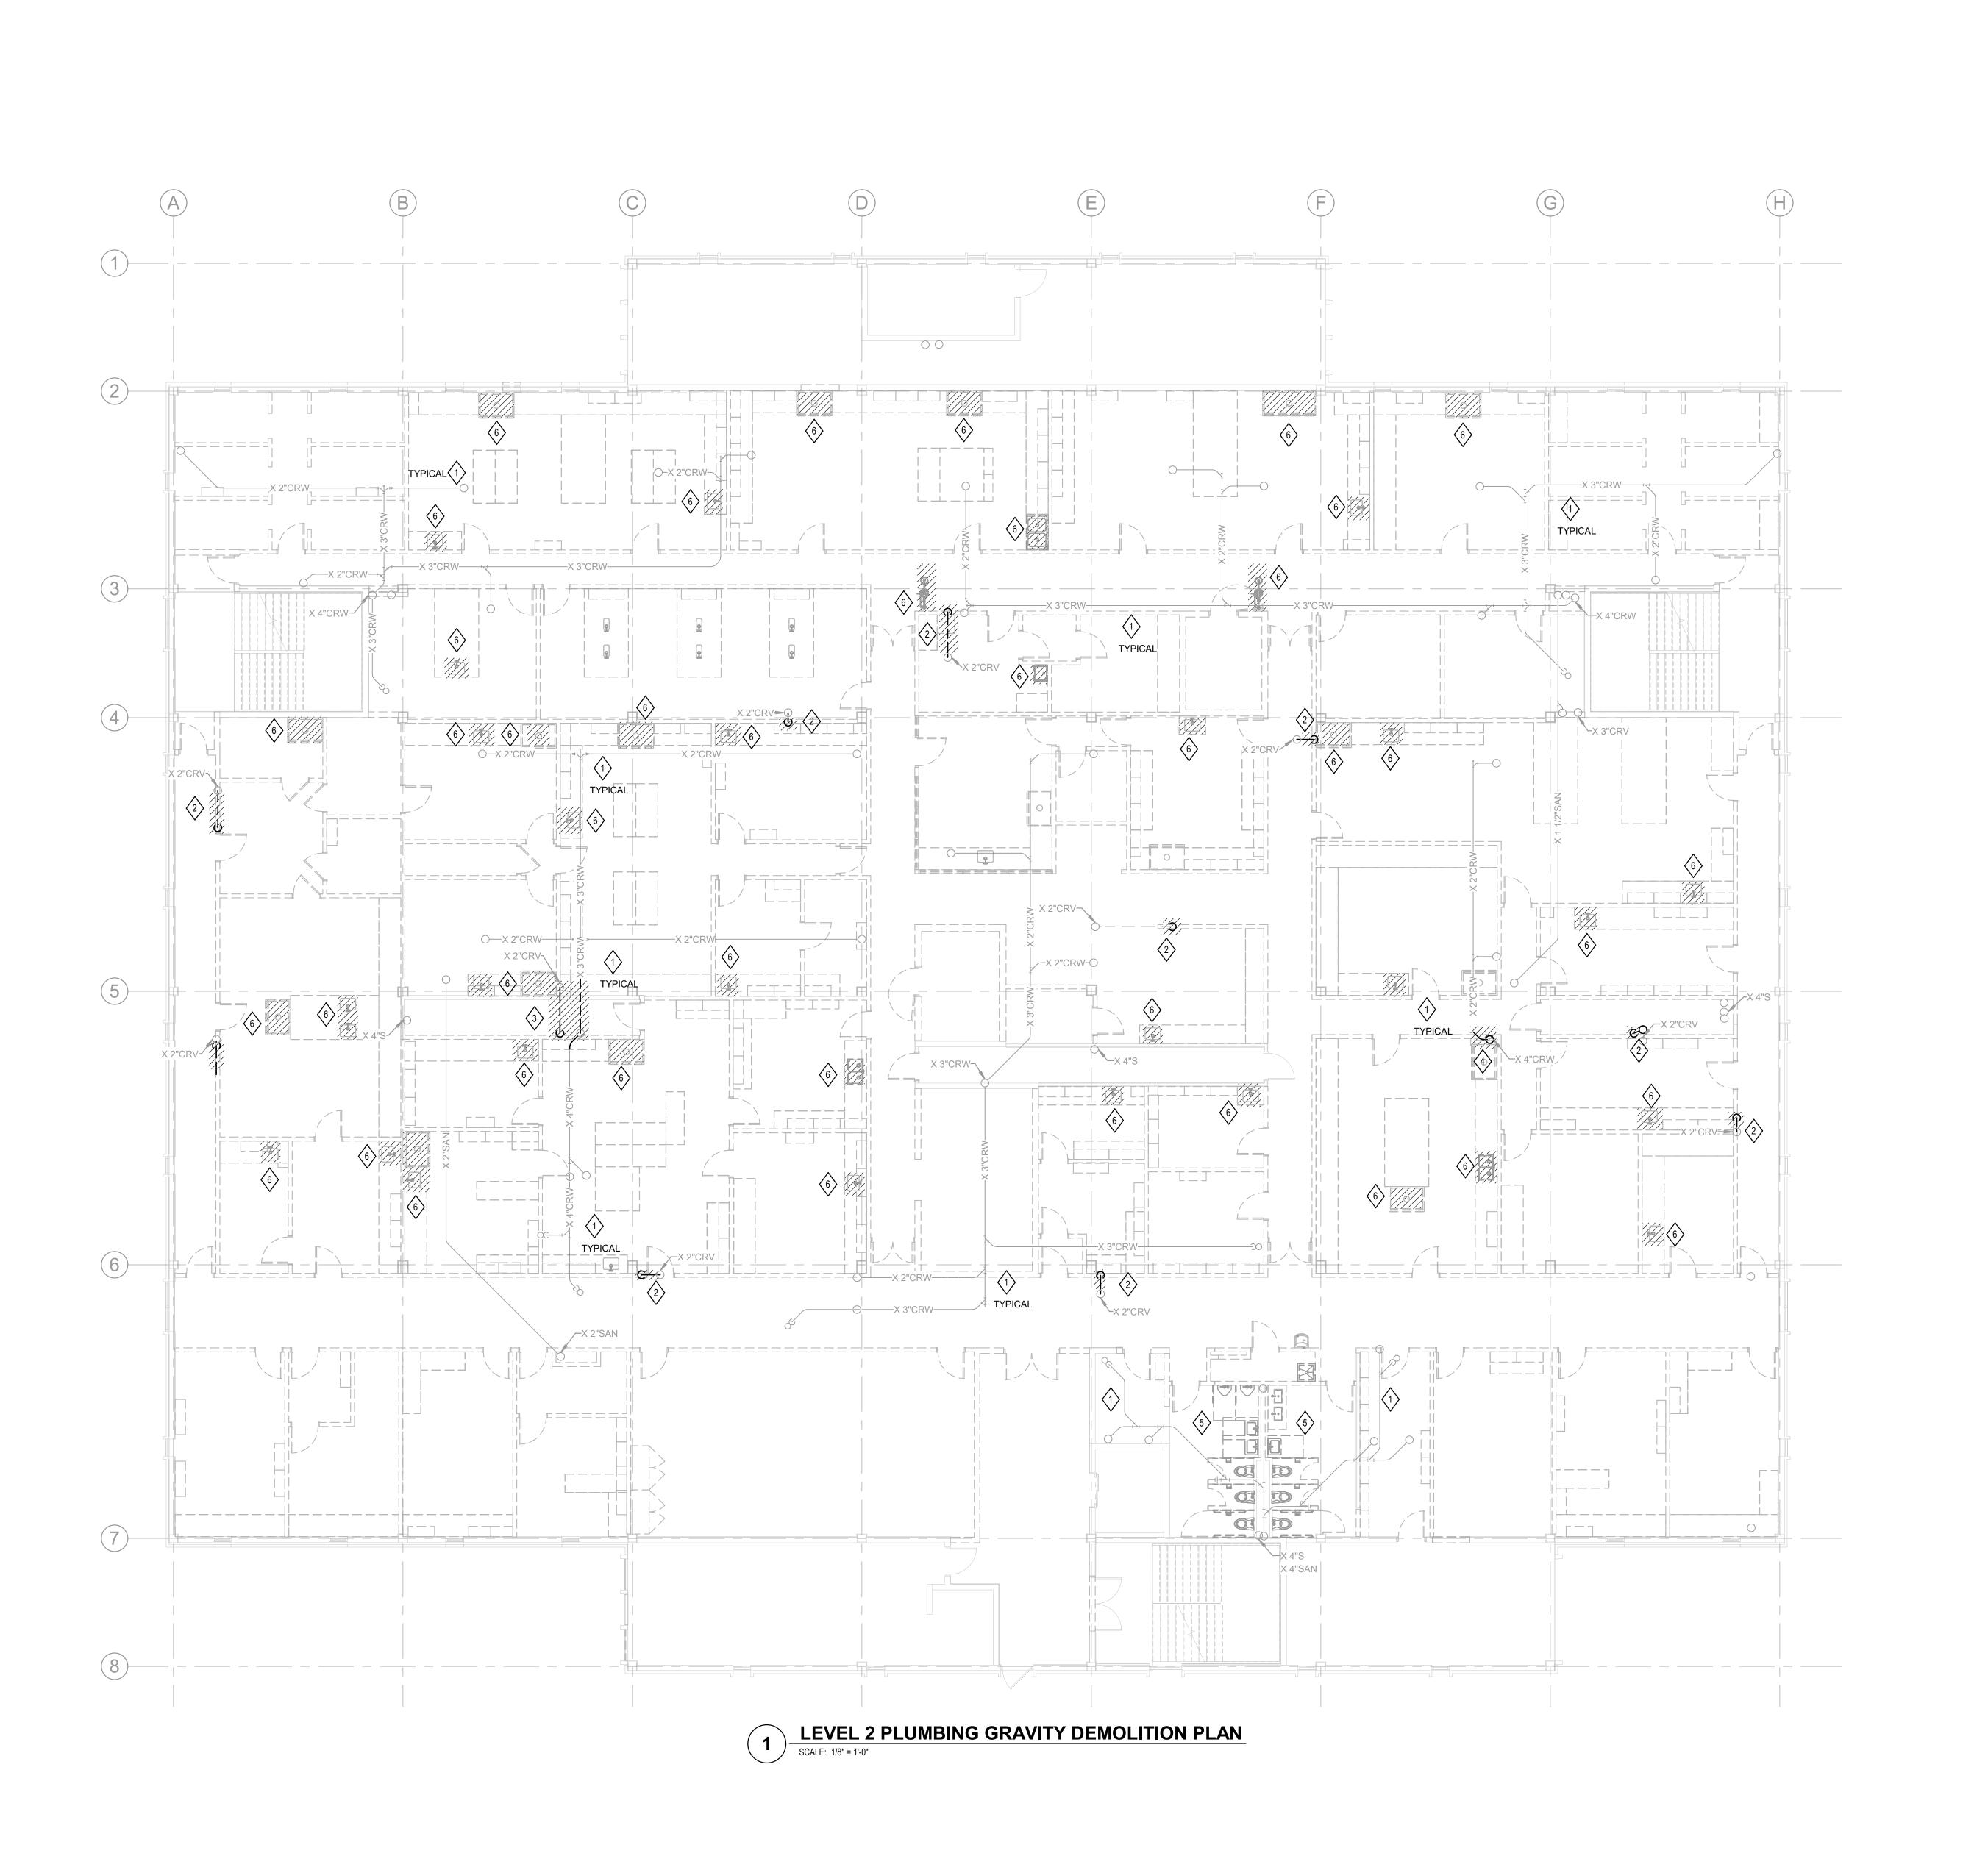

- EXISTING CONDITIONS ARE TAKEN FROM ORIGINAL AND "AS-BUILT" DRAWINGS AND ARE, IN PART, UNVERIFIED. VERIFY ALL FIELD CONDITIONS PRIOR TO FABRICATION AND INSTALLATION OF NEW WORK.
- 2. DEMOLISH ALL WASTE AND VENT PIPING WITHIN HATCHED AREAS, UNLESS OTHERWISE NOTED.
- 3. EXISTING BUILDING ELEMENTS AND DISTRIBUTION, INCLUDING BUT NOT LIMITED TO WALLS, CEILINGS, LIGHTS, CONDUIT, DUCTS, PIPING, INSULATION, OR OTHER SYSTEMS THAT ARE DAMAGED OR REMOVED DUE TO CONTRACTOR'S WORK SHALL BE PATCHED, REPAIRED, OR REPLACED BY THE CONTRACTOR TO THE SATISFACTION OF THE ENGINEER, THE OWNER, AND AUTHORITIES HAVING JURISDICTION.
- 4. ABANDON PIPING THAT IS CONCEALED BEHIND EXISTING FINISHED SURFACES (WALLS, CEILINGS, FLOOR SLAB) WHERE SURFACES ARE DESIGNATED TO REMAIN. WHERE ABANDONED PIPING PENETRATES EXISTING SURFACES, CAP PIPE BEHIND THESE SURFACES SO THE ABANDONED PIPING IS COMPLETELY CONCEALED. PATCH AS REQUIRED TO MATCH SURROUNDING EXISTING SURFACES.
- 5. DUE TO THE IMPORTANCE OF MAINTAINING OPERATIONS AT THIS FACILITY, CONTRACTOR SHALL COORDINATE WITH OWNER ALL WORK THAT REQUIRES THE SHUTDOWN OF EXISTING AND STARTUP OF NEW UTILITIES PRIOR TO START. WORK MAY BE REQUIRED TO BE PERFORMED AT NIGHT, ON WEEKENDS AND/OR OVER HOLIDAYS.
- WHERE REQUIRED, PROVIDE ADDITIONAL DEMOLITION BEYOND THAT SHOWN TO FACILITATE INSTALLATION OF NEW WORK.
- FOLLOWING DEMOLITION, CAP ALL OPEN-ENDED PIPES AND RE-INSULATE OR REPAIR INSULATION WHERE REQUIRED.

#### **SHEET KEYNOTES**

- WASTE PIPING SHOWN SERVES THIRD FLOOR
  FIXTURES ABOVE AND SHALL BE EXISTING TO

  PEMAIN

  PEMAIN

  OUT

  THE PIPING SHOWN SERVES THIRD FLOOR
  FIXTURES ABOVE AND SHALL BE EXISTING TO

  PEMAIN

  PEMAIN

  THE PIPING SHOWN SERVES THIRD FLOOR
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  PEMAIN

  THE PIPING SHOWN SERVES THIRD FLOOR

  THE PIPING SHOWN SERVES THE PIPING SHOWN SERVES THIRD FLOOR

  THE PIPING SHOWN SERVES THE PIPING SHOWN
- 2. OFFSET CRV PIPE TO NEW 2ND FLOOR WALL.
- 3. OFFSET CRW AND CRV TO NEW PIPE SPACE.
- 4. RELOCATE CRW TO NEW PIPE SPACE.
- 5. DEMOLISH EXISTING BATHROOM FIXTURES AND JANITOR'S SINK TO BE REPLACED WITH NEW FIXTURES. DEMOLISH EXISTING CARRIERS AND HORIZONTAL WATER, WASTE, AND VENT PIPING IN CHASE. EXISTING WATER, WASTE, AND VENT VERTICAL RISERS TO REMAIN FOR RECONNECTION.
- 6. DEMOLISH EXISTING PLUMBING FIXTURES AND ASSOSIATED WASTE & VENT PIPING BACK TO THE MAIN OR RISERS.



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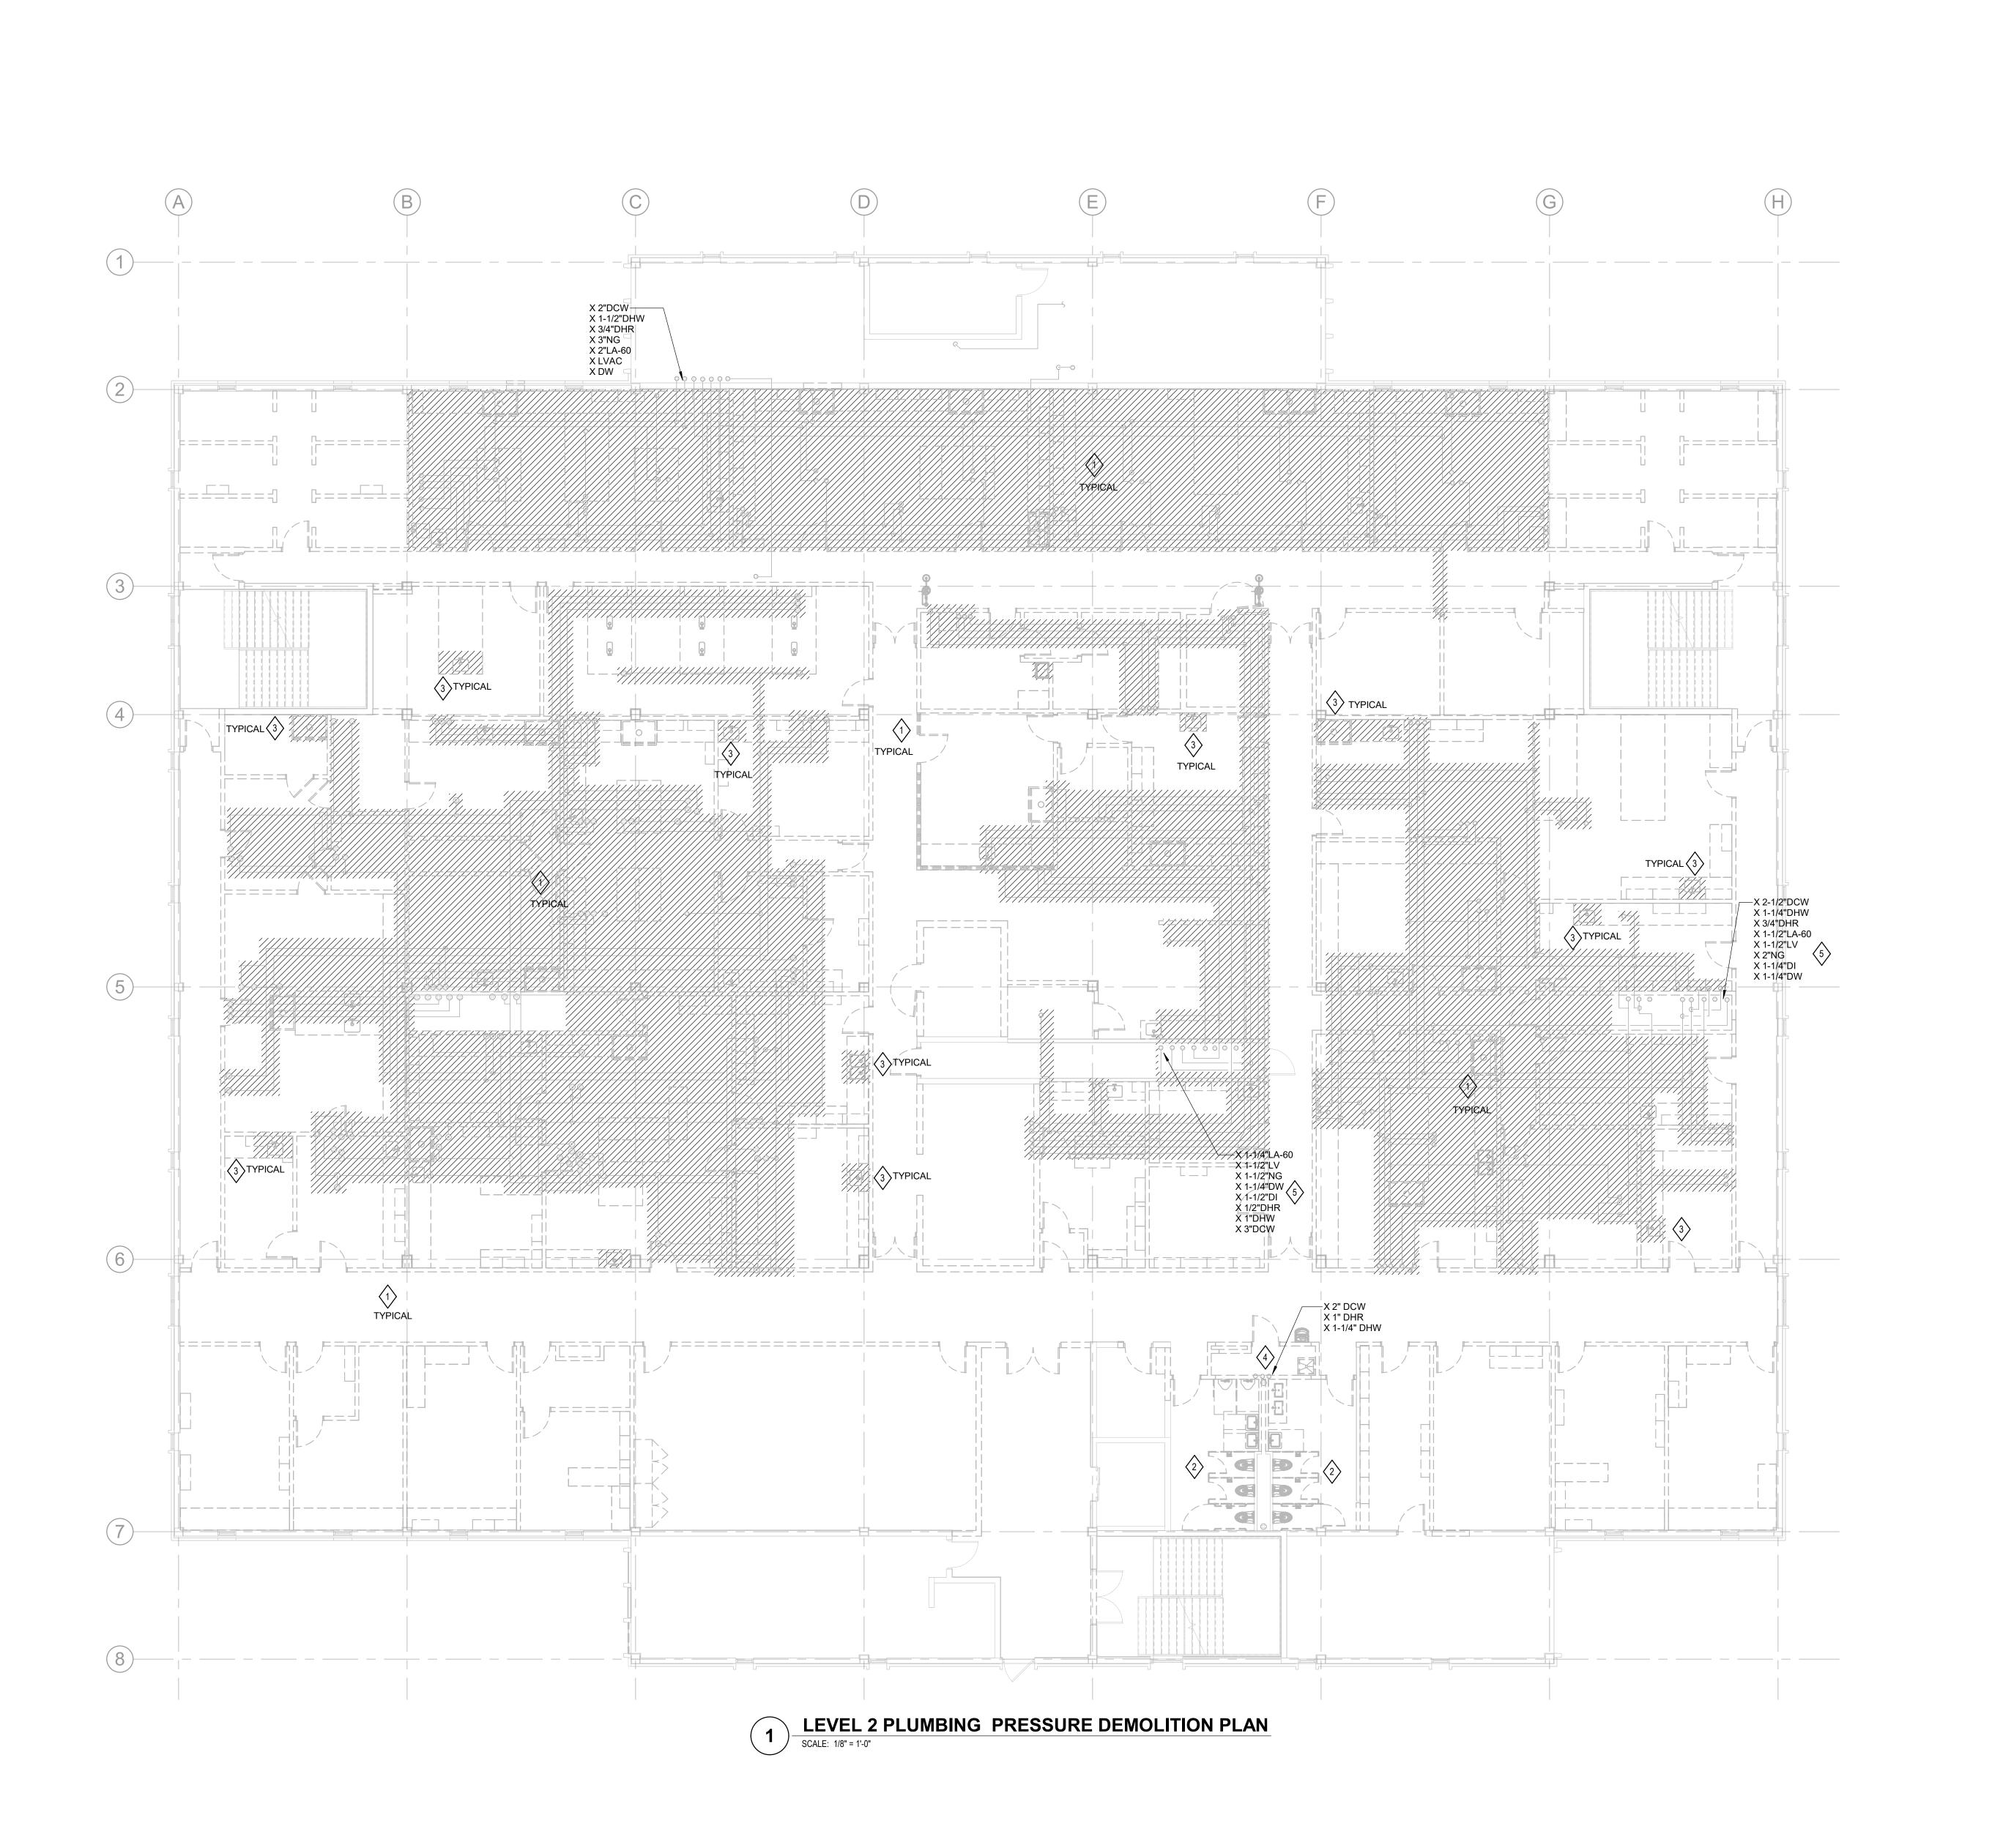


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LEVEL 2 PLUMBING GRAVITY DEMOLITION PLAN

PROJECT NO.: 23055-00 DRAWN BY: RAN
CHECKED BY: KAW

PD102



- EXISTING CONDITIONS ARE TAKEN FROM ORIGINAL AND "AS-BUILT" DRAWINGS AND ARE, IN PART, UNVERIFIED. VERIFY ALL FIELD CONDITIONS PRIOR TO FABRICATION AND INSTALLATION OF NEW WORK
- DEMOLISH ALL PLUMBING FIXTURES, EQUIPMENT, AND PIPING WITHIN HATCHED AREAS, UNLESS OTHERWISE NOTED.
- 3. EXISTING BUILDING ELEMENTS AND DISTRIBUTION, INCLUDING BUT NOT LIMITED TO WALLS, CEILINGS, LIGHTS, CONDUIT, DUCTS, PIPING, INSULATION, OR OTHER SYSTEMS THAT ARE DAMAGED OR REMOVED DUE TO CONTRACTOR'S WORK SHALL BE PATCHED, REPAIRED, OR REPLACED BY THE CONTRACTOR TO THE SATISFACTION OF THE ENGINEER, THE OWNER, AND AUTHORITIES HAVING JURISDICTION.
- 4. ABANDON PIPING THAT IS CONCEALED BEHIND EXISTING FINISHED SURFACES (WALLS, CEILINGS, FLOOR SLAB) WHERE SURFACES ARE DESIGNATED TO REMAIN. WHERE ABANDONED PIPING PENETRATES EXISTING SURFACES, CAP PIPE BEHIND THESE SURFACES SO THE ABANDONED PIPING IS COMPLETELY CONCEALED. PATCH AS REQUIRED TO MATCH SURROUNDING EXISTING SURFACES.
- 5. DUE TO THE IMPORTANCE OF MAINTAINING OPERATIONS AT THIS FACILITY, CONTRACTOR SHALL COORDINATE WITH OWNER ALL WORK THAT REQUIRES THE SHUTDOWN OF EXISTING AND STARTUP OF NEW UTILITIES PRIOR TO START. WORK MAY BE REQUIRED TO BE PERFORMED AT NIGHT, ON WEEKENDS AND/OR OVER HOLIDAYS.
- 6. WHERE REQUIRED, PROVIDE ADDITIONAL DEMOLITION BEYOND THAT SHOWN TO FACILITATE INSTALLATION OF NEW WORK.
- FOLLOWING DEMOLITION, CAP ALL OPEN-ENDED PIPES AND RE-INSULATE OR REPAIR INSULATION WHERE REQUIRED.
- LABORATORY FIXTURES ON SECOND FLOOR ARE PRIMARILY BOTTOM FED.

# **SHEET KEYNOTES**

- DEMOLISH ALL DOMESTIC WATER, PURE WATER, VACUUM, NATURAL GAS AND COMPRESSED AIR PIPING BACK TO RISERS. DEMOLISH ALL PLUMBING FIXTURES AND WATER COOLERS IN HATCHED AREA. ANY CAPPED PIPING FROM THE PREVIOUS LEVEL 3 DEMOLITION WORK SHALL BE REMOVED COMPLETLY.
- 2. DEMOLISH EXISTING BATHROOM FIXTURES AND JANITOR'S SINK TO BE REPLACED WITH NEW FIXTURES. DEMOLISH EXISTING CARRIERS AND HORIZONTAL WATER, WASTE, AND VENT PIPING IN CHASE. EXISTING WATER, WASTE, AND VENT VERTICAL RISERS TO REMAIN FOR RECONNECTION.
- DEMOLISH EXISTING PLUMBING FIXTURES AND ASSOSIATED PIPING UTILITIES BACK TO THE MAIN OR RISERS.
- 4. DEMOLISH EXISTING DCW RISER AND OFFSET TO SAME LOCATION ON LEVEL 3 ABOVE. CONTRACTOR TO FIELD COORDINATE RELOCATION OF EXISTING RISERS AT LEVEL 2 BASED ON NEW CHASE.
- DEMOLISH EXISTIG RISERS IN PIPE SPACES THAT ARE NO LONGER IN SERVICE. CAP REMAINING PIPES BELOW LEVEL 2 SLAB.



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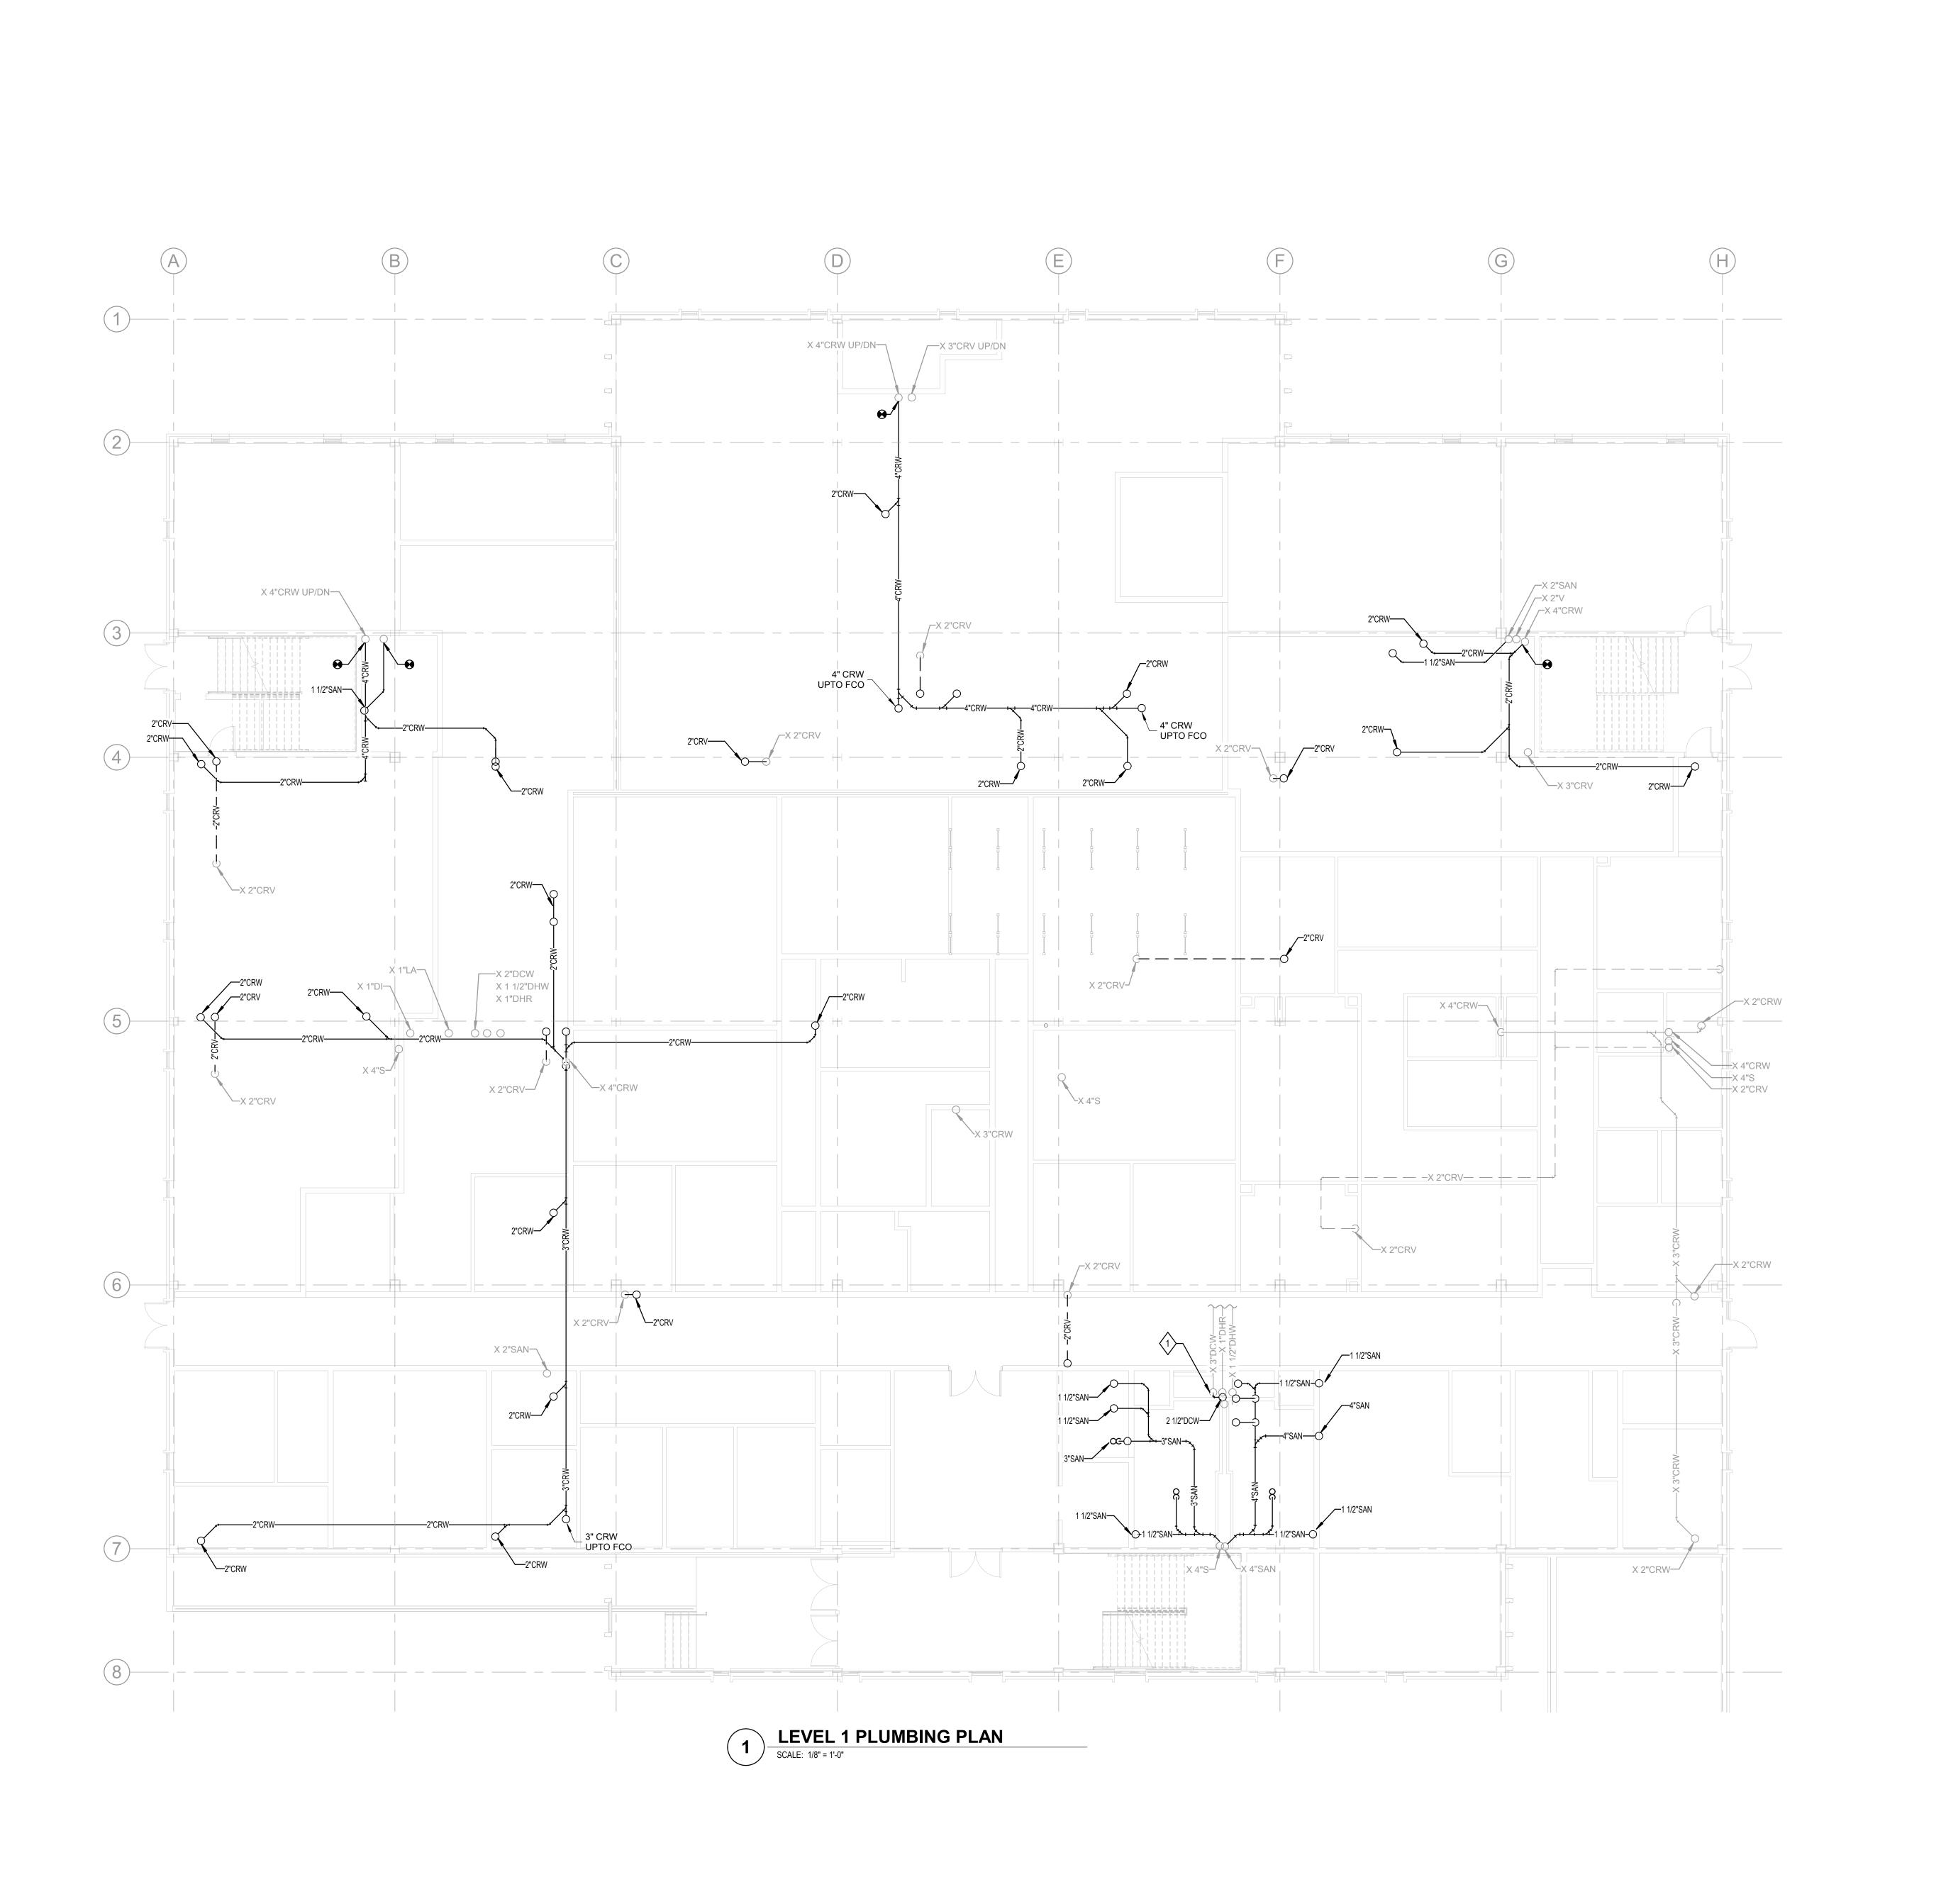


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LEVEL 2 PLUMBING PRESSURE DEMOLITION PLAN

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PD102A



 WASTE DROPS INDICATED ARE SERVING NEWLY RELOCATED FIXTURES ON LEVEL 2 ABOVE.

# **SHEET KEYNOTES**

 RELOCATE EXISTING DCW RISER AND OFFSET TO SAME LOCATION ON LEVEL 3 ABOVE. CONTRACTOR TO FIELD COORDINATE RELOCATION OF EXISTING RISERS AT LEVEL 2 BASED ON NEW CHASE. Walker Architect

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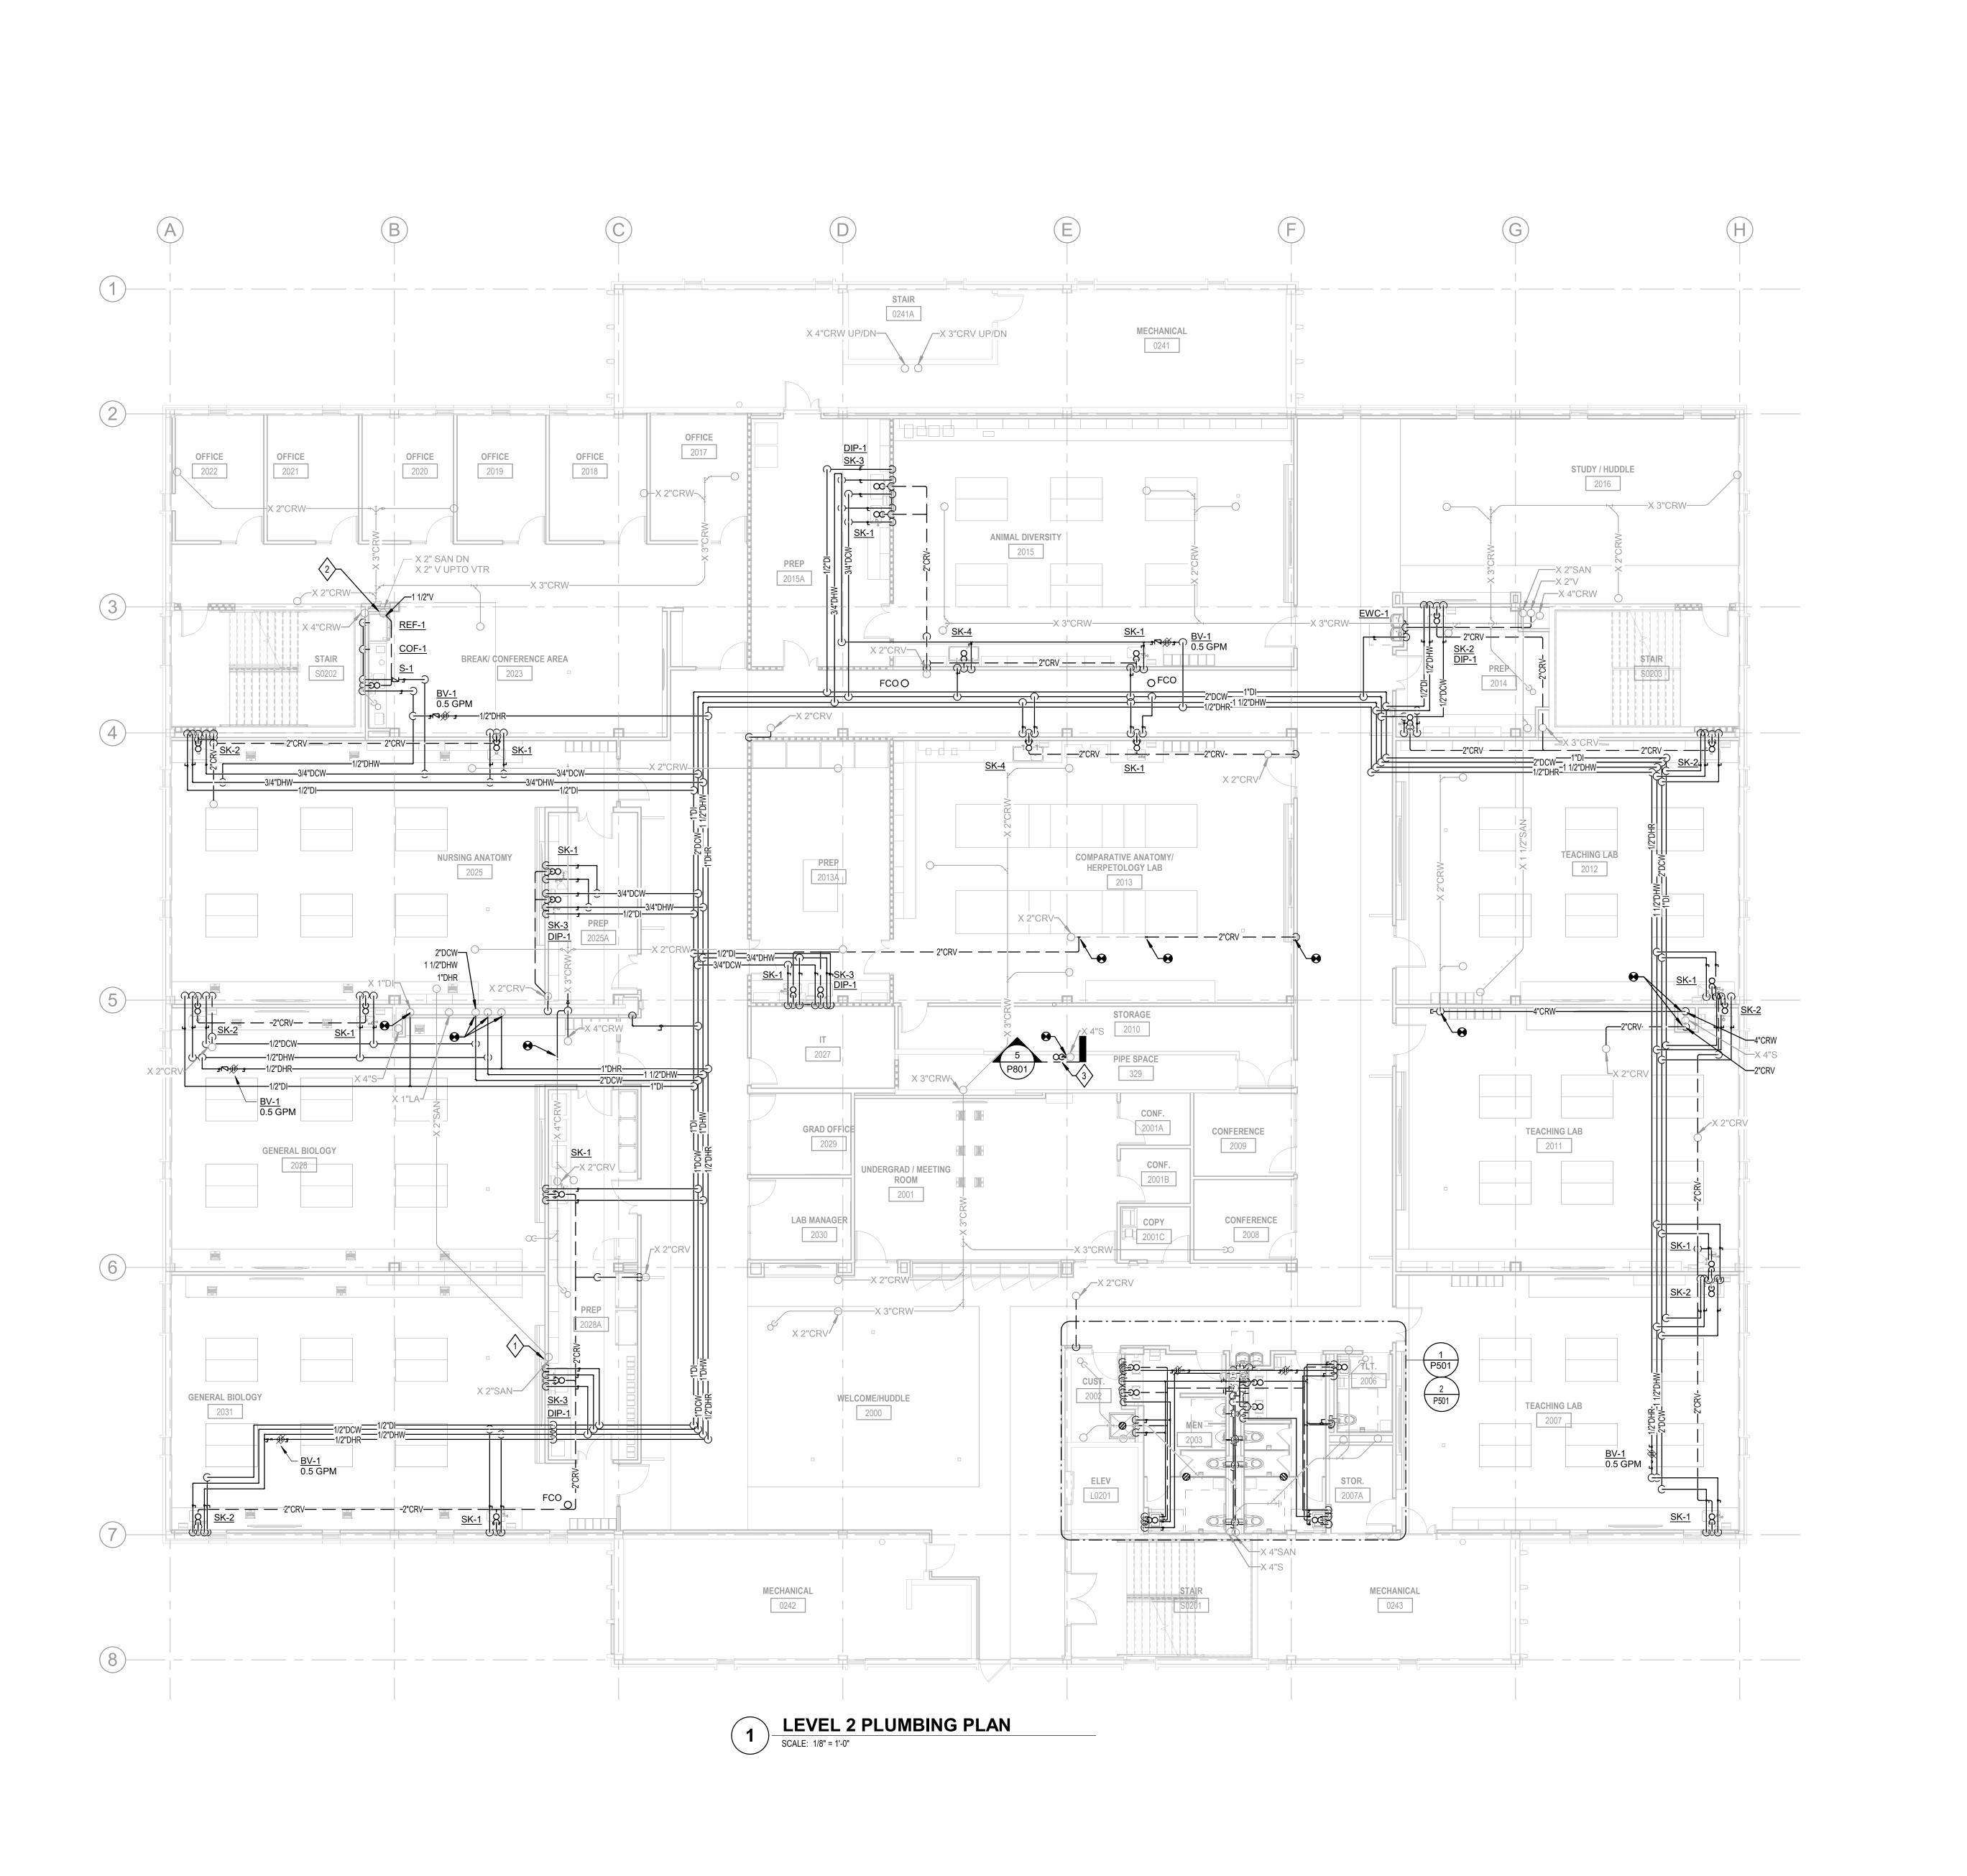
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LEVEL 1 PLUMBING PLAN

PROJECT NO.: 23055-00 DRAWN BY: RAN CHECKED BY: KAW



# **SHEET KEYNOTES**

- RELOCATE EXISTING 2" SAN RISER INSIDE THE
- CONNECT 1-1/2" SAN AND 1-1/2" V TO THE EXISTING WASTE AND VENT RISER STACK.
- 3. PROVIDE HUB DRAIN AT 4' A.F.F. WITH A P-TRAP AND BACKWATER VALVE. ROUTE CONDENSATE DRAIN FROM THE FAN COIL UNITS TO THE HUB DRAIN WITH AN AIR GAP FITTING. REFER TO MECHANICAL DRAWINGS FOR THE CONDENSATE PIPE ROUTING. REFER DETAIL #5/P801.

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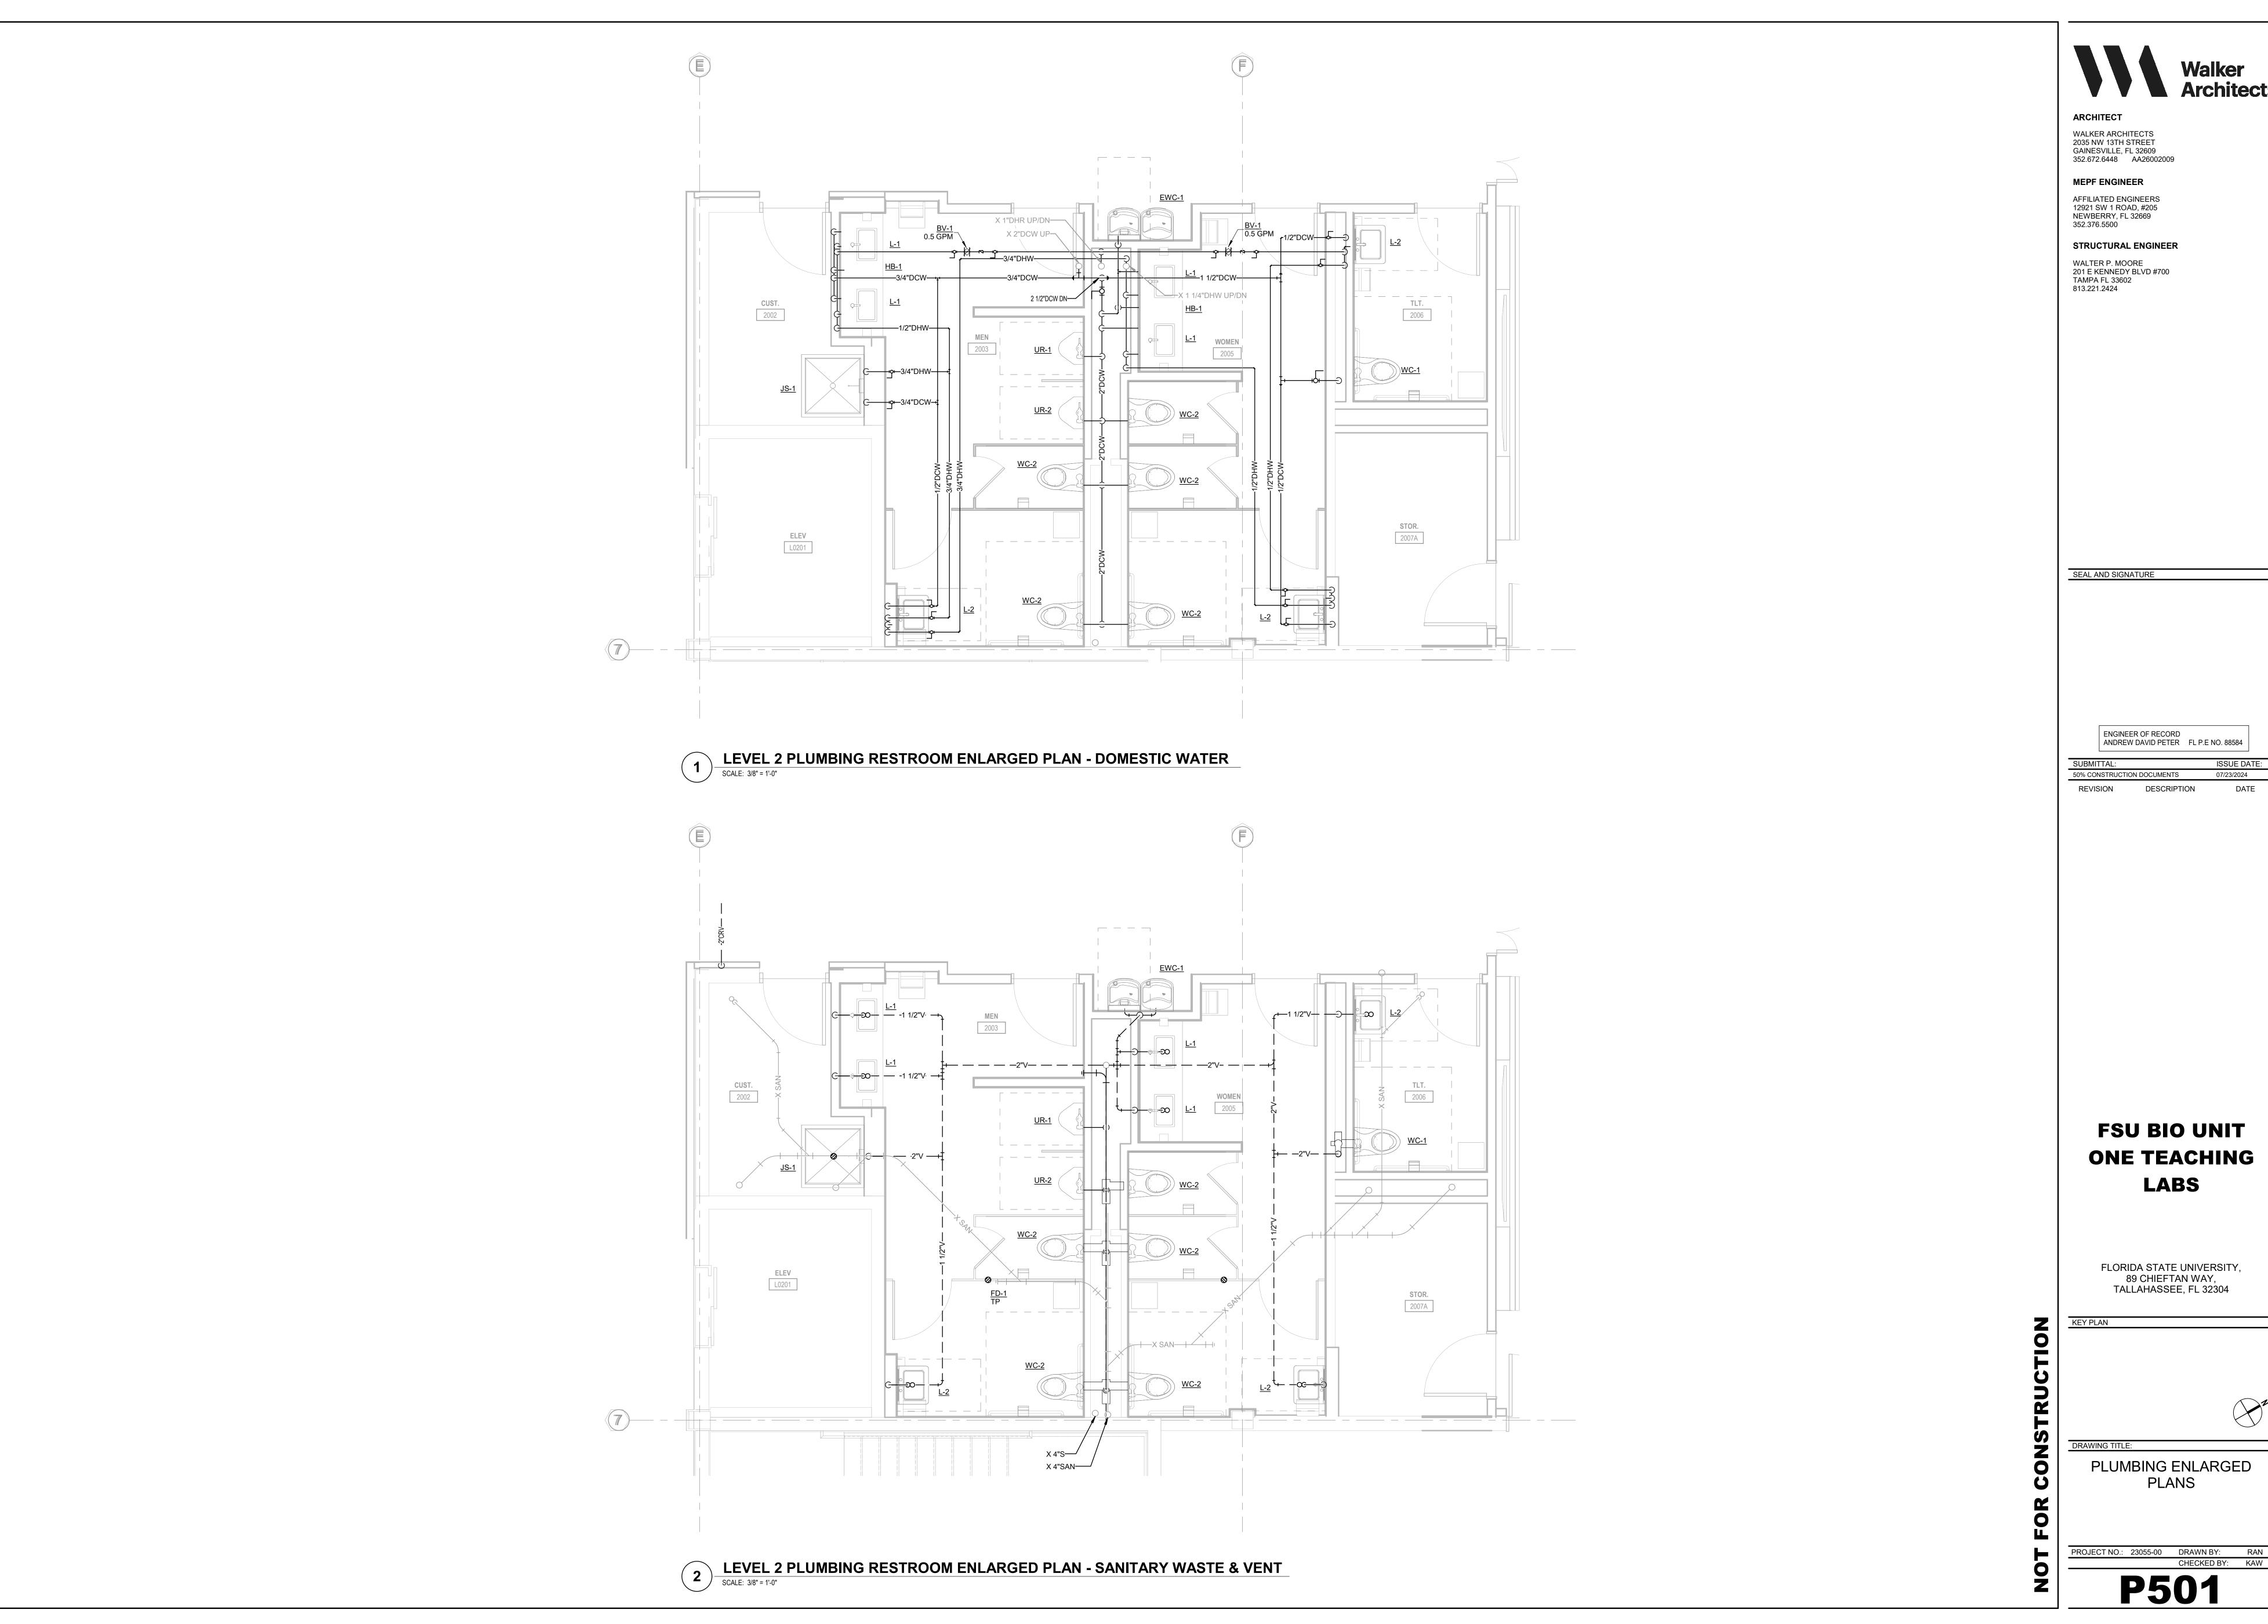
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LEVEL 2 PLUMBING PLAN

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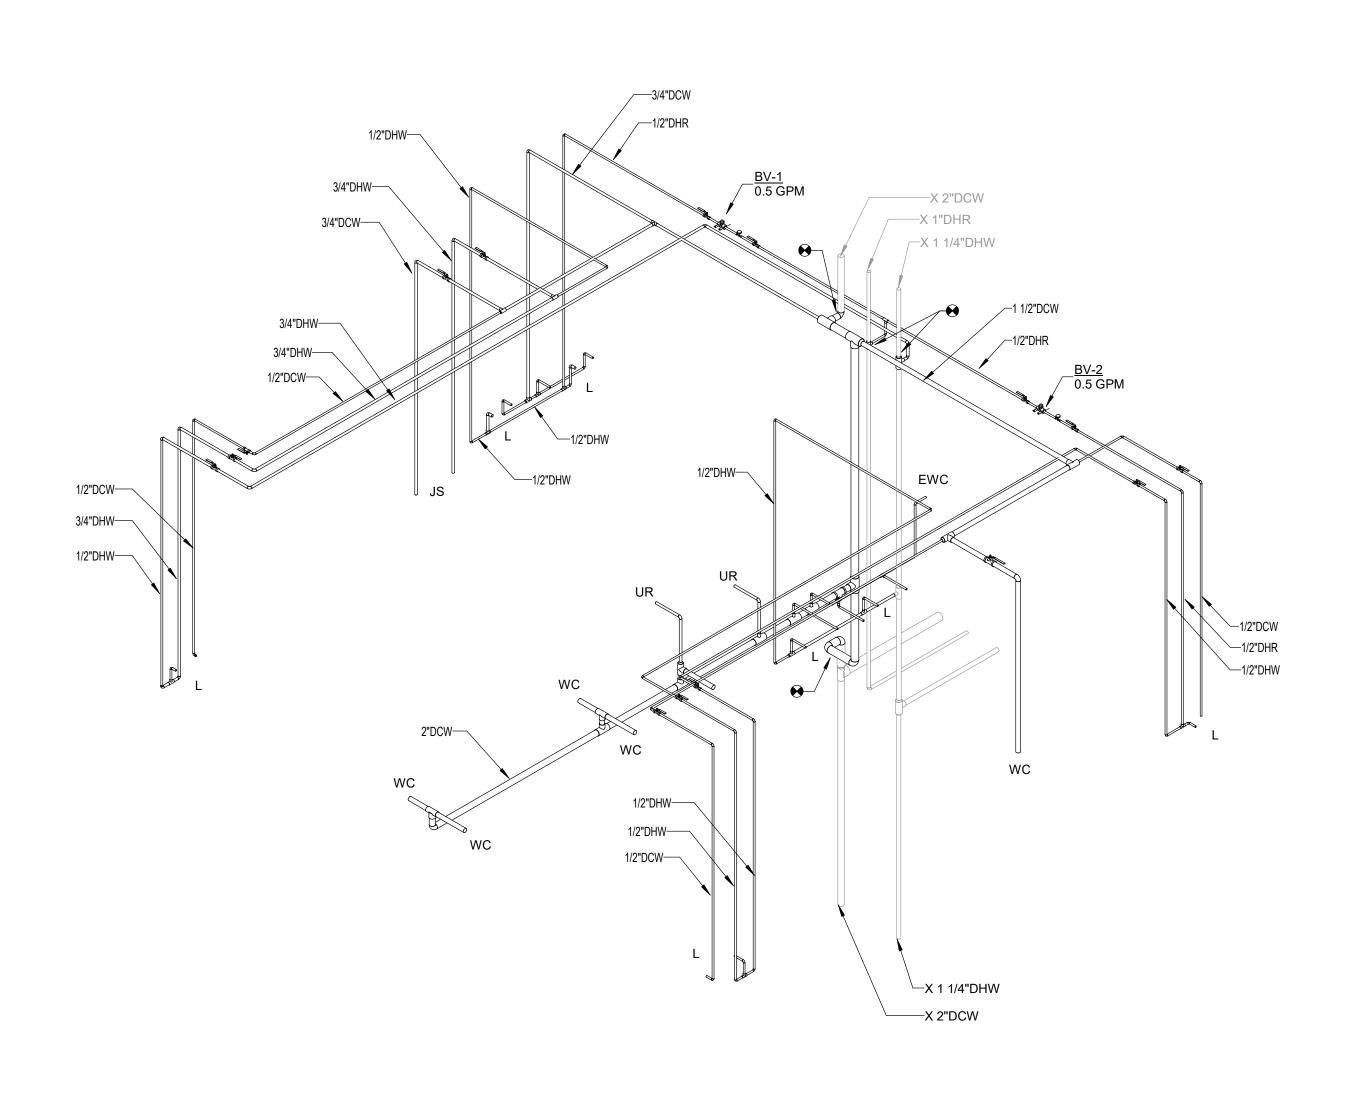
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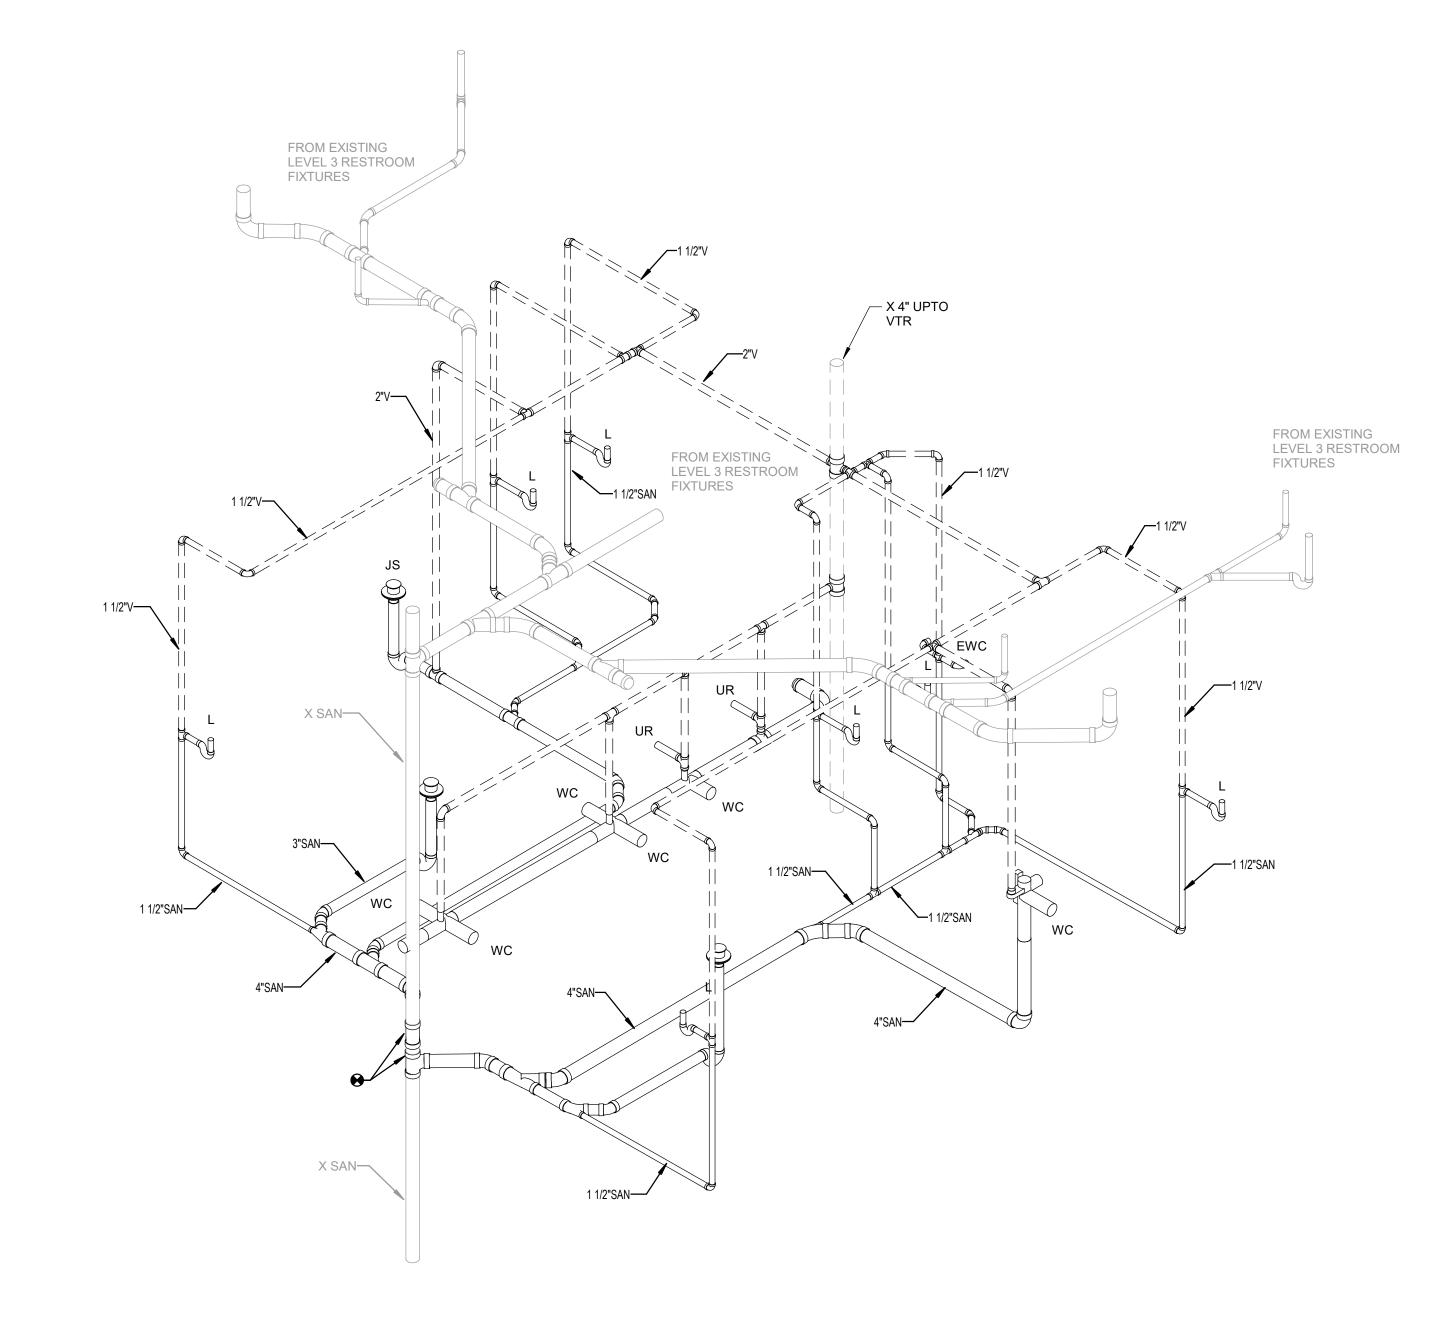
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PLUMBING ENLARGED

**PLANS** 





PLUMBING RESTROOM RISER - DOMESTIC WATER

SCALE:

1 PLUMBING RESTROOM RISER - SANITARY WASTE & VENT

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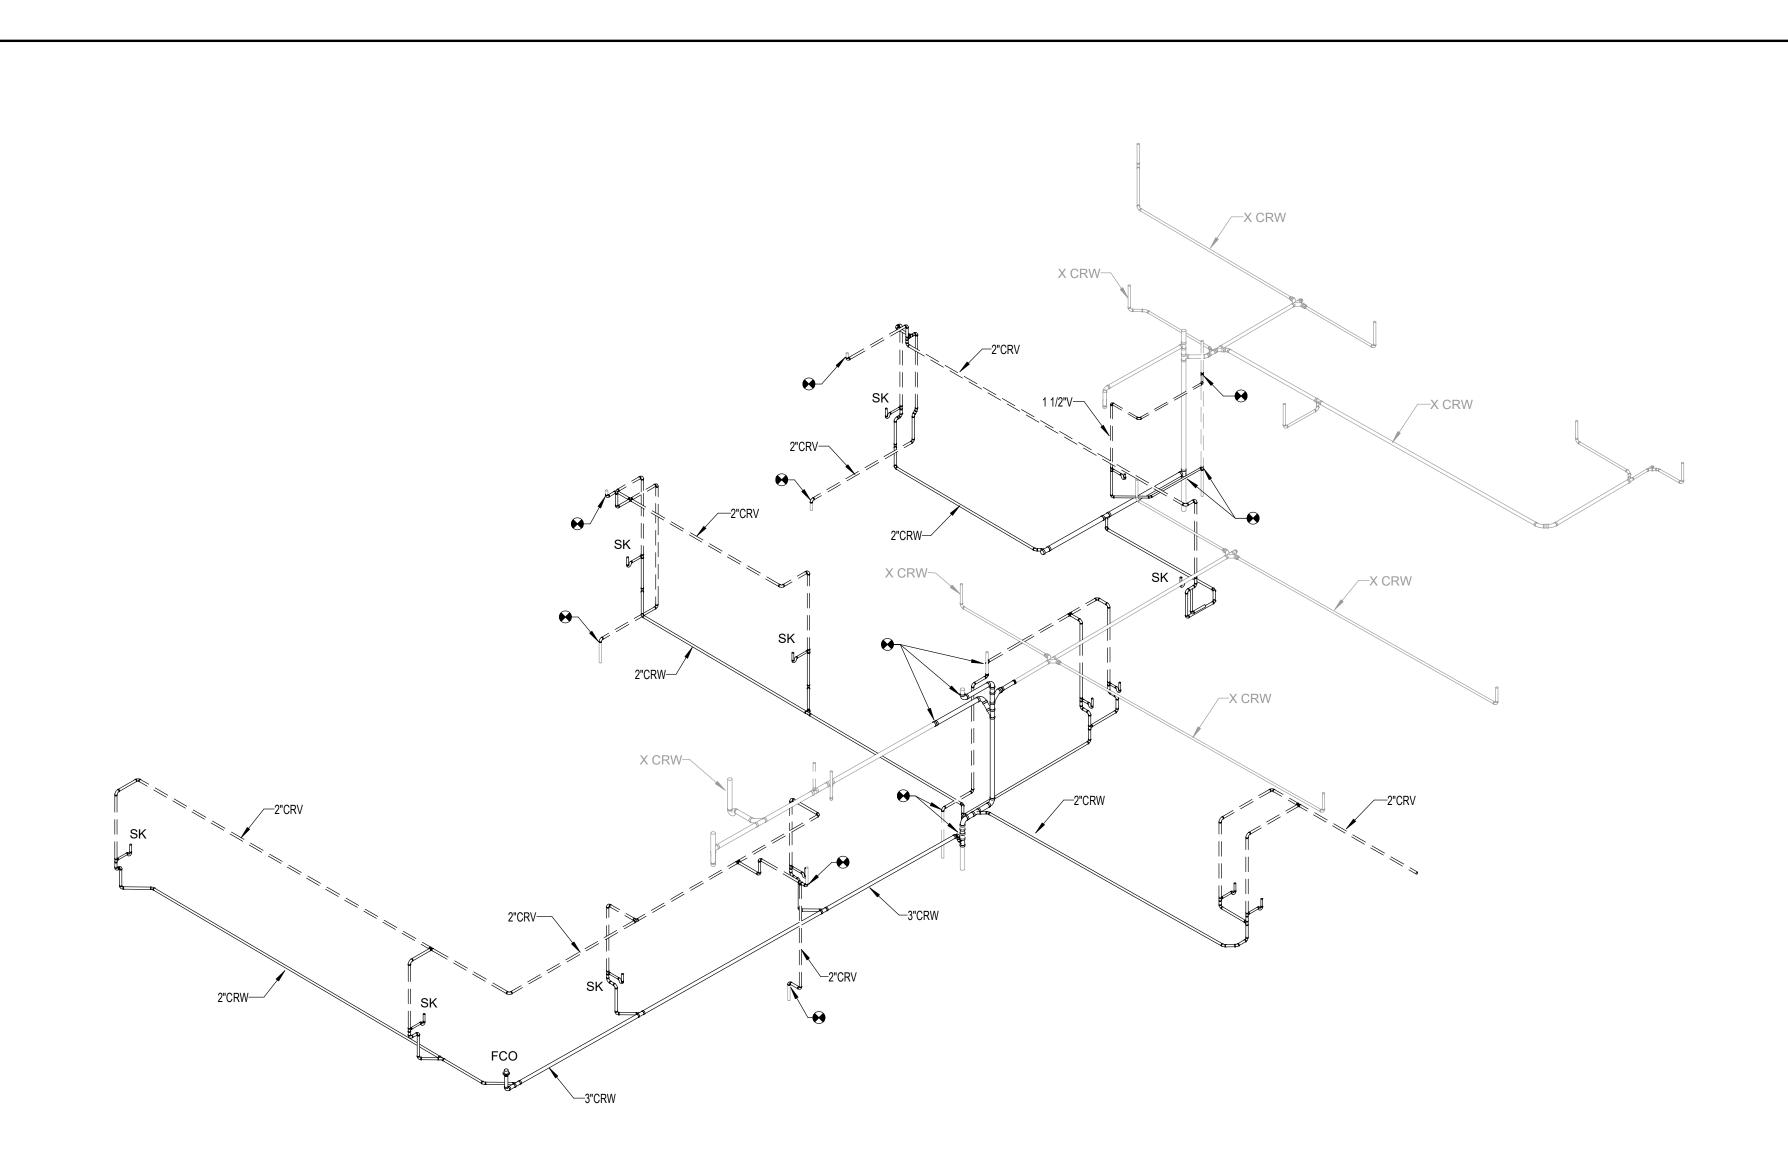
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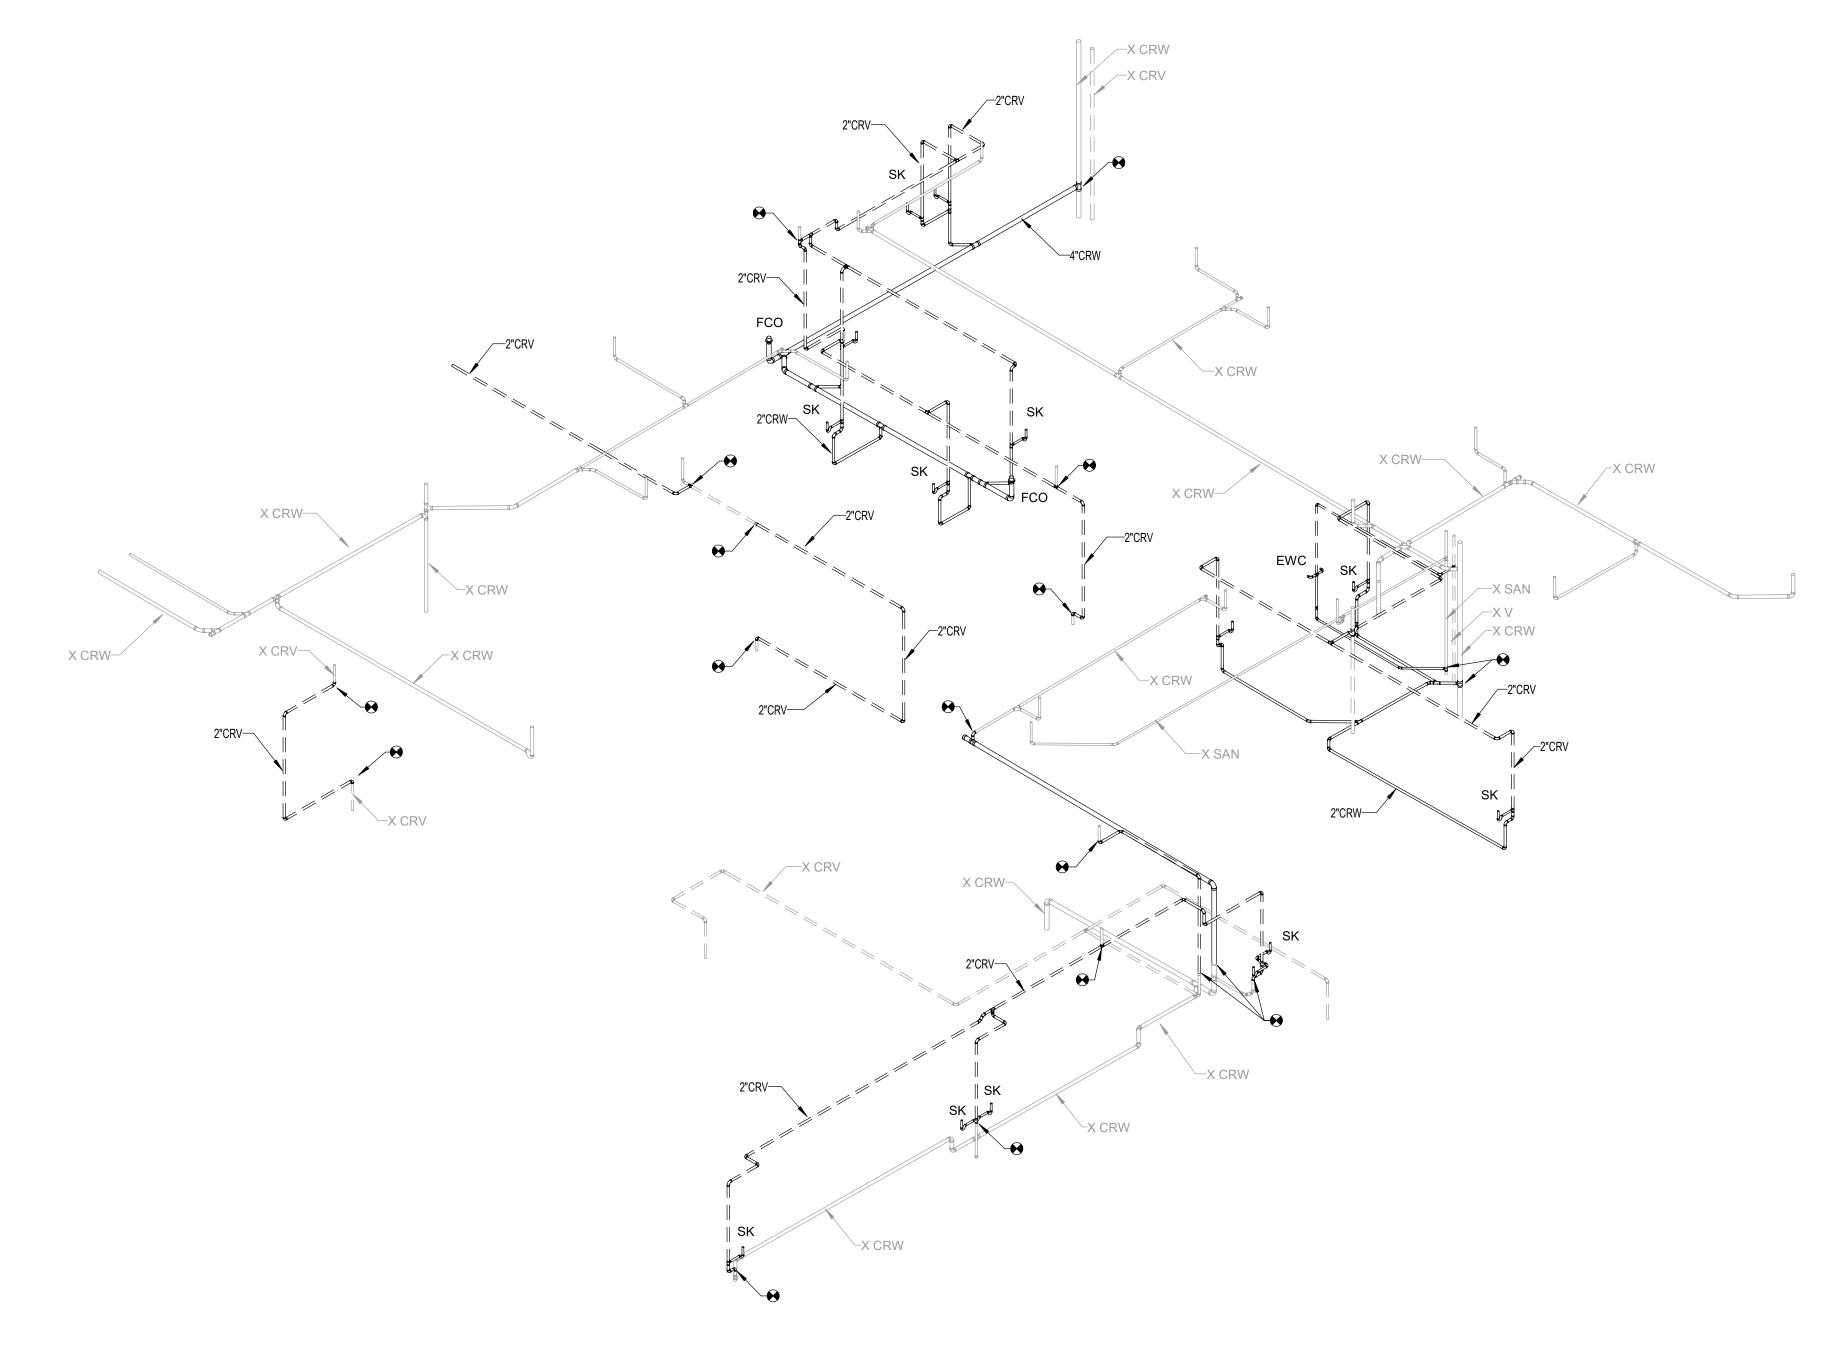
DRAWING TITLE:

PLUMBING RESTROOM RISERS

PROJECT NO.: 23055-00 DRAWN BY: RAN CHECKED BY: KAW



2 PLUMBING WASTE RISER - WEST
SCALE: NOT TO SCALE



1 PLUMBING WASTE RISER - EAST
SCALE: NOT TO SCALE



Affiliated Engineers

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ENGINEER OF RECORD ANDREW DAVID PETER FL P.E NO. 88584

SUBMITTAL:ISSUE DATE:50% CONSTRUCTION DOCUMENTS07/23/2024REVISIONDESCRIPTIONDATE


FSU BIO UNIT
ONE TEACHING
LABS

FLORIDA STATE UNIVERSITY, 89 CHIEFTAN WAY, TALLAHASSEE, FL 32304


Y PLAN

PLUMBING LAB RISERS -WASTE AND VENT

PROJECT NO.: 23055-00 DRAWN BY: RAN
CHECKED BY: KAW

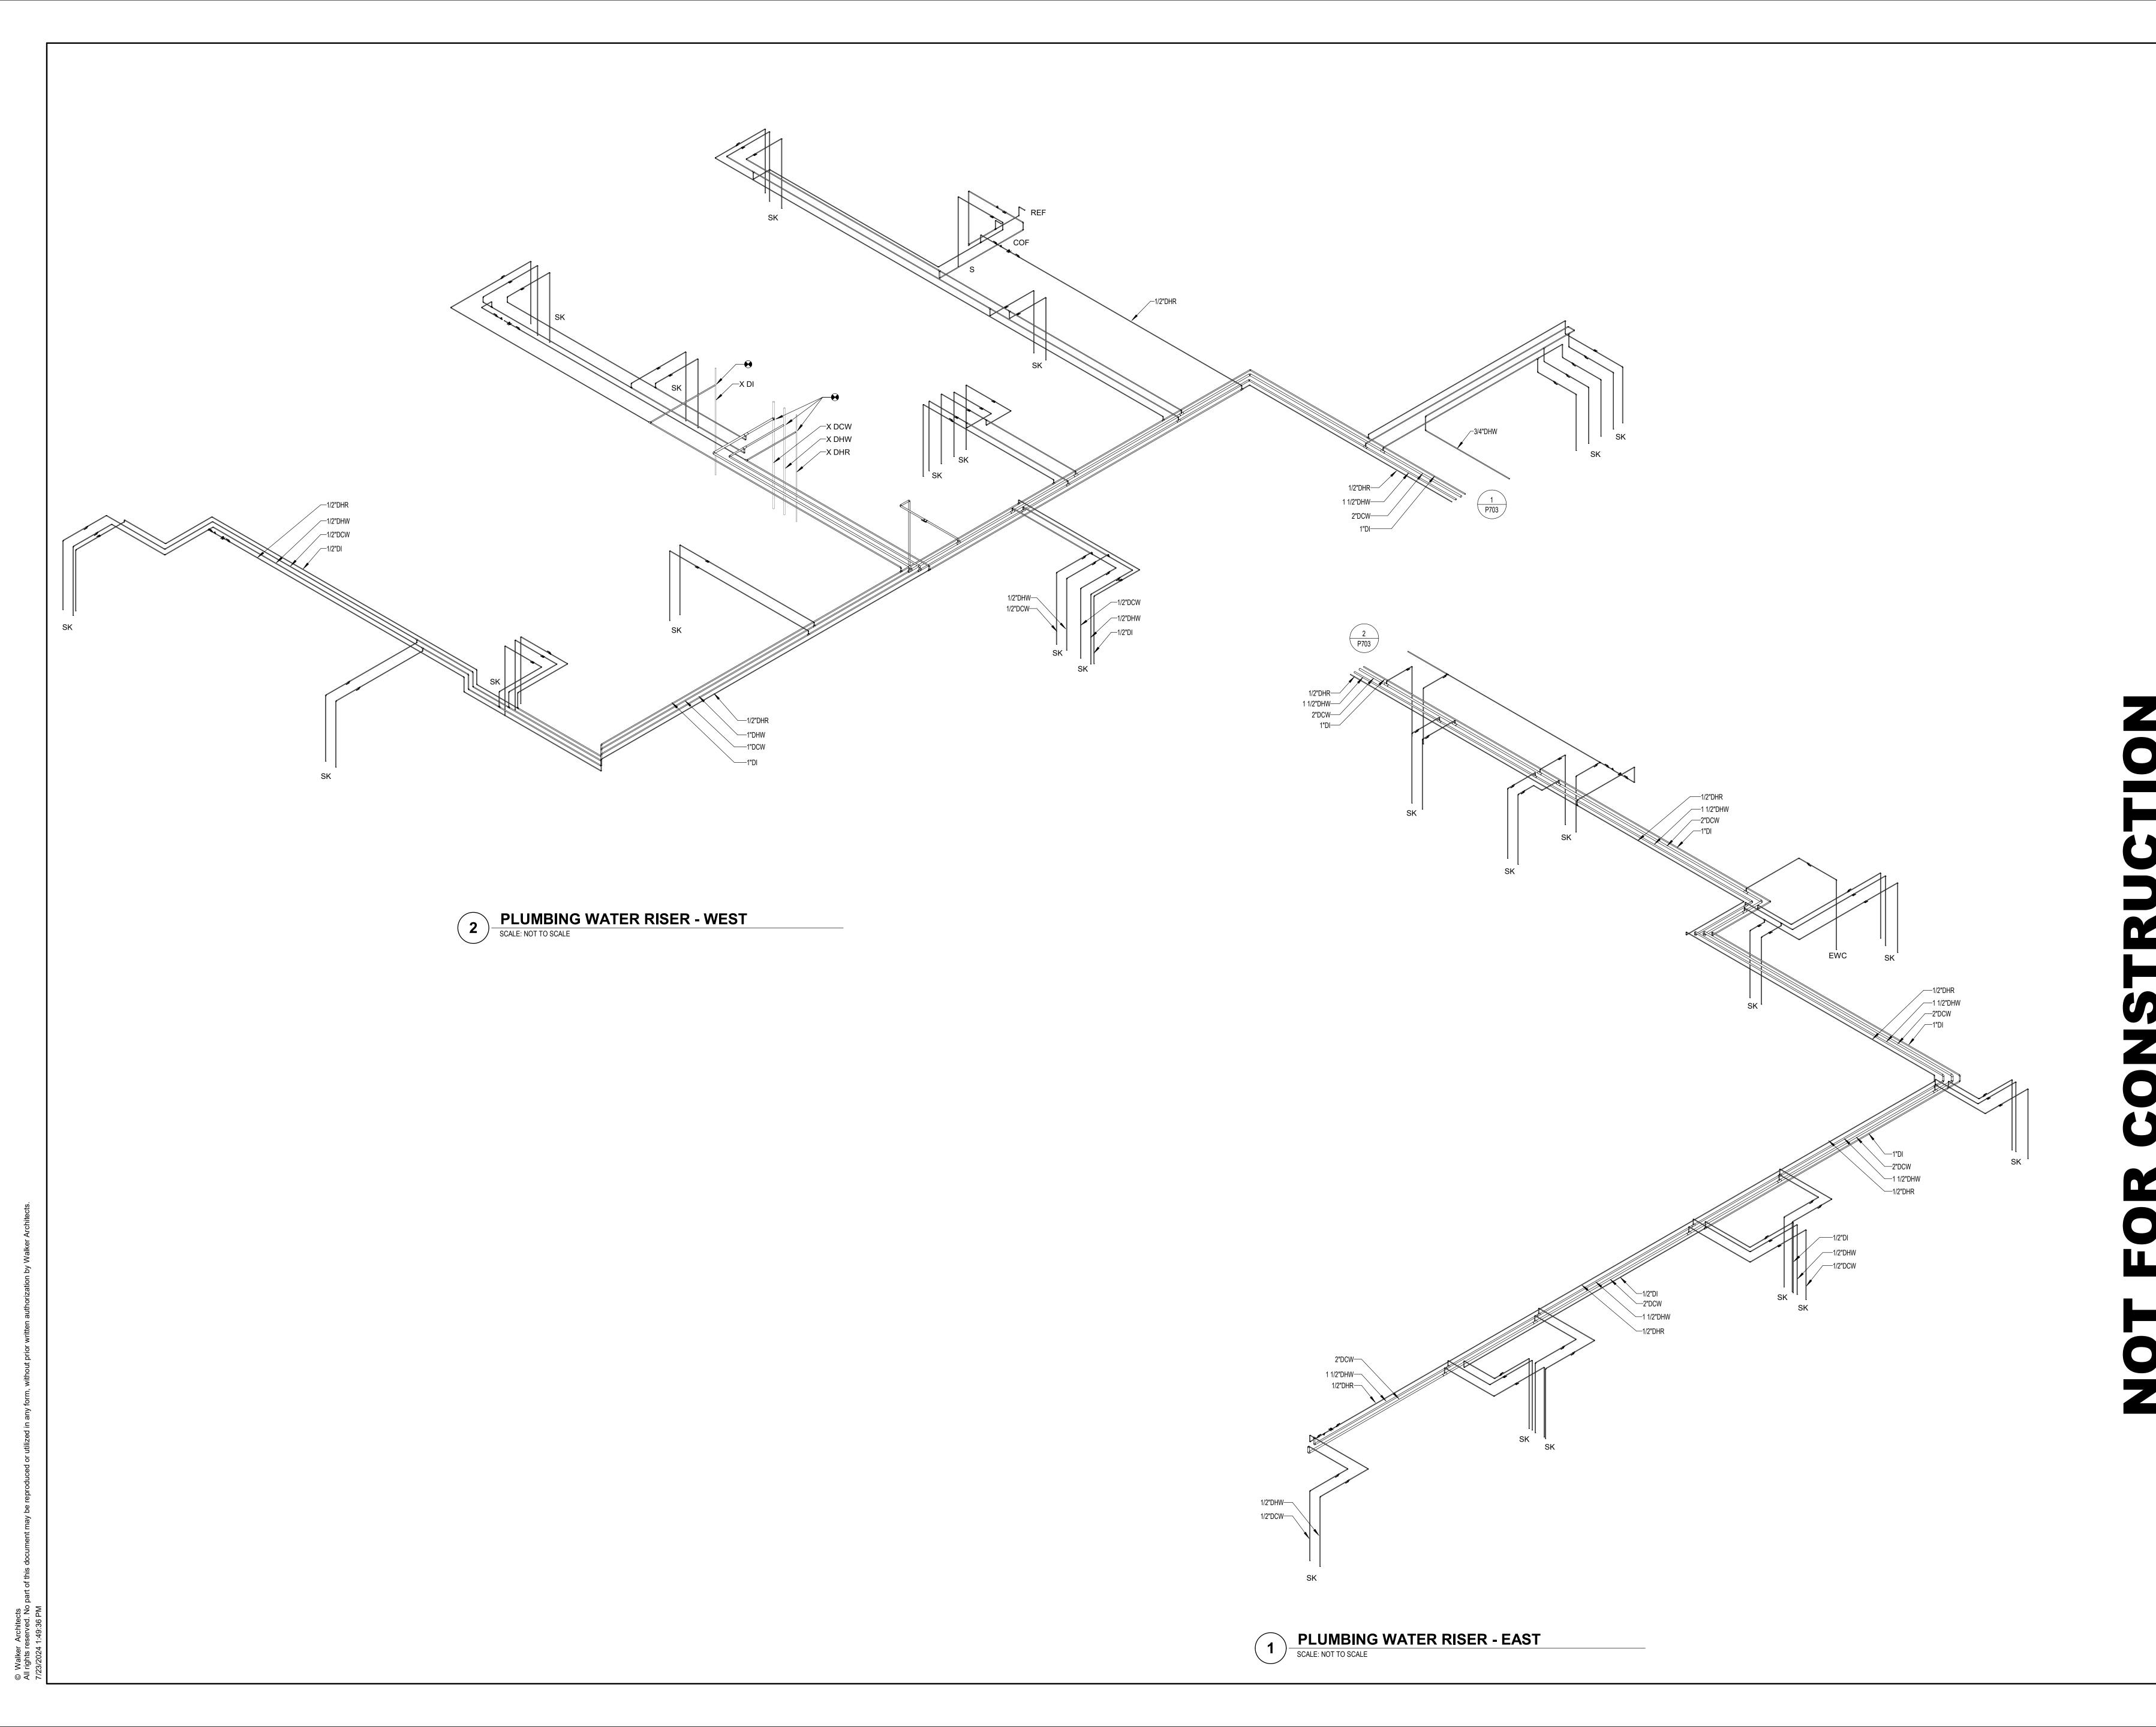



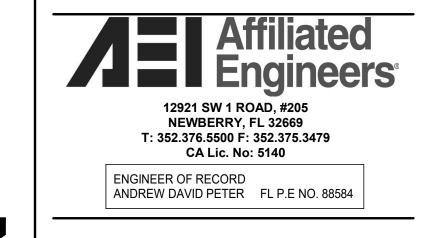

SUBMITTAL: ISSUE DATE:
50% CONSTRUCTION DOCUMENTS 07/23/2024

REVISION DESCRIPTION DATE

# FSU BIO UNIT ONE TEACHING LABS


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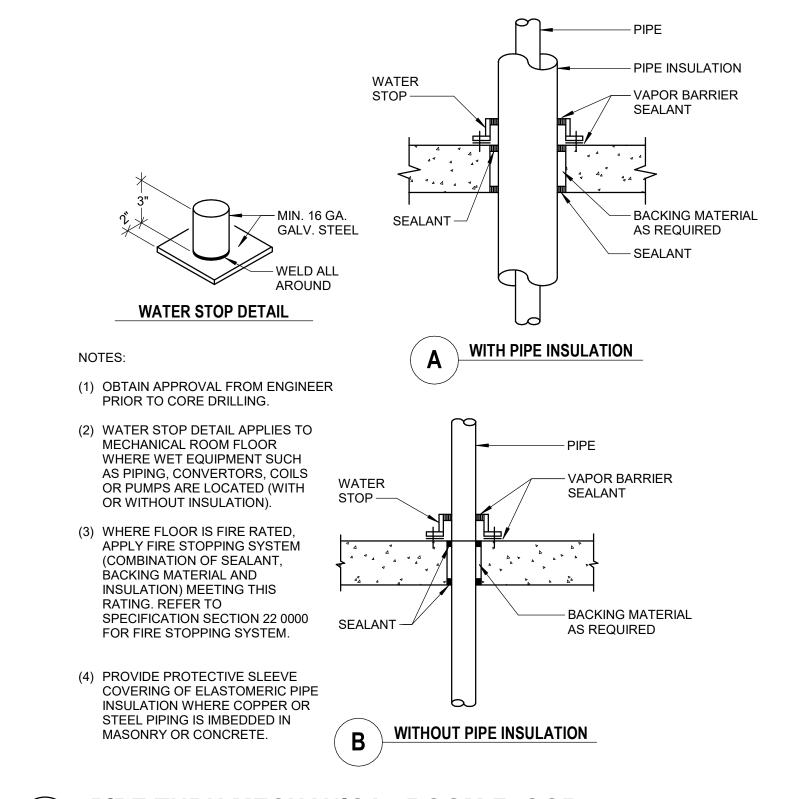
EY PLAN


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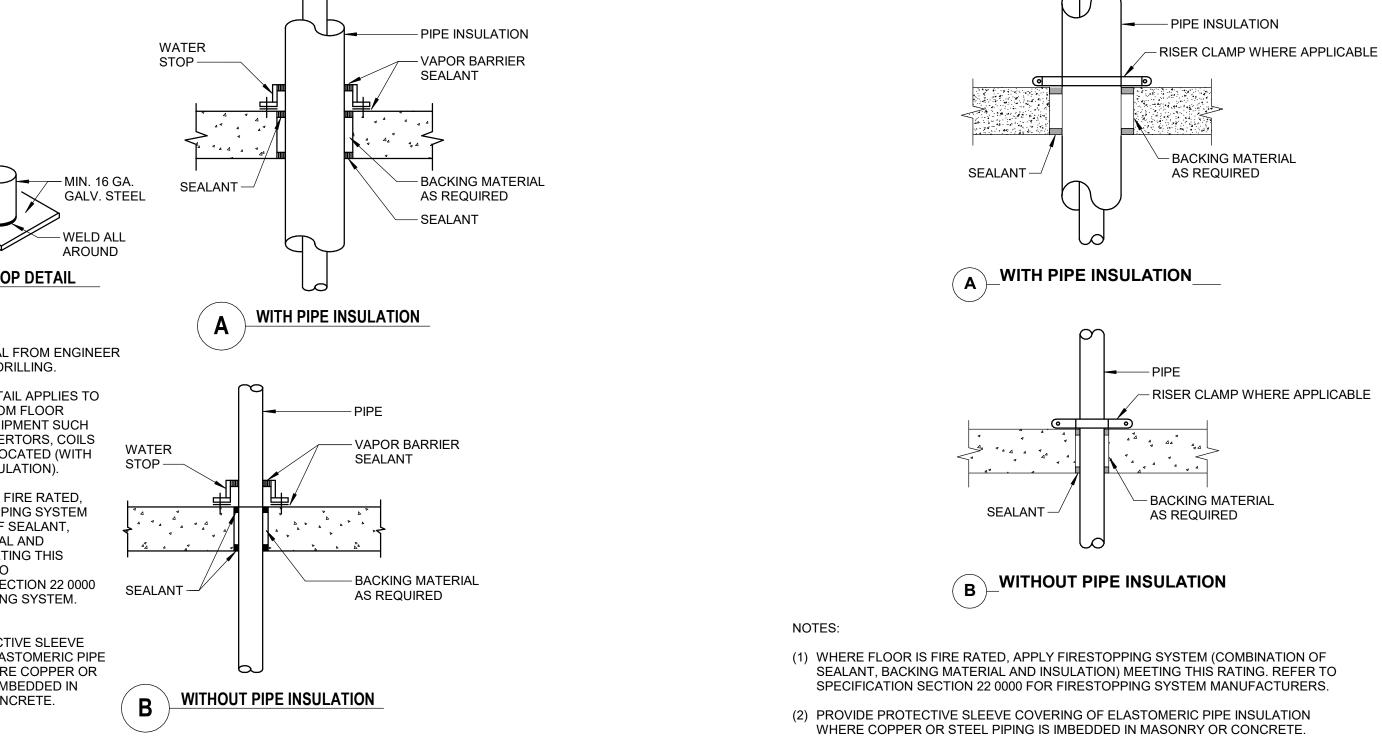
PLUMBING LAB RISERS -WATER


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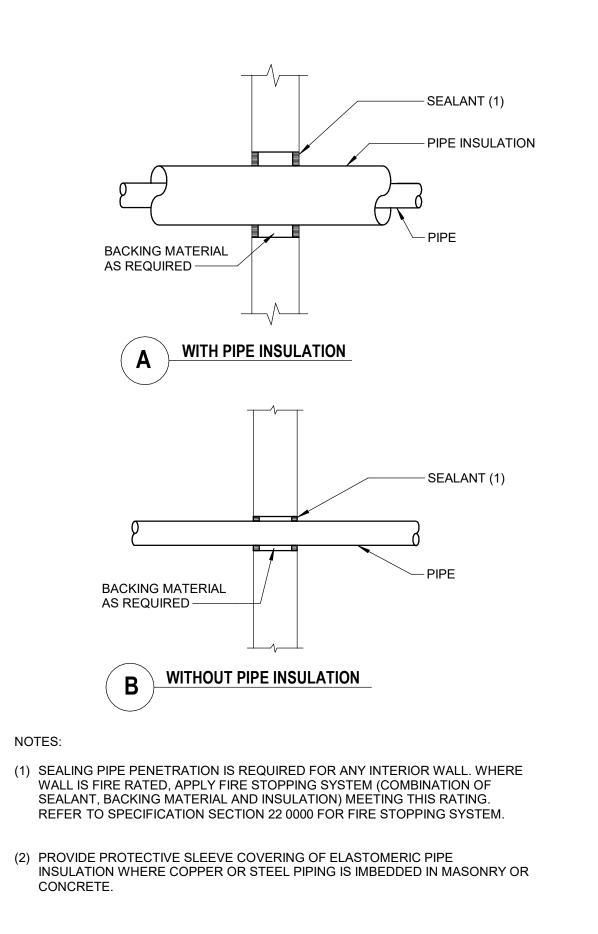






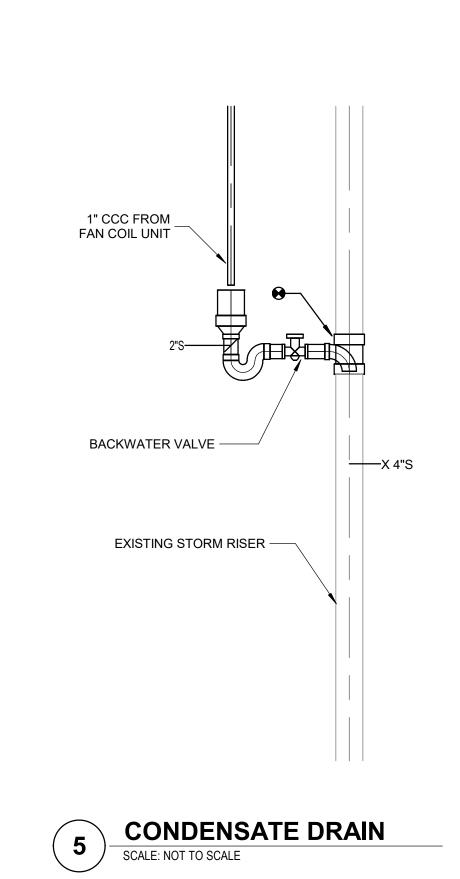

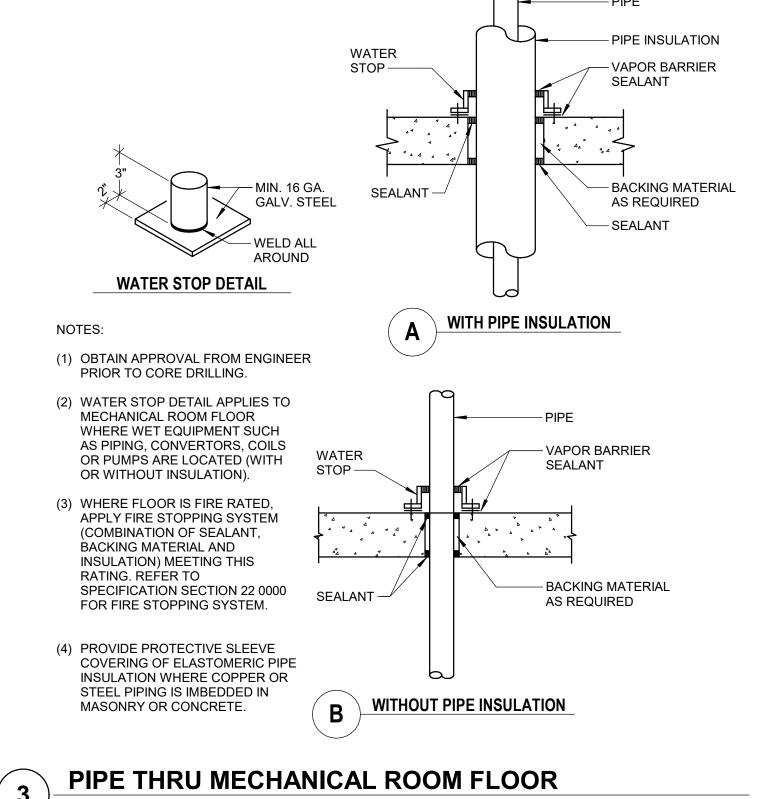

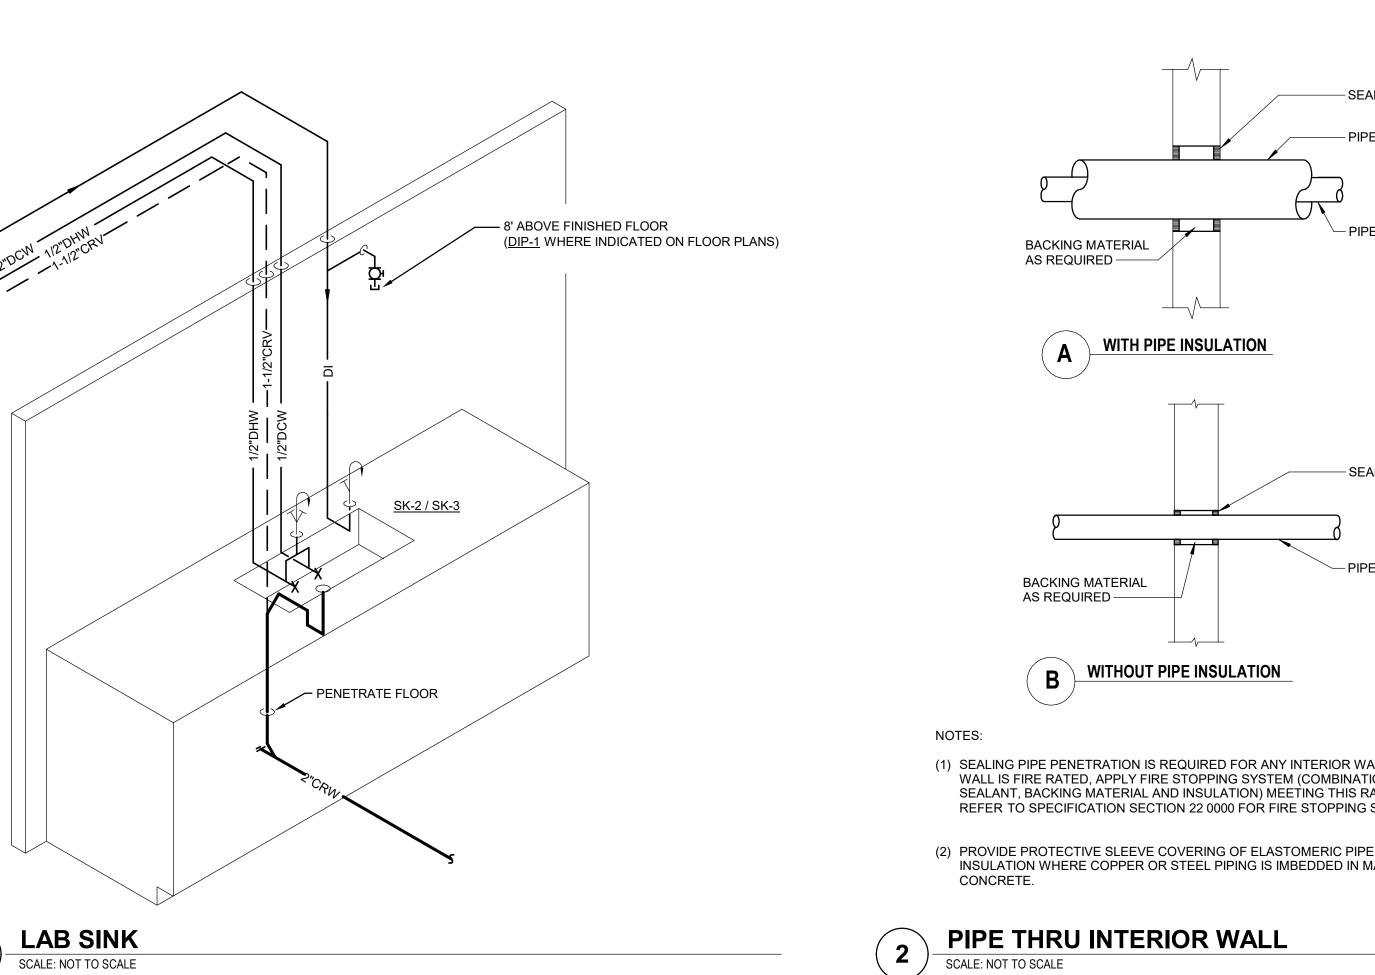

PIPE THROUGH FLOOR

SCALE: NOT TO SCALE



**ARCHITECT** 

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SEAL AND SIGNATURE

ENGINEER OF RECORD

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REVISION

ANDREW DAVID PETER FL P.E NO. 88584

DESCRIPTION

07/23/2024

DATE

FLORIDA STATE UNIVERSITY, 89 CHIEFTAN WAY, TALLAHASSEE, FL 32304

PLUMBING DETAILS

PROJECT NO.: 23055-00 DRAWN BY: RAN

**DRAINS** 

TAG	BASIS OF DESIGN	DESCRIPTION
	MANUFACTURER AND MODEL	
FD-1	JAY R SMITH	LIGHT DUTY FLOOR DRAIN, TRAP PRIMER CONNECTION
	2005Y-A-NB-P050	

NOTE: FLOOR DRAINS WITH A (TP) SUFFIX SHALL BE CONNECTED TO A TRAP PRIMER SUPPLY.

**BALANCING VALVES** 

TAG	LOCATION	SERVICE	BASIS OF DESIGN	SIZE	DESIGN	DESIGN FLOW RATE
			MANUFACTURER AND MODEL	(INCHES)	Cv	(GPM)
BV-1	REFER TO PLUMBING DRAWINGS	DHW	CONTROLS	1/2"	0.6	0.5
			TZV-2111			

FIXTURE			TPIM						PLUMBING FIXTURES						
AG	FIXTURE		FIXTURE TRIM		IKIM						CONNECTION COLD WATER HOT WATER				
	TYPE	MANUFACTURER AND MODEL NUMBER	TYPE	MANUFACTURER AND MODEL NUMBER	DESCRIPTION				BRANCH	STOP	BRANCH SUPPLY	STO			
C-1	WATER CLOSET WALL MOUNTED	KOHLER KINGSTON			WHITE VITREOUS CHINA, WALL HUNG SIPHON JET, ELONGATED BOWL, 1.28 GALLONS PER FLUSH. 1-1/2" TOP SPUD INLET.	4"	2"	INTEGRAL	1-1/2"	1"	-	-			
	WALL MOUNTED	K-84325	FLUSH VALVE	SLOAN ECOS	1.1 GALLONS PER FLUSH, EXPOSED SENSOR OPERATED DIAPHRAGM FLUSHOMETER,										
				111 SFSM-1.1-TMO ZURN	BATTERY, TRUE MECHANICAL OVERRIDE, 1-1/2" TOP SPUD CONNECTION, POLISHED CHROME.  ADJUSTABLE VERTICAL SIPHON JET NO-HUB, FACE PLATE, REAR SUPPORT FOR SINGLE CARRIERS, FLUSH VALVE										
			CARRIER	Z1204-N-JL-50 BEMIS	SUPPORT, CAST IRON EXTENSION WITH CONNECTOR, LEFT HAND AUXILIARY INLET STAINLESS STEEL SELF-SUSTAINING HINGE, WHITE.										
			TOILET SEAT	1995-SS/C											
C-2	WATER CLOSET	KOHLER	ACCESSORIES		GASKETS, BOLTS WITH CHROMIUM PLATED CAPS, NUTS AND WASHERS.  FIXTURE EQUAL TO WC-1, BARRIER FREE MOUNTING HEIGHT, FLUSH VALVE.							-			
_	WALL MOUNTED BARRIER FREE	KINGSTON K-84325			CARRIER, SEAT AND ACCESSORIES EQUAL TO WC-1.	4"	2"	INTEGRAL	1-1/2"	1"	-				
R-1	URINAL	KOHLER			WHITE VITREOUS CHINA, WALL MOUNTED, WASHOUT TYPE, RIM EXTEND TO 14" FROM	2"	1-1/2"	INTEGRAL	3/4"	3/4"	-				
	WALL HUNG	BARDON K-4991-ET		SLOAN	WALL, 0.125 GALLONS PER FLUSH, 3/4" TOP SPUD INLET.  0.125 GALLONS PER FLUSH, EXPOSED SENSOR OPERATED DIAPHRAGM										
			FLUSH VALVE	186 SFSM-0.125-TMO	FLUSHOMETER, TRUE MECHANICAL OVERRIDE, BATTERY POWERED, 3/4" TOP SPUD CONNECTION, POLISHED CHROME.										
			CARRIER	J.R. SMITH	ADJUSTABLE UNIVERSAL CARRIER WITH HANGER PLATE, PIPE UPRIGHTS, LOWER										
-2	URINAL	KOHLER		SERIES 600	SUPPORT PLATE.  FIXTURE EQUAL TO UR-1, BARRIER FREE MOUNTING HEIGHT. FLUSH VALVE AND							+			
	WALL HUNG BARRIER FREE	BARDON K-4991-ET			CARRIER EQUAL TO UR-1.	2"	1-1/2"	INTEGRAL	3/4"	3/4"	-				
1	LAVATORY UNDERMOUNTED	KOHLER CAXTON K-2210			14" X 17" WHITE VITREOUS CHINA, UNDERMOUNT, SINGLE FAUCET HOLE	1-1/2"	1-1/2"	1-1/4"	1/2"	3/8"	1/2"	3.			
	O ADELVINIO O IN LED	O-7/1 ON 11-22 IU	FAUCET	CHICAGO FAUCET	SENSOR ACTIVATED, SINGLE HOLE, 0.35 GPM AERATED SPRAY, BATTERY POWERED										
			THERMOSTATIC	HYTRONIC 116.201.AB.4 SYMMONS	SINGLE SUPPLY, POLISHED CHROME.  POINT OF USE, 3/8" COMPRESSION INLETS AND OUTLETS, INTEGRAL										
			MIXING VALVE	7-225-CK	CHECKS/STRAINERS, 0.35 GPM MINIMUM FLOW, LEAD FREE, ASSE 1070, CHROME FINISH.  17-GAUGE TUBULAR BRASS, FIXED GRATE, 1-1/4" OVERFLOW INLET, 1-1/2" OUTLET,										
			DRAIN & TRAP	MCGUIRE PROWRAP PW2125HDWC	6" HORIZONTAL OFFSET, CAST BRASS P-TRAP WITH CLEANOUT, HEAVY-DUTY										
			STOPS &	MCGUIRE	BLACK FINISH GRID STRAINER, PRE-WRAPPED, INSULATION KIT FOR SUPPLY STOPS.  ANGLE PATTERN. LOCK SHEILD CAP. LOOSE KEY HANDLE. 1/2" NPT INLET X 3/8"										
			SUPPLIES	LF2165CCLK	COMPRESSION OUTLET, POLISHED CHROME.										
2	LAVATORY WALL MOUNTED	KOHLER GREENWICH K-2031			20-3/4" X 18-1/4" X 7-3/4", WHITE VITREOUS CHINA, UNDERMOUNT, FRONT OVERFLOW.	1-1/2"	1-1/2"	1-1/4"	1/2"	3/8"	1/2"	3			
	(BARRIER-FREE)		FAUCET	CHICAGO FAUCET HYTRONIC 116.201.AB.4	SENSOR ACTIVATED, SINGLE HOLE, 0.35 GPM AERATED SPRAY, BATTERY POWERED SINGLE SUPPLY, POLISHED CHROME.										
			THERMOSTATIC	SYMMONS	POINT OF USE, 3/8" COMPRESSION INLETS AND OUTLETS, INTEGRAL										
			MIXING VALVE	7-225-CK	CHECKS/STRAINERS, 0.35 GPM MINIMUM FLOW, LEAD FREE, ASSE 1070, CHROME FINISH.  17-GAUGE TUBULAR BRASS, FIXED GRATE, 1-1/4" OVERFLOW INLET, 1-1/2" OUTLET.										
			DRAIN & TRAP	MCGUIRE PROWRAP PW2125HDWC	6" HORIZONTAL OFFSET, CAST BRASS P-TRAP WITH CLEANOUT, HEAVY-DUTY										
			STOPS &	MCGUIRE	BLACK FINISH GRID STRAINER, PRE-WRAPPED, INSULATION KIT FOR SUPPLY STOPS.  ANGLE PATTERN, LOCK SHEILD CAP, LOOSE KEY HANDLE, 1/2" NPT INLET X 3/8"										
	SINK	ELKAY	SUPPLIES	LF2165CCLK	COMPRESSION OUTLET, POLISHED CHROME.  TYPE 302 STAINLESS STEEL. 18 GA. SELF-RIMMING. SINGLE							_			
'	SINGLE BOWL	ELUHAD211555			COMPARTMENT, SATIN FINISH, FULLY UNDERCOATED, COMPARTMENT, DIMENSIONS 23.5" X 18.25" X 5"	1-1/2"	1-1/2"	1-1/4"	1/2"	1/2"	1/2"	1			
	BARRIER-FREE		FAUCET	CHICAGO FAUCET 434-ABCP	CAST OR COPPER ALLOY MIXING VALVE FAUCET, 8" SWING GOOSENECK, WRIST BLADE HANDLES, POLISHED CHROME FINISH  1.5 GPM FLOW CONTROL, 8" FAUCET CENTERS, RENEWABLE OR REPLACEABLE OPERATING MECHANICSM.										
			DRAIN	ELKAY	STAINLESS STEEL BODY, 1-1/2" CHROME PLATED BRASS TAILPIECE, STAINLESS										
			TRAP	LK-99 MCGUIRE	BASKET STRAINER, 3-1/2" OPENING.  1-1/2" X 1-1/2" P-TRAP WITH CLEANOUT PLUG, ADJUSTABLE WITH CONNECTED ELBOW										
			STOPS &	8912CNC MCGUIRE	AND NIPPLE TO WALL, POLISHED CHROME.  ANGLE PATTERN, LOCK SHIELD CAP, LOOSE KEY HANDLE, 1/2" NPT INLET X 1/2"										
			SUPPLIES	LF2167CCLK	NPT OUTLET, POLISHED CHROME.										
C-1	ELECTRIC WATER COOLER	ELKAY LZSTLG8WSSP			DUAL LEVEL, BOTTLE FILLER, SELF-CONTAINED, SURFACE WALL MOUNTED, BASIN OVER CABINET, HFC-134A REFRIGERANT, 8 GPH MINIMUM CAPACITY, ANTI-SPLASH										
	BARRIER-FREE	LZSTLGOWSSF			STAINLESS STEEL BASIN, STAINLESS STEEL CABINET, SENSOR ACTIVATED BOTTLE	1-1/2"	1-1/2"	1-1/4"	1/2"	3/8"	-				
	WITH BOTTLE FILLER				FILLER, PUSH-BAR ACTIVATED FOUNTAINS, AUTOMATIC STREAM REGULATOR, POLISHED CHROME TRIM. CANE APRON FOR FIXTURES IN CIRCULATION PATHS.										
			TRAP		1-1/4" X 1-1/2" P-TRAP WITH CLEANOUT PLUG, ADJUSTABLE WITH CONNECTED ELBOW										
			STOPS &	MCGUIRE	AND NIPPLE TO WALL, PVC.  STRAIGHT PATTERN, LOCK SHIELD CAP, LOOSE KEY HANDLE, 1/2" NPT INLET AND										
1	REFRIGERATOR	REFER TO ARCHITECTURAL	SUPPLIES	LFST12LK	OUTLET, POLISHED CHROME.  EQUIPMENT CONNECTION.							+			
.	FURNISHED BY OTHERS	DRAWINGS		<b>-</b> /			-	-	1/2"	3/8"	-				
			WALL BOX WITH SUPPLY	GUY GRAY MIBHAAB	METAL POWDER COATED WALL BOX, ANGLE PATTERN SUPPLY VALVE, 1/2" SWEAT INLET, 1/4 TURN, LEAD FREE, WITH HAMMER ARRESTOR.										
<del>-</del> -1	COFFEE MAKER	REFER TO ARCHITECTURAL	CLIDDLY		EQUIPMENT CONNECTION.	-	-	-	1/2"	3/8"					
	FURNISHED BY OTHERS	DRAWINGS	SUPPLY BACKFLOW	WATTS	ANGLE PATTERN SUPPLY VALVE, 1/2" SWEAT INLET, 1/4 TURN, LEAD FREE, WITH HAMMER ARRESTOR.  316 SS CONSTRUCTION, NPT CONNECTION, 200 PSIG, 110F, ASSE 1022, WITH STRAINER.										
1	JANITOR'S SINK	FIAT	PREVENTER	SD-3	FLOOR MOUNTED, STAIN RESISTANT, WHITE PRE-CAST TERRAZZO WITH STAINLESS							+-			
·	SAMITOR O OHAN	TSB3001			STEEL SPLASH PANELS AND STAINLESS STEEL CAP, 32' X 32' X 12" DEEP, INTEGRAL STAINLESS STEEL GRID STRAINER.	3"	1-1/2"	3"	3/4"	1/2"	3/4"	1			
			FAUCET	CHICAGO FAUCET 782-VBXKCCP	COMBINATION FAUCET MOUNTED 36" ABOVE FINISHED FLOOR, PAIL HOOK, 3/4" HOSE CONNECTION, TOP OR BOTTOM WALL BRACE, CONCEALED INTEGRAL STOPS, 8" CENTERS. VACUUM BREAKER SPOUT, POLISHED CHROME, CERAMIC CARTRIDGES.										
1			HOSE AND BRACKET	FIAT 832-AA	30" LONG, 5/8" RUBBER HOSE AND STAINLESS STEEL HOSE BRACKET. MOUNT BRACKET MINIMUM 18" ABOVE FINISHED FLOOR AND 6" LEFT OF FAUCET CENTER.										
			WALL GUARD	FIAT	TYPE 304 STAINLESS STEEL, 20 GAUGE, 12" HEIGHT.										
				MSG3624	ANTI-SIPHON, WALL MOUNTED, CONCEALED BOX TYPE, 3/4" THREADED CONNECTION.				3/4"	3/4"		+			
-1	HOSE RIRR	WOODFORD	N/∆ !	NI/A		I - '	_	_	.3721						
I-1	HOSE BIBB	WOODFORD B75	N/A	N/A	ASSE 1011 COMPLIANT, CHROME FINISH.	-	-	-	3/4"	3/4	-				

		FIXTURE TRIM							TIONS		
AG	TYPE	MANUFACTURER AND MODEL NUMBER	TYPE	MANUFACTURER AND MODEL NUMBER	DESCRIPTION	WASTE (CRW)		TRAP	COLD WATER (DCW)	HOT WATER (DHW)	DEIONIZEI WATER (DI)
K-1	LABORATORY BENCH DROP-IN SINK	REFER TO ARCHITECTURAL DRAWINGS	FAUCET	REFER TO ARCHITECTURAL DRAWINGS	LAB MIXING FAUCET						
	ADA		EYEWASH	REFER TO ARCHITECTURAL DRAWINGS	DECK MOUNTED	2"	1-1/2"	1-1/2"	1/2"	1/2"	
			DRAIN	ELKAY LK-99	STAINLESS STEEL BODY, 1-1/2" CHROME PLATED BRASS TAILPIECE, STAINLESS BASKET STRAINER, 3-1/2" OPENING.						
		I	TRAP		1-1/2" X 1-1/2" P-TRAP WITH CLEANOUT PLUG, ADJUSTABLE WITH CONNECTED ELBOW, POLYPROPYLENE.						
			STOPS & SUPPLIES	MCGUIRE LF2167CCLK	ANGLE PATTERN, LOCK SHIELD CAP, LOOSE KEY HANDLE, 1/2" NPT INLET X 1/2"  NPT OUTLET, POLISHED CHROME.						
K-2	LABORATORY BENCH	REFER TO ARCHITECTURAL	FAUCET	REFER TO ARCHITECTURAL	LAB MIXING FAUCET						
``-	DROP-IN SINK	DRAWINGS	1710021	DRAWINGS							
			DI FAUCET	REFER TO ARCHITECTURAL DRAWINGS	PURE WATER FAUCET	2"	1-1/2"	1-1/2"	1/2"	1/2"	1/2"
			DRAIN	ELKAY LK-99	STAINLESS STEEL BODY, 1-1/2" CHROME PLATED BRASS TAILPIECE, STAINLESS BASKET STRAINER, 3-1/2" OPENING.						
			TRAP		1-1/2" X 1-1/2" P-TRAP WITH CLEANOUT PLUG, ADJUSTABLE WITH CONNECTED ELBOW, POLYPROPYLENE.						
		1	STOPS &	MCGUIRE	ANGLE PATTERN, LOCK SHIELD CAP, LOOSE KEY HANDLE, 1/2" NPT INLET X 1/2"						
			SUPPLIES	LF2167CCLK	NPT OUTLET, POLISHED CHROME.						
K-3	LABORATORY BENCH UNDERMOUNT SINK	REFER TO ARCHITECTURAL DRAWINGS	FAUCET	REFER TO ARCHITECTURAL DRAWINGS	LAB MIXING FAUCET						
			DI FAUCET	REFER TO ARCHITECTURAL DRAWINGS	PURE WATER FAUCET	2"	1-1/2"	1-1/2"	1/2"	1/2"	1/2"
			DRAIN	ELKAY LK-99	STAINLESS STEEL BODY, 1-1/2" CHROME PLATED BRASS TAILPIECE, STAINLESS BASKET STRAINER, 3-1/2" OPENING.						
			TRAP		1-1/2" X 1-1/2" P-TRAP WITH CLEANOUT PLUG, ADJUSTABLE WITH CONNECTED ELBOW, POLYPROPYLENE.						
			STOPS &	MCGUIRE	ANGLE PATTERN, LOCK SHIELD CAP, LOOSE KEY HANDLE, 1/2" NPT INLET X 1/2"	$\neg$					
			SUPPLIES	LF2167CCLK	NPT OUTLET, POLISHED CHROME.						
<-4	LABORATORY BENCH	REFER TO ARCHITECTURAL	FAUCET	REFER TO ARCHITECTURAL	PRE-RINSE UNIT						
	UNDERMOUN SINK	DRAWINGS		DRAWINGS							
	WITH DRAINBOARD		FAUCET	REFER TO ARCHITECTURAL DRAWINGS	GOOSENECK FAUCET AND FOOT OPERATED VALVE	2"	1-1/2"	1-1/2"	1/2"	1/2"	
			DRAIN	ELKAY LK-99	STAINLESS STEEL BODY, 1-1/2" CHROME PLATED BRASS TAILPIECE, STAINLESS BASKET STRAINER, 3-1/2" OPENING.						
			TRAP		1-1/2" X 1-1/2" P-TRAP WITH CLEANOUT PLUG, ADJUSTABLE WITH CONNECTED ELBOW, POLYPROPYLENE.						
			STOPS &	MCGUIRE	ANGLE PATTERN, LOCK SHIELD CAP, LOOSE KEY HANDLE, 1/2" NPT INLET X 1/2"	$\exists$					
			SUPPLIES	LF2167CCLK	NPT OUTLET, POLISHED CHROME.						
IP-1	DI POLISHER (OFOI)	REFER TO ARCHITECTURAL DRAWINGS	N/A	N/A	EQUIPMENT CONNECTION. TERMINATE WITH BALL VALVE AND CAP.						1/2"

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PLUMBING SCHEDULES

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